COUNTYOF **SAN MATEO** PLANNING AND BUILDING

County Government Center 455 County Center, 2nd Floor Redwood City, CA 94063 650-363-4161 T 650-363-4849 F www.planning.smcgov.org

July 22, 2019

Kerry Burke PO Box 779 Half Moon Bay, CA 94019

Dear Ms. Burke:

SUBJECT: Coastside Design Review Continuance

Hermosa Avenue, Miramar

APN 048-065-190; County File No. PLN 2019-00060

At its meeting of July 11, 2019, the San Mateo County Coastside Design Review Committee (CDRC) considered your application for a Design Review Permit to allow construction of a new two-story 2,675 sq. ft. single-family residence, plus a 429 sq. ft. attached two-car garage, and a 650 sq. ft. Accessory Dwelling Unit (ADU) on a 20,012 sq. ft. legal parcel (per Lot Line Adjustment: LLA92-0016). The property would be accessed via a 100-foot long new driveway from an existing improved portion of Hermosa Avenue. No significant tree removal and only minor grading is proposed. The project scope includes the removal of a portion of an arroyo willow thicket to accommodate the proposed development. The ADU is a ministerial project that does not require review by the CDRC. This project qualifies for a Coastal Development Permit Exemption and is not appealable to the California Coastal Commission.

The CDRC was unable to make the findings for a design review approval based on certain design deficiencies. In order to resolve these deficiencies in the project's design, a more thorough review of the Local Coastal Program and "Standards for Design for One-Family and Two-Family Residential Development in the Midcoast" manual is required. As such, requirements from the CDRC for further project redesign are as follows:

1. Recommendations Discussed Include:

- a. Reposition the primary residence to match the plans reviewed at the June 13, 2019 CDRC meeting (10 feet between the primary residence and garage).
- b. Provide a color scheme with actual material and paint samples for all siding and roof materials.
- c. Provide a rendering of the project as seen from Alto Avenue with reduced vegetation as proposed for accurate project visibility. Renderings are to be posted 10 calendar days prior to the date of the CDRC meeting on which this project will be reviewed.

As such, you were presented with the following available options at the end of the CDRC's deliberation of the project: (i) request for a decision from the CDRC on the plans presented or (ii) request that the project be considered at the next meeting to provide you with ample time to consider and incorporate the elements recommended for project redesign. You chose the second option, and the CDRC directed staff to schedule your project for consideration at a later date.

Please contact Ruemel Panglao, Project Planner, at 650/363-4825 or rpanglao@smcgov.org, if you have any questions.

To provide feedback, please visit the Department's Customer Survey at the following link: http://planning.smcgov.org/survey.

Sincerely

Dennis P. Aguirre
Design Review Officer

DPA:RSP:cmc - RSPDD0360_WCN.DOCX

cc: Randy Ralston and Linda Mendiola, Owners

Bruce Chan, Member Landscape Architect

Kayleen Kostuik, Member Architect

Linda Montalto Patterson, Miramar Community Representative

Kerry Burke, Applicant

Erik Martinez, California Coastal Commission

Lennie Roberts. Committee for Green Foothills

Ken King, Sierra Club

Mike Ferreira, Sierra Club

Christine Drost-Hansen, Interested Member of the Public

Cathy Campbell, Interested Member of the Public

Lisa Ryan, Interested Member of the Public

Rose Tribble, Interested Member of the Public

Anne Martin, Interested Member of the Public

Envelopes:

Randy Ralston and Linda Mendiola 385 Miramar Drive Half Moon Bay, CA 94019

Erik Martinez 45 Fremont Street, Suite 2000 San Francisco CA 94105

Lennie Roberts 3921 E. Bayshore Road Palo Alto, CA 94303

Ken King 3921 East Bayshore Road Palo Alto, CA 94303

Mike Ferreira 3921 East Bayshore Road Palo Alto, CA 94303


Christine Drost-Hansen 569 Alto Avenue Half Moon Bay, CA 94019

Cathy Campbell 555 Hermosa Avenue Half Moon Bay, CA 94019

Lisa Ryan 548 Hermosa Avenue Half Moon Bay, CA 94019

Rose Tribble 548 Hermosa Avenue Half Moon Bay, CA 94019

Anne Martin 620 Miramar Drive Half Moon Bay, CA 94019

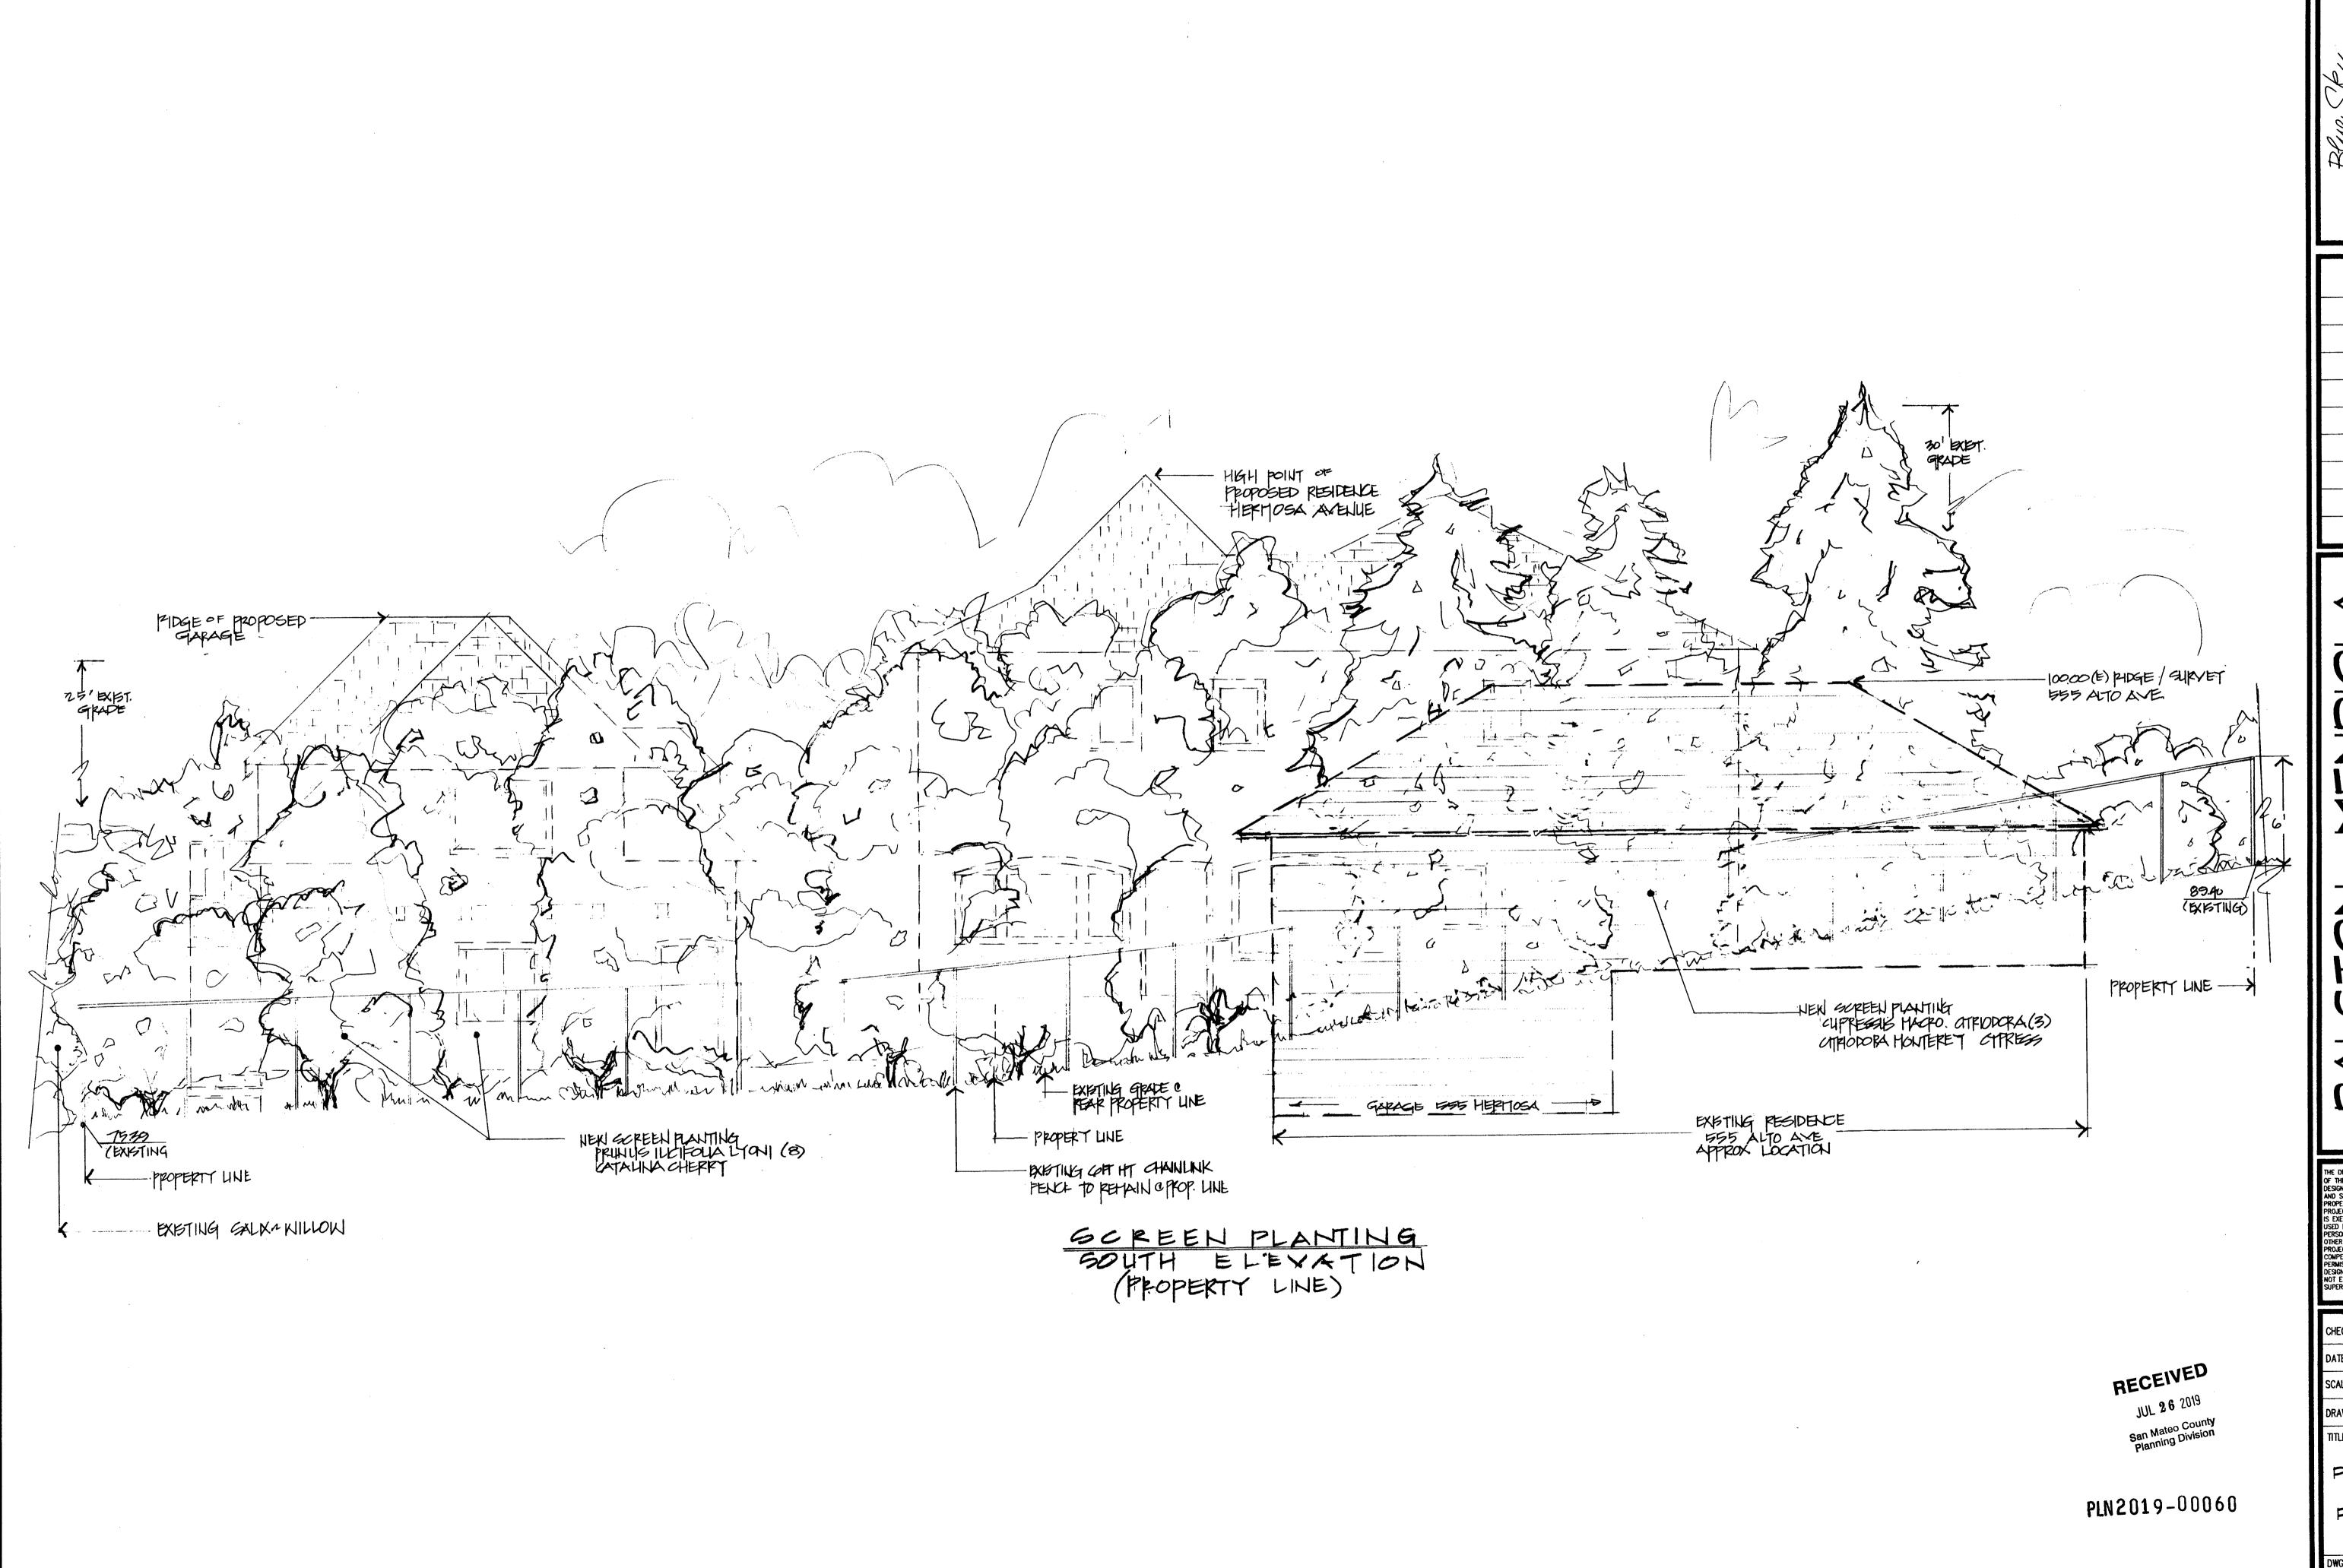

DESIGNS, INC.

CUSTOM LANDSCAPE ENVIRONMENTS

LANDSCAPE CONTRACTOR'S LICENSE #C27-436094

GENERAL CONTRACTOR'S LICENSE #B-436094

LANDSCAPE ARCHITECT'S LICENSE #LA-4205

495 PURISIMA WAY, HALF MOON BAY, CA 94019

(650) 726-5990 FAX (650) 726-2353

REVISION	S
DATE	BY

ON - MENDE OLA

ERMOSA AVENUE

THE DRAWINGS ON THIS SHEET (OR COPIES OF THEM, HOWEVER EXECUTED) AND THE DESIGN CONCEPTS CONVEYED BY THEM ARE AND SHALL REMAIN THE EXCLUSINE PROPERTY OF THE DESIGNER WHETHER THE PROJECT FOR WHICH THEY WERE CREATED IS EXECUTED OR NOT. THEY MAY NOT BE USED IN WHOLE OR IN PART BY ANY PERSON OR BUSINESS ENTITY OR ANY OTHER PROJECT NOR EXTENSIONS OF THIS PROJECT WITHOUT APPROPRIATE COMPENSATION TO, AND WRITTEN PERMISSION FROM THE DESIGNER. THE DESIGNER ASSUMES NO LIABILITY FOR IDEAS NOT EXECUTED BY, OR UNDER THE DIRECT SUPERVISION OF, BLUE SKY DESIGNS, INC.

CHECKED	K.C.
DATE	7/26/19
SCALE	1/4" = 1'-0"
DRAWN	K.C.
TITLE	


SCREEN
PLANTINGS
SOUTH
PROPERTY
LINE

DWG. NO.

SHEET 1 OF 1

JOBRALSTON-MENDIOLA

APN: 048-065-190

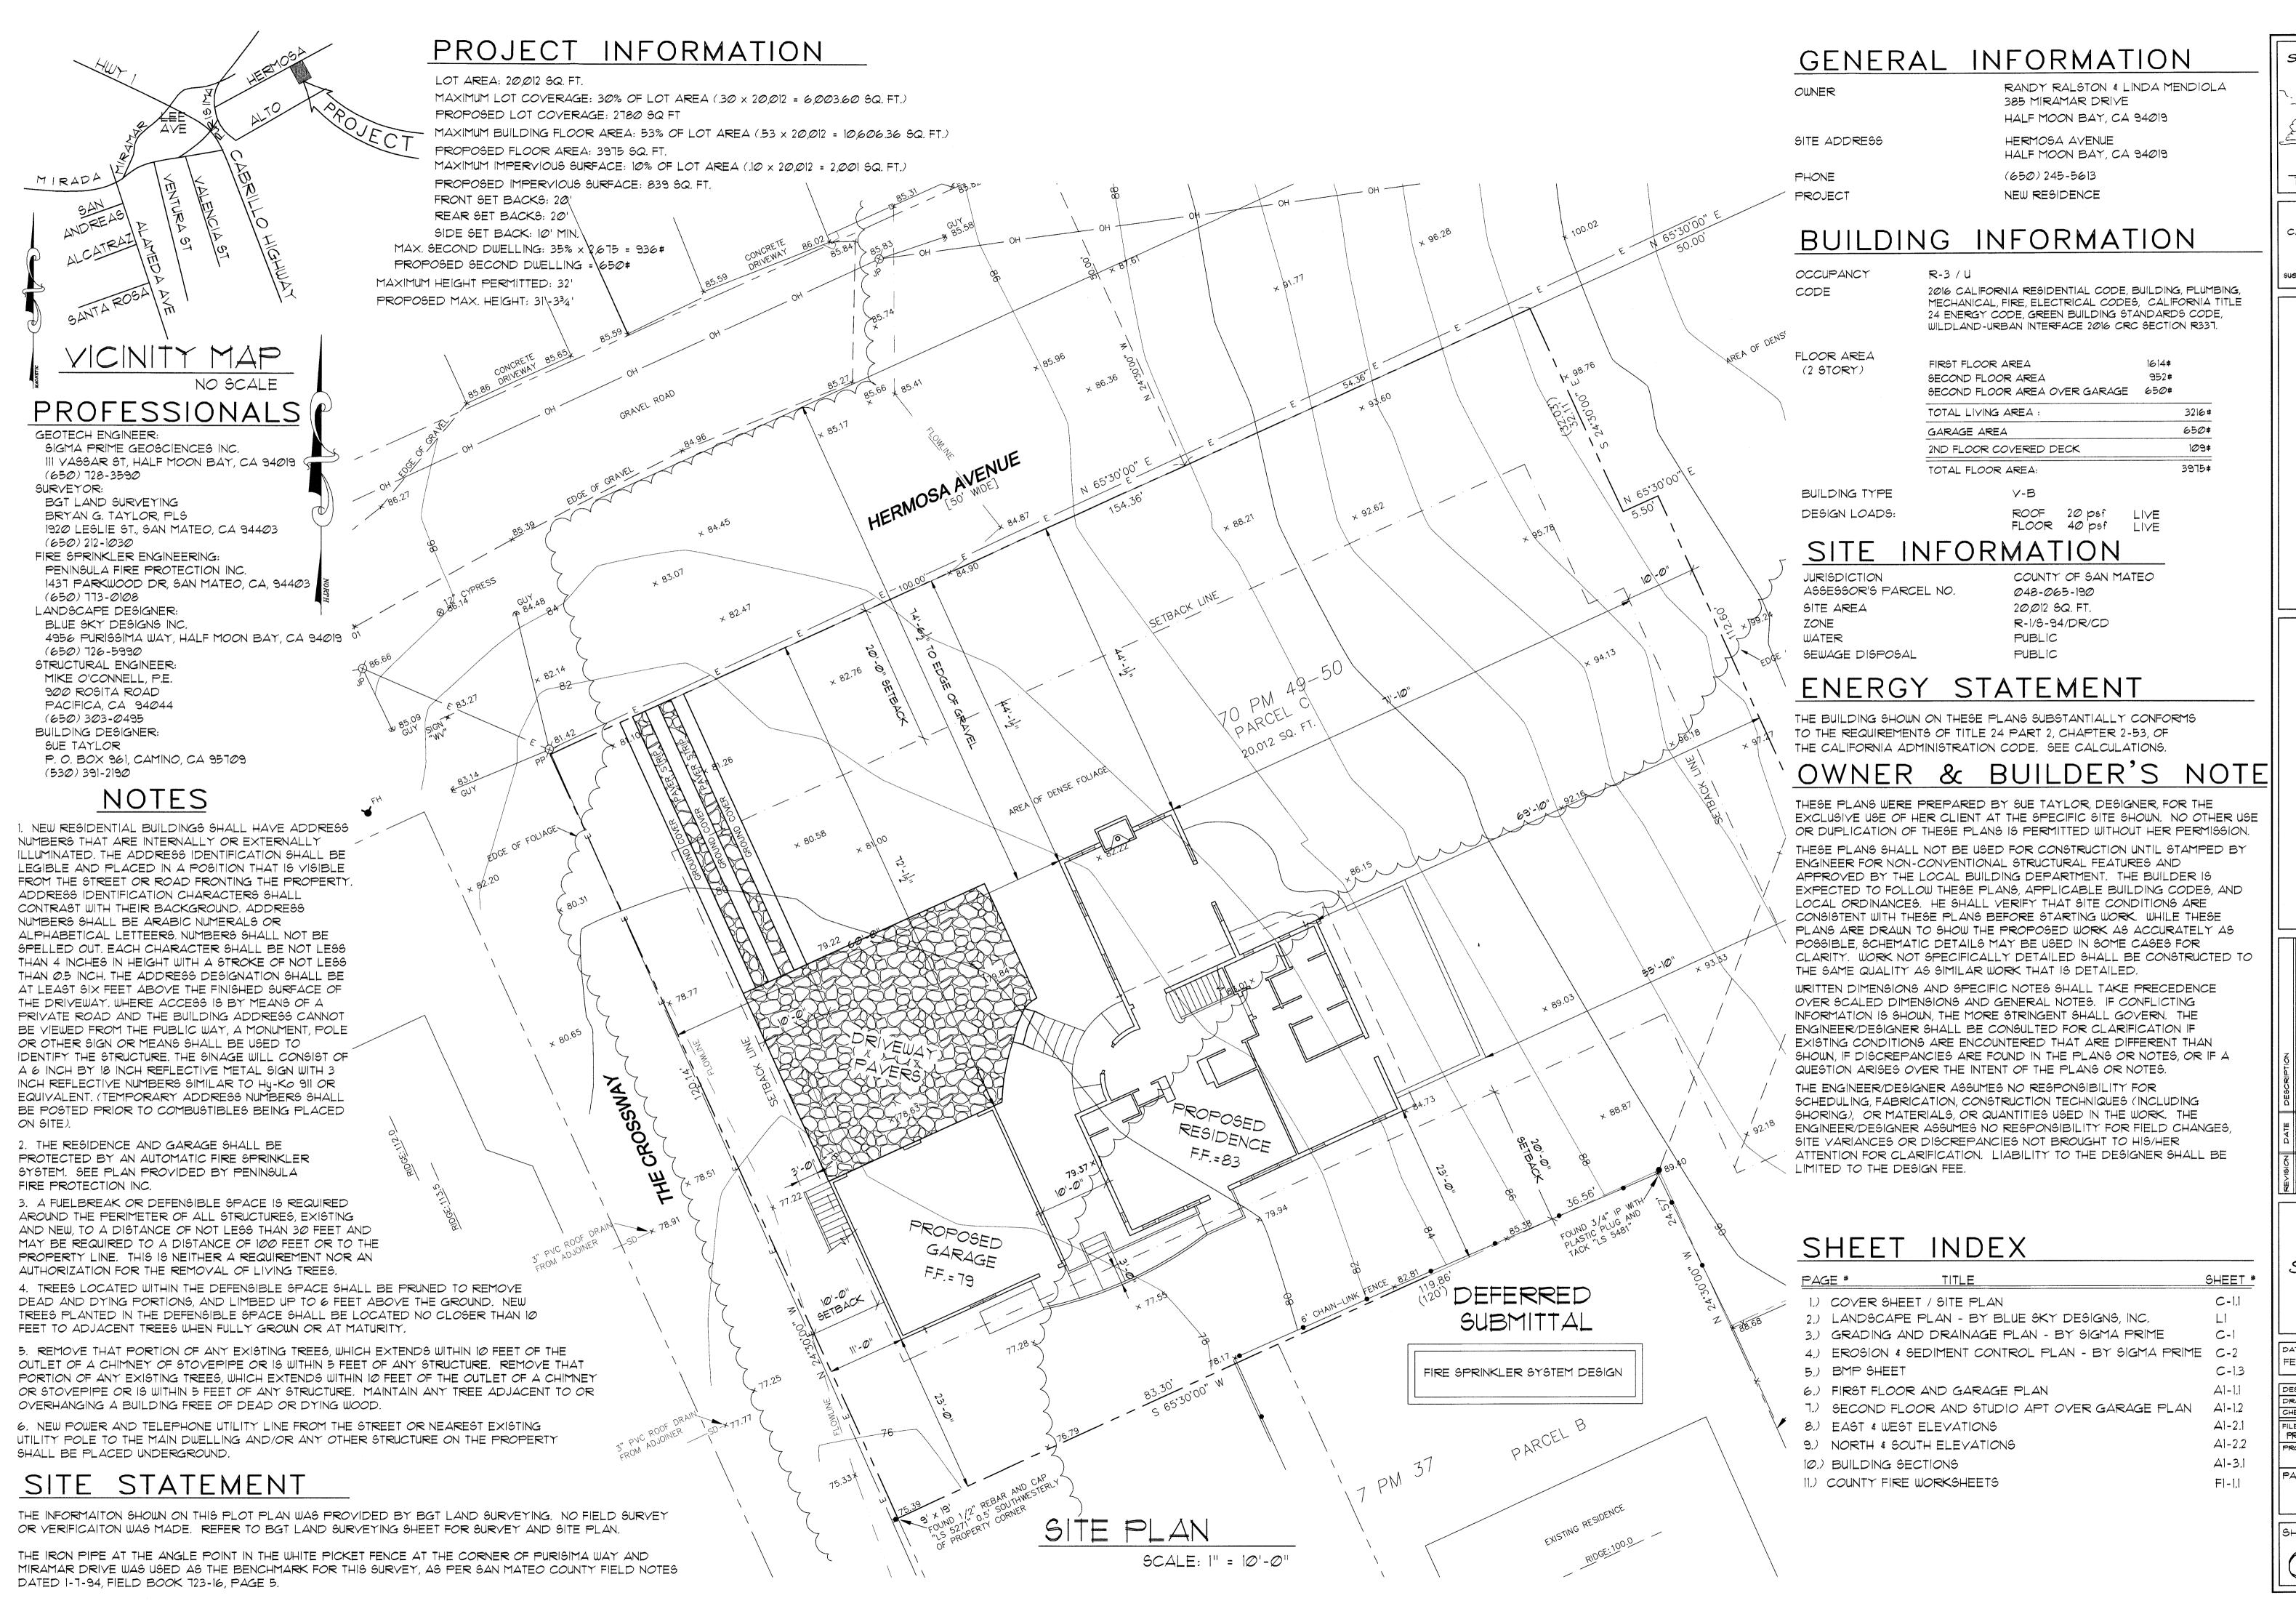

SUE TAYLOR
DESIGN

SUE TAYLOR

P.O. BOX 961 CAMINO, CA 95709 (530) 391-2190

THE RESIDENCE OF THE RESIDENCE OF THE PLAN

RANDY RALSTON & LINDA MENDIOL,
HERMOSA AVENUE
HALF MOON BAY, CA 94019

REVISION DATE DESCRIPTION

1 4-2-19 REVISIONS PER COUNTY FIRE 3-3-19
2 6-21-19 REVISIONS PER DESIGN REVIEW 6-13-19
3 1-24-19 REVISIONS PER DESIGN REVIEW 1-11-19

FEBRUARY 01, 2019

DESIGNED BY: SRT

DRAWN BY: SRT

CHECKED BY: SRT

FILE *

PROJECTS/2018/007/007C11


PROJECT *

18007

PAGE OF

SHEET NO.

= 1,1

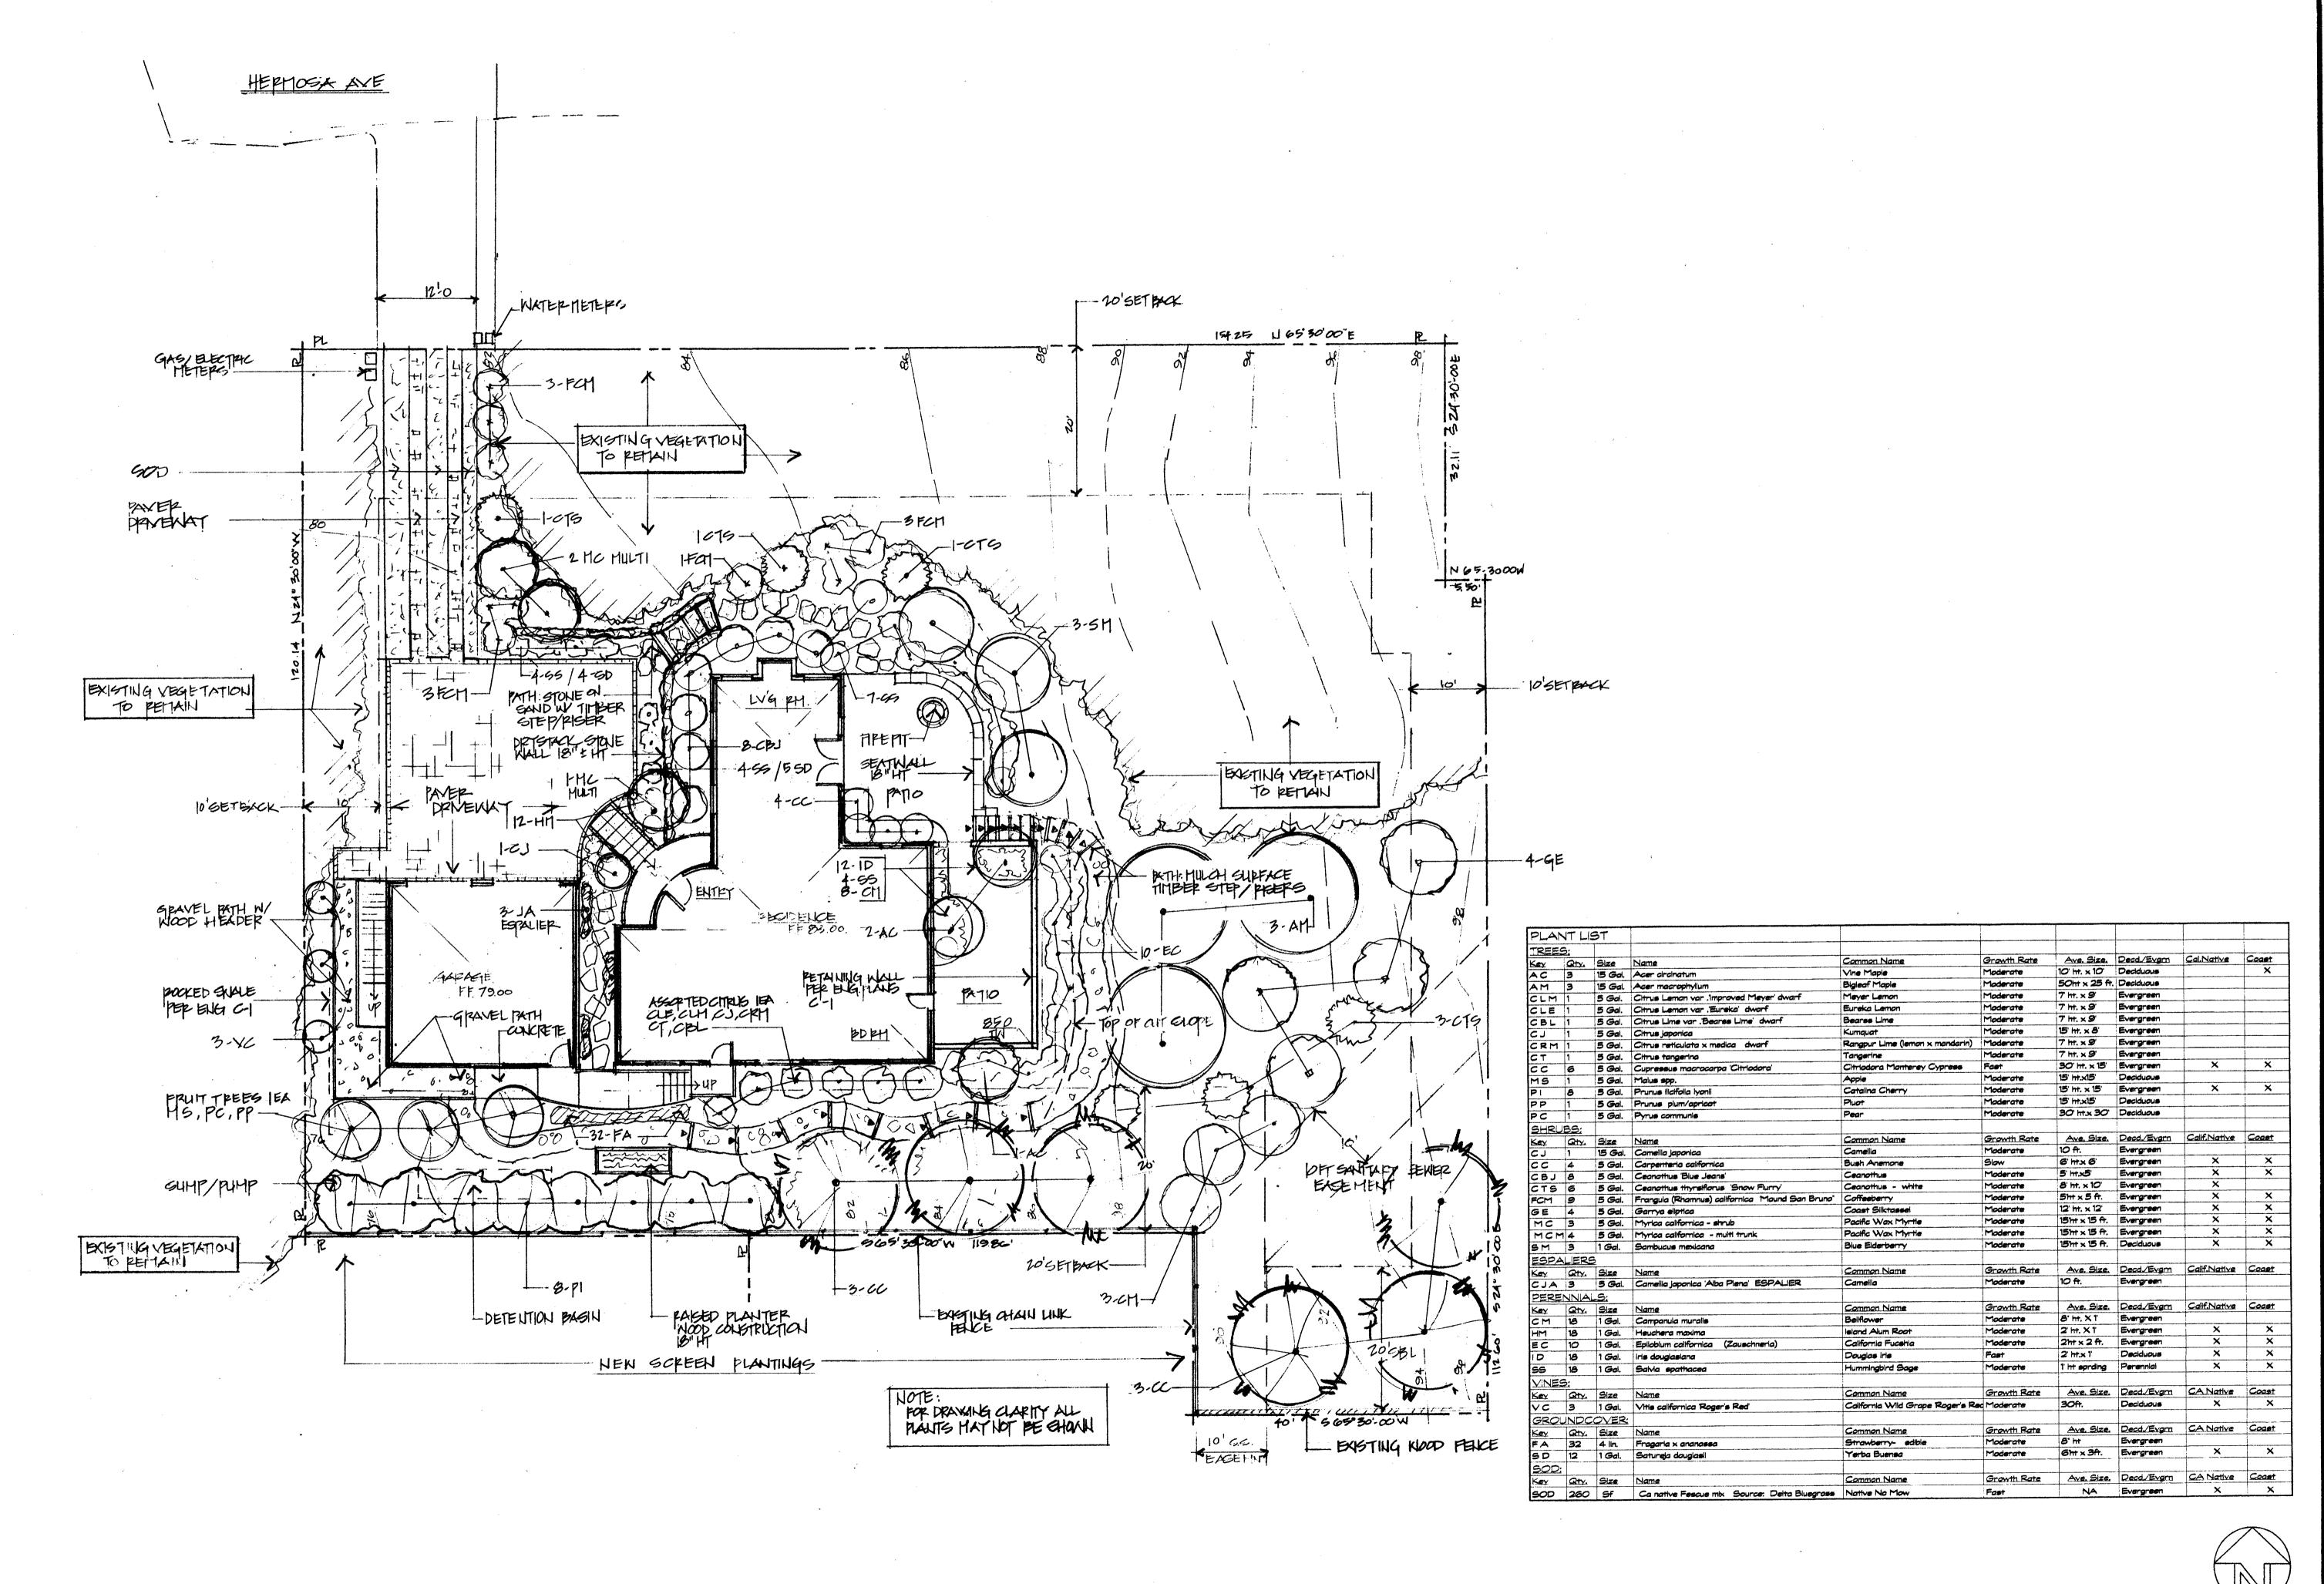

THE DRAWINGS ON THIS SHEET (OR COPIES OF THEM, HOWEVER EXECUTED) AND THE DESIGN CONCEPTS CONVEYED BY THEM ARE AND SHALL REMAIN THE EXCLUSIVE PROPERTY OF THE DESIGNER WHETHER THE PROJECT FOR WHICH THEY MAY NOT BE USED IN WHICHE OR IN PART BY ANY PERSON OR BUSINESS ENTITY OR ANY OTHER PROJECT NOR EXTENSIONS OF THIS PROJECT WITHOUT APPROPRIATE COMPENSATION TO, AND WRITTEN PERMISSION FROM THE DESIGNER. THE DESIGNER ASSUMES NO LIABILITY FOR IDEAS NOT EXECUTED BY, OR UNDER THE DIRECT SUPERVISION OF, BLUE SKY DESIGNS, INC. CHECKED DATE 6/20/19

REVISIONS

DATE


SCALE 1" = 10'-0" K.C. DRAWN TITLE LANDSCAPE


PLAN

SHEET 1 OF 1 "RALSTON-MENDIOLA

DWG. NO.

APN: 048-065-190

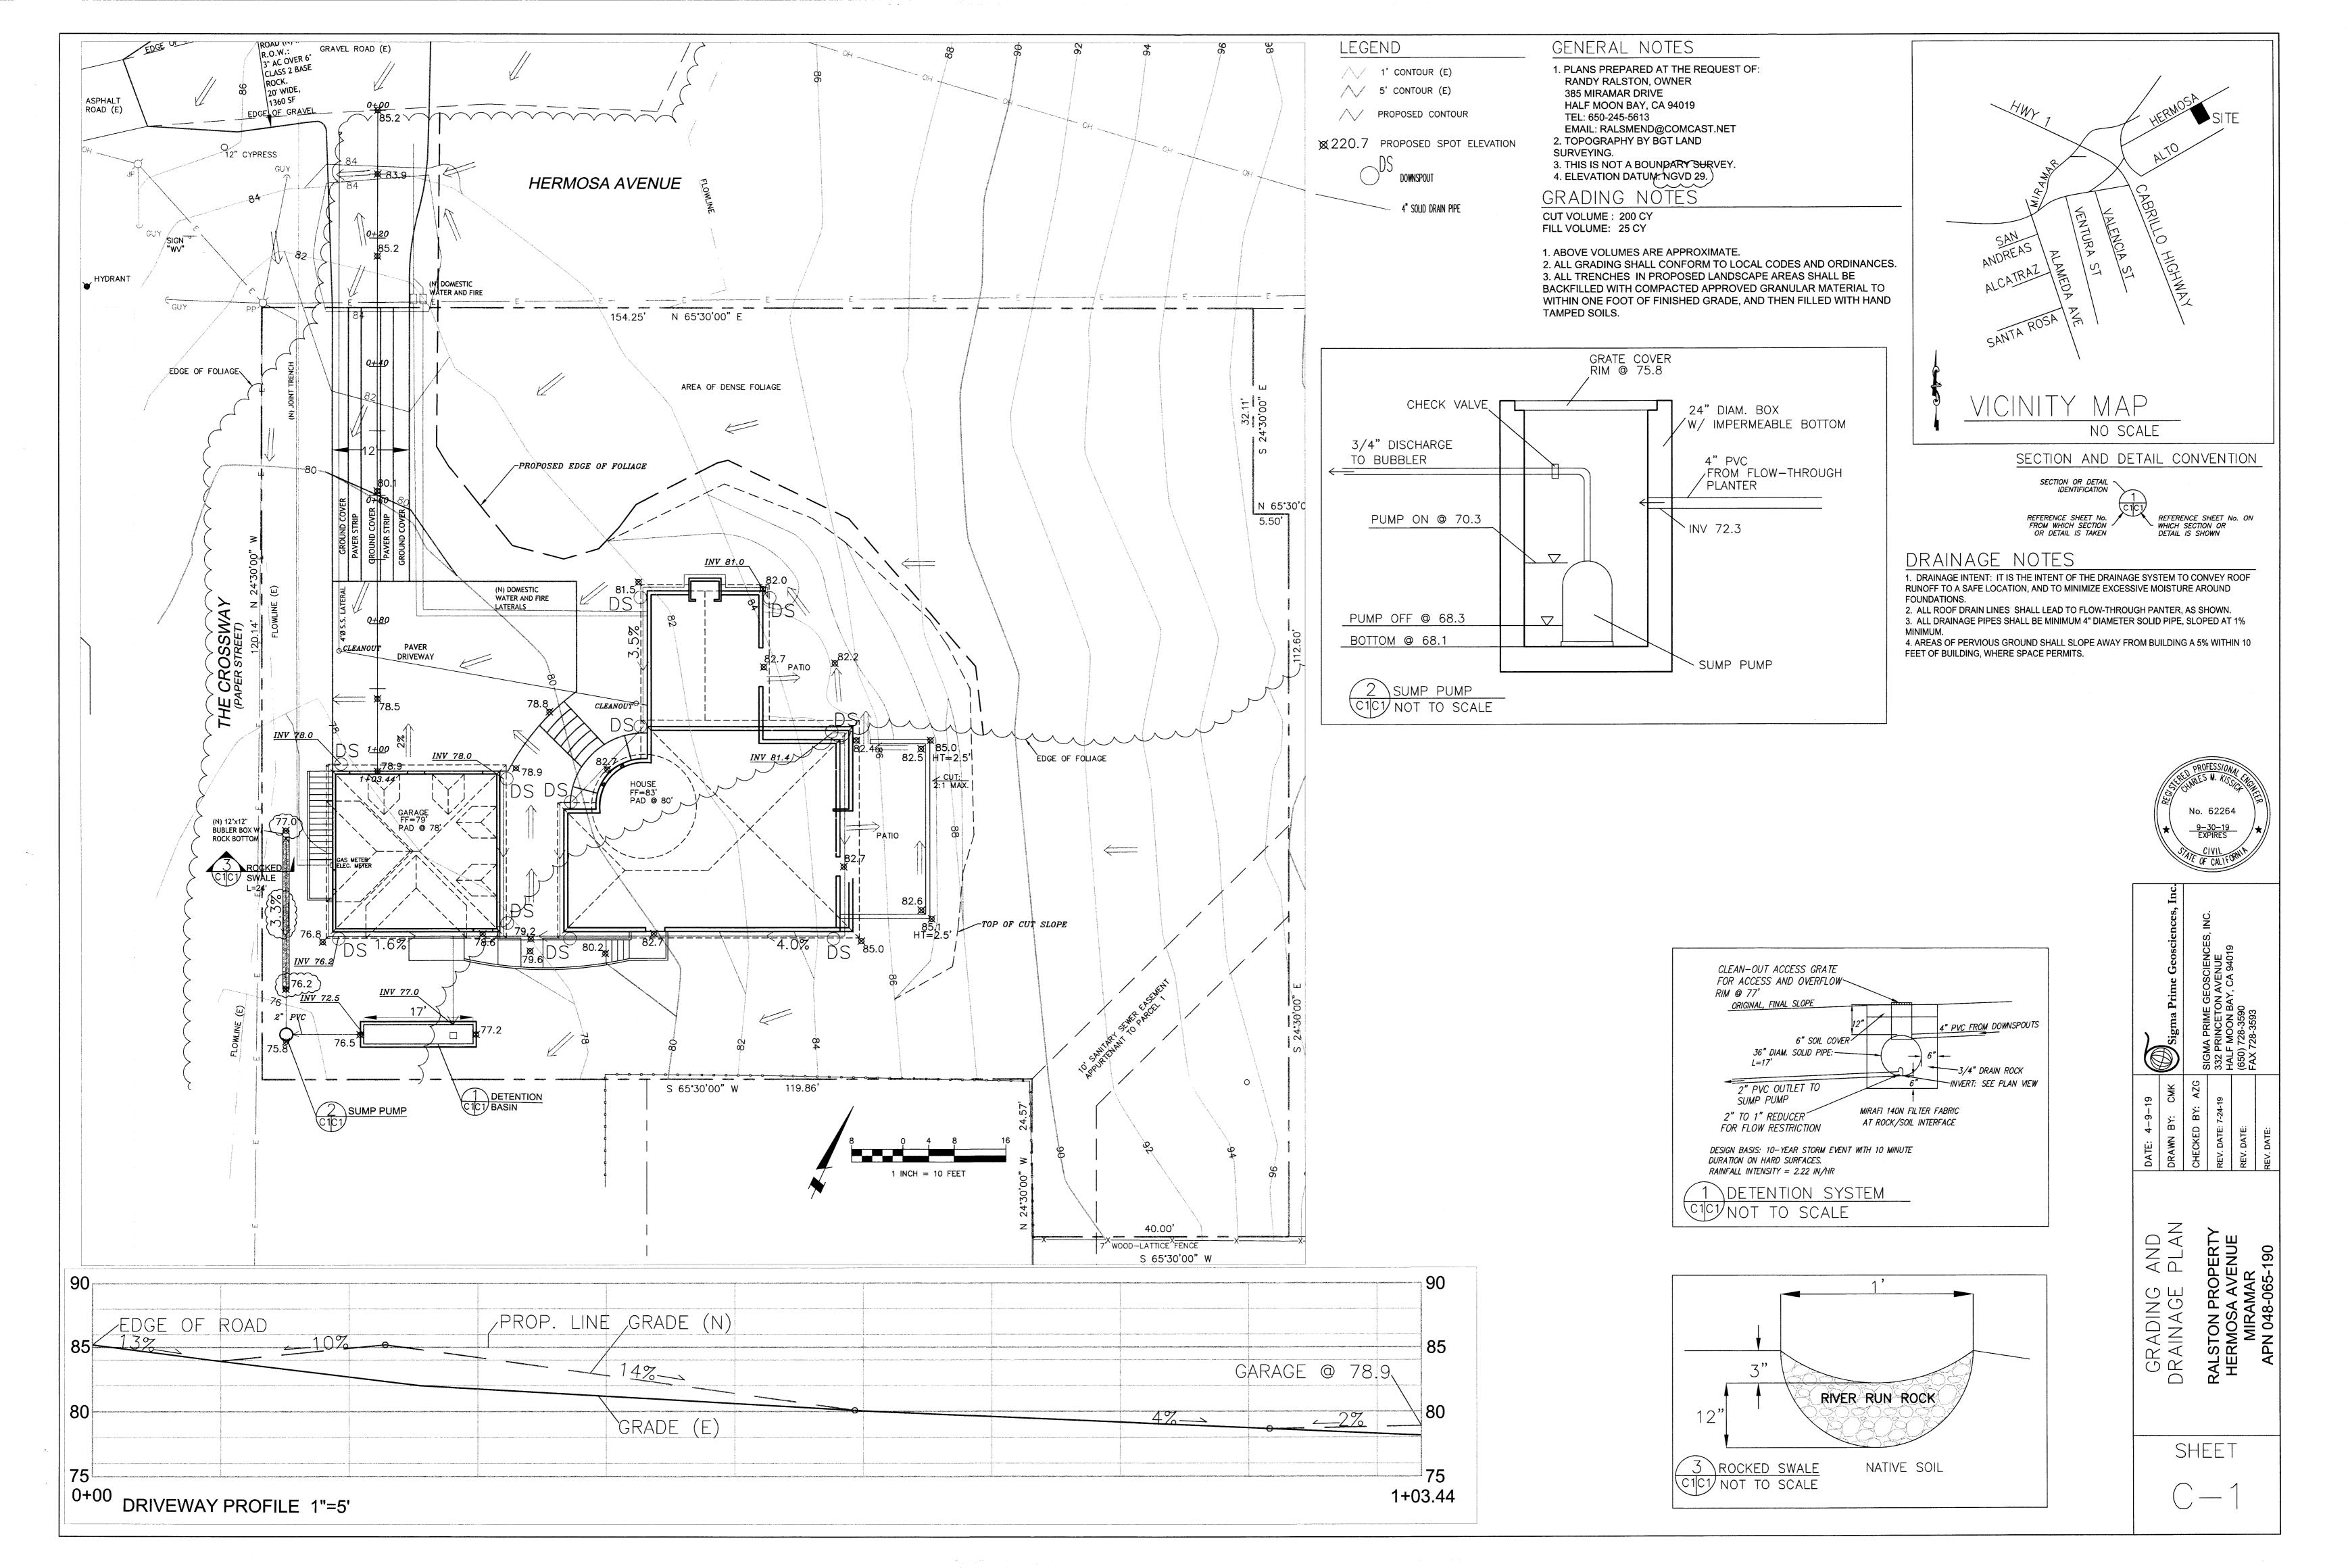

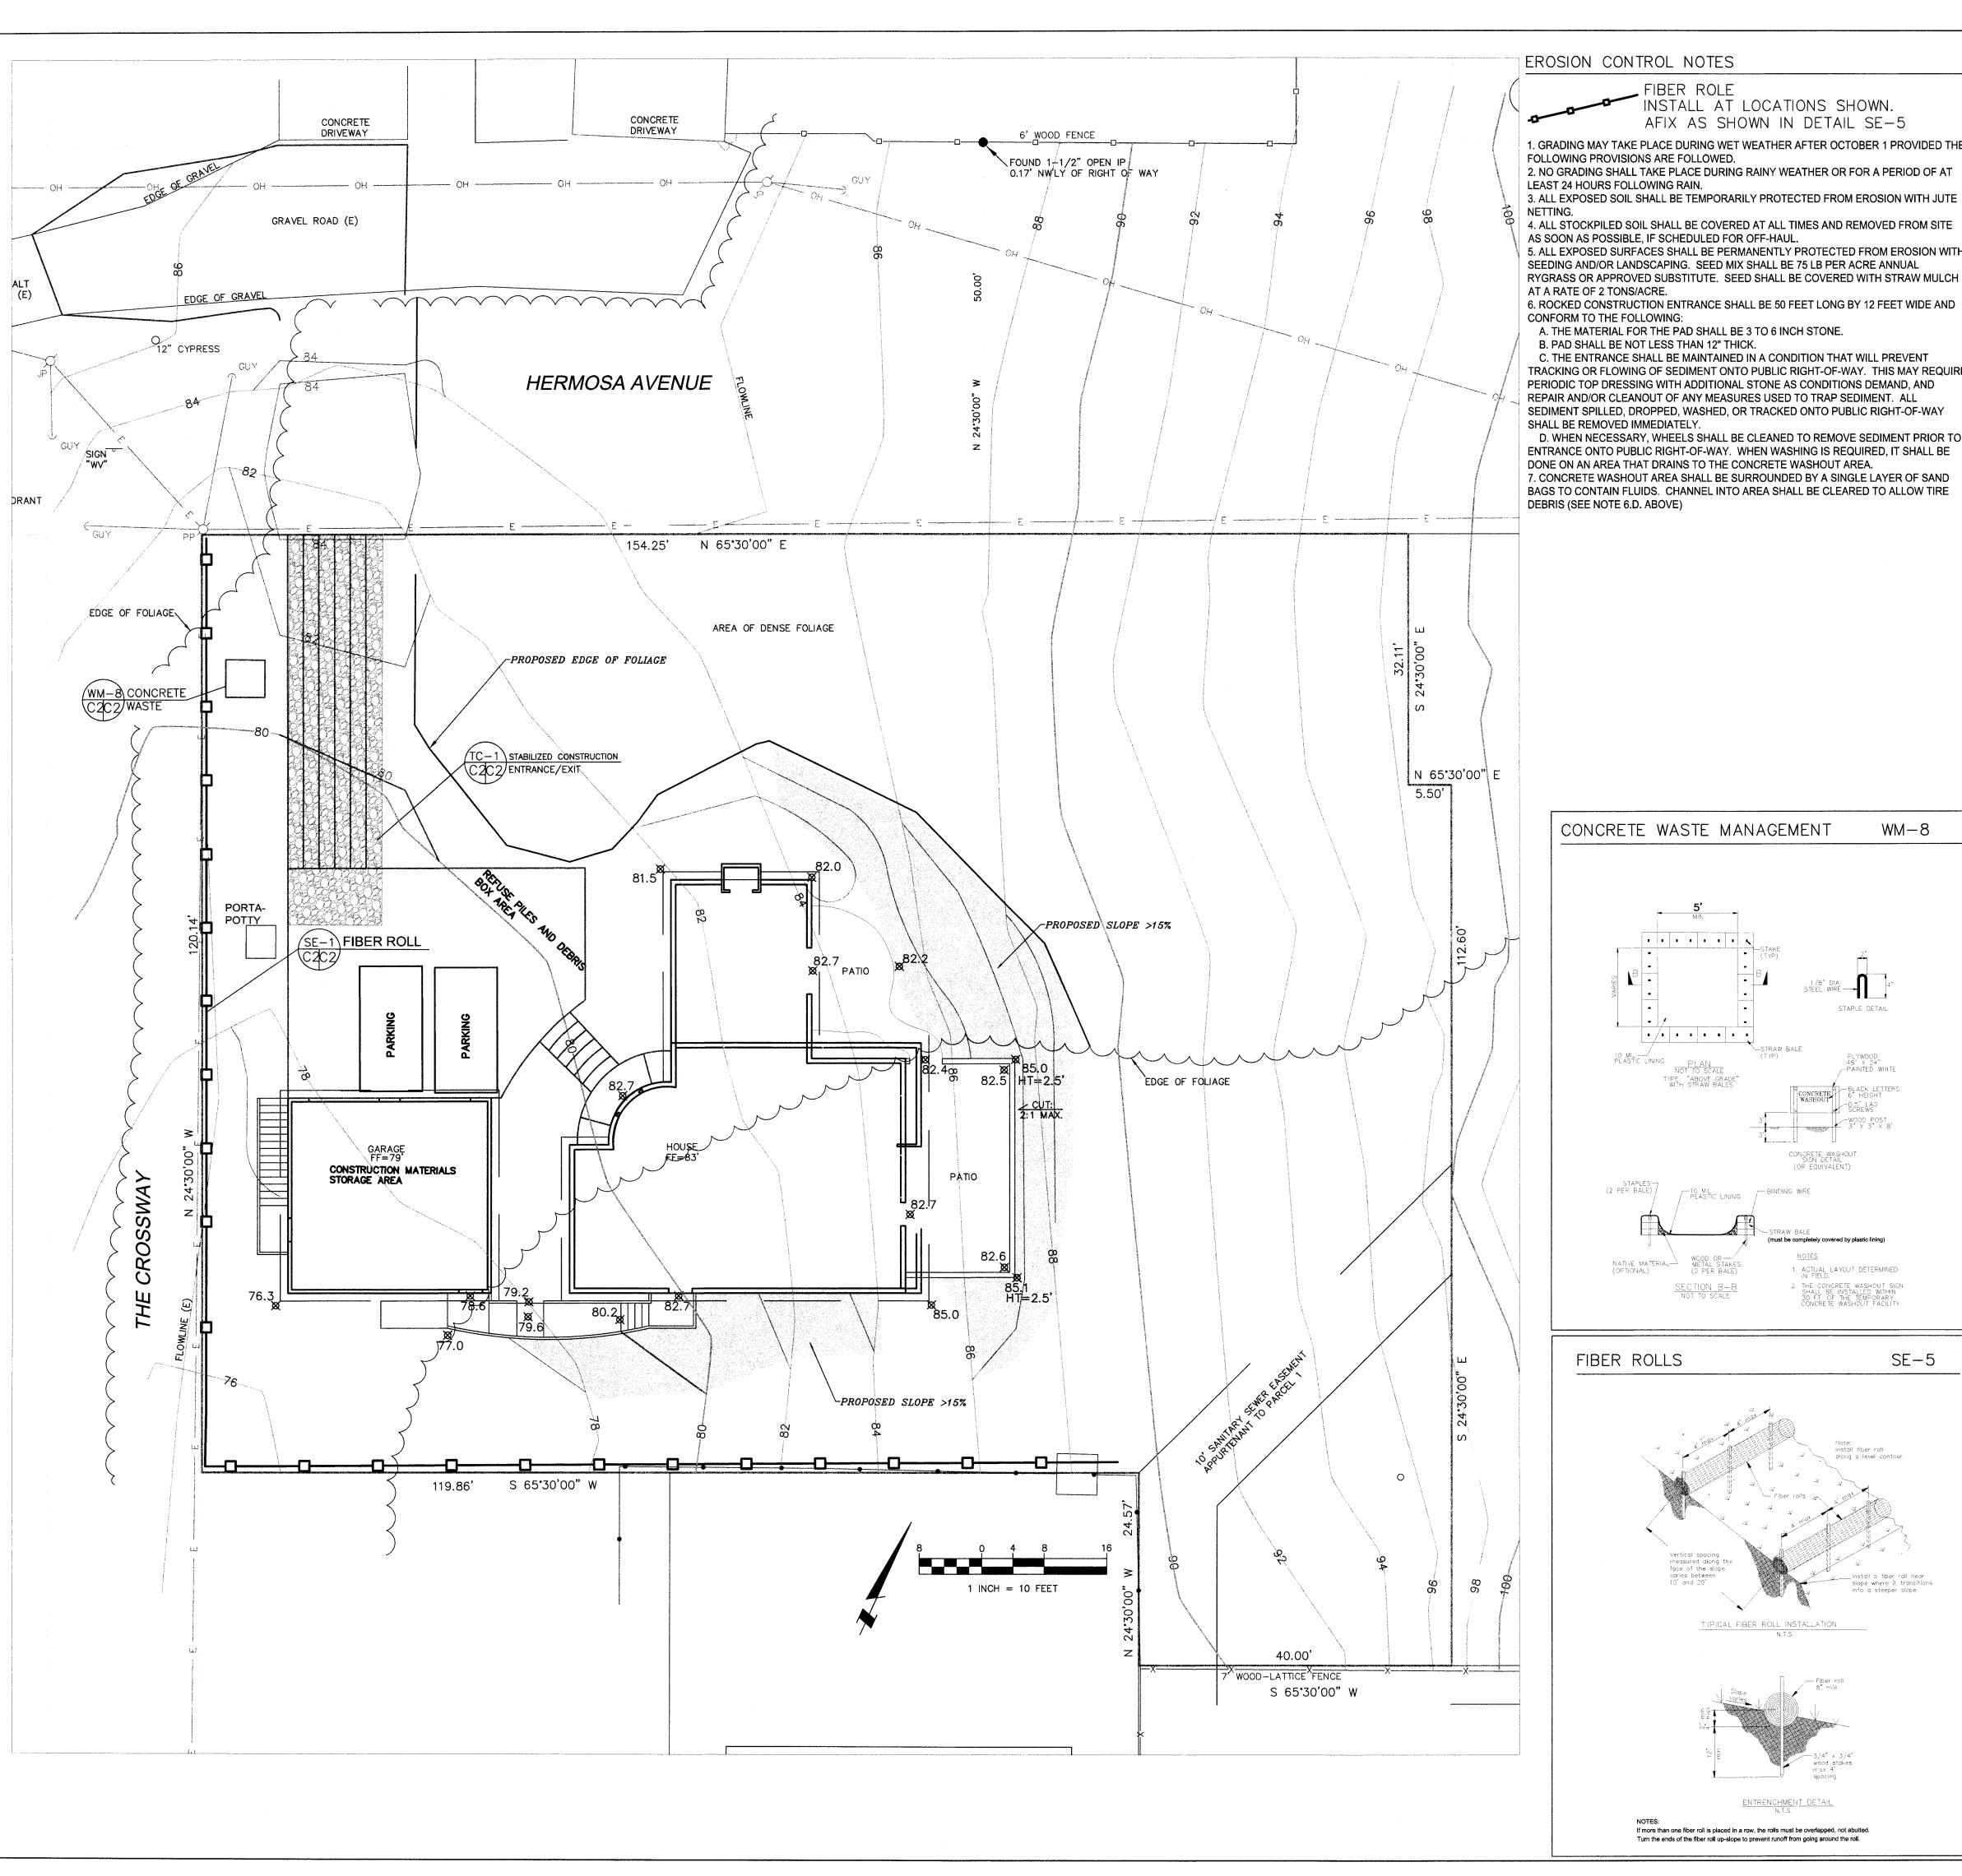

EROSION CONTROL NOTES

FIBER ROLE INSTALL AT LOCATIONS SHOWN. AFIX AS SHOWN IN DETAIL SE-5

FOLLOWING PROVISIONS ARE FOLLOWED. 2. NO GRADING SHALL TAKE PLACE DURING RAINY WEATHER OR FOR A PERIOD OF AT

LEAST 24 HOURS FOLLOWING RAIN. 3. ALL EXPOSED SOIL SHALL BE TEMPORARILY PROTECTED FROM EROSION WITH JUTE

4. ALL STOCKPILED SOIL SHALL BE COVERED AT ALL TIMES AND REMOVED FROM SITE AS SOON AS POSSIBLE, IF SCHEDULED FOR OFF-HAUL. 5. ALL EXPOSED SURFACES SHALL BE PERMANENTLY PROTECTED FROM EROSION WITH

AT A RATE OF 2 TONS/ACRE. 6. ROCKED CONSTRUCTION ENTRANCE SHALL BE 50 FEET LONG BY 12 FEET WIDE AND CONFORM TO THE FOLLOWING:

A. THE MATERIAL FOR THE PAD SHALL BE 3 TO 6 INCH STONE.

B. PAD SHALL BE NOT LESS THAN 12" THICK.

.

| • /• | • • | • • | • • |

C. THE ENTRANCE SHALL BE MAINTAINED IN A CONDITION THAT WILL PREVENT TRACKING OR FLOWING OF SEDIMENT ONTO PUBLIC RIGHT-OF-WAY. THIS MAY REQUIRE PERIODIC TOP DRESSING WITH ADDITIONAL STONE AS CONDITIONS DEMAND, AND REPAIR AND/OR CLEANOUT OF ANY MEASURES USED TO TRAP SEDIMENT. ALL SEDIMENT SPILLED, DROPPED, WASHED, OR TRACKED ONTO PUBLIC RIGHT-OF-WAY

D. WHEN NECESSARY, WHEELS SHALL BE CLEANED TO REMOVE SEDIMENT PRIOR TO ENTRANCE ONTO PUBLIC RIGHT-OF-WAY. WHEN WASHING IS REQUIRED, IT SHALL BE DONE ON AN AREA THAT DRAINS TO THE CONCRETE WASHOUT AREA. 7. CONCRETE WASHOUT AREA SHALL BE SURROUNDED BY A SINGLE LAYER OF SAND BAGS TO CONTAIN FLUIDS. CHANNEL INTO AREA SHALL BE CLEARED TO ALLOW TIRE DEBRIS (SEE NOTE 6.D. ABOVE)

1. GRADING MAY TAKE PLACE DURING WET WEATHER AFTER OCTOBER 1 PROVIDED THE

8-MW

1/8" DIA. STEEL WIRE ————————4"

(must be completely covered by plastic lining)

TYPICAL FIBER ROLL INSTALLATION N.T.S.

ENTRENCHMENT DETAIL

If more than one fiber roll is placed in a row, the rolls must be overlapped, not abutted.

1. ACTUAL LAYOUT DETERMINED IN FIELD.

THE CONCRETE WASHOUT SIGN SHALL BE INSTALLED WITHIN 30 FT. OF THE TEMPORARY CONCRETE WASHOUT FACILITY.

SE-5

- There will be no stockpiling of soil. All excavated soil will be hauled off-site as it is excavated.
- Perform clearing and earth-moving activities only during dry weather. Measures to ensure adequate erosion and sediment control shall be installed prior to earth-moving activities and construction.

GENERAL EROSION AND SEDIMENT CONTROL NOTES

- · Erosion control materials to be on-site during off-season.
- Measures to ensure adequate erosion and sediment control are required year-round. Stabilize all denuded areas and maintain erosion control measures continuously between October 1 and April 30.
- Store, handle, and dispose of construction materials and wastes properly, so as to prevent their contact with stormwater.
- · Control and prevent the discharge of all potential pollutants, including pavement cutting wastes, paints, concrete, petroleum products, chemicals, wash water or sediments, and non-stormwater discharges to storm drains and watercourses.
- Avoid cleaning, fueling, or maintaining vehicles on-site, except in a designated area where wash water is contained and treated.
- · Limit and time applications of pesticides and fertilizers to prevent polluted runoff.
- · Limit construction access routes to stabilized, designated access points
- · Avoid tracking dirt or other materials off-site; clean off-site paved areas and sidewalks using dry sweeping methods.
- · Train and provide instruction to all employees and subcontractors regarding the Watershed Protection Maintenance Standards and construction Best Management Practices.
- · Placement of erosion materials is required on weekends and during rain events.
- The areas delineated on the plans for parking, grubbing, storage etc., shall not be enlarged or "run over."
- Dust control is required year-round.
- · Erosion control materials shall be stored on-site
- The tree protection shall be in place before any grading, excavating or grubbing is started.


EROSION CONTROL POINT OF CONTACT

THIS PERSON WILL BE RESPONSIBLE FOR EROSION CONTROL AT THE SITE AND WILL BE THE COUNTY'S MAIN POINT OF CONTACT IF CORRECTIONS ARE REQUIRED.

NAME: RANDY RALSTON TITLE/QUALIFICATION: OWNER/CONTRACTOR E-MAIL: RALSMEND@COMCAST.NET



E: 2–11–19	
WN BY: CMK	Sigma Prime Geosciences, Inc.
CKED BY: AZG	SIGMA BBIME GEOSCIENCES INC
DATE: 7-24-19	DATE: 7-24-19 332 PRINCETON AVENUE HAI F MOON RAY CA 94019
DATE:	(650) 728-3590 FAX 728-3593
)ATF:	

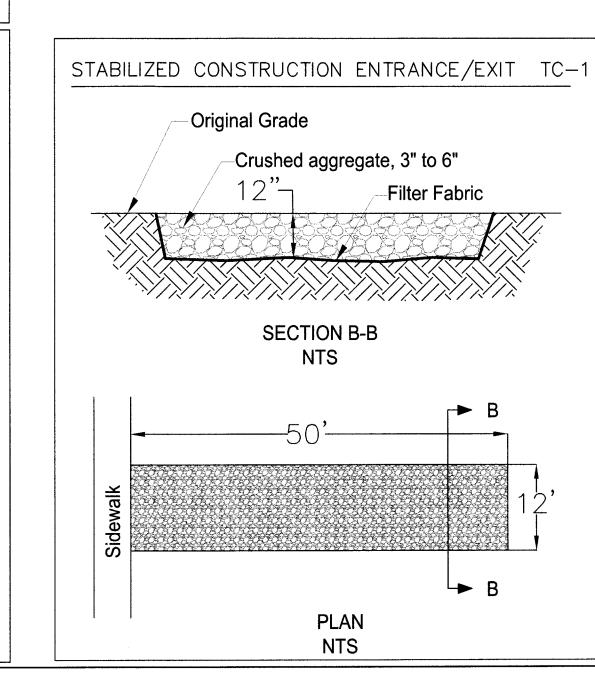

DAIE: 2-11	DRAWN BY:	CHECKED B	REV. DATE: 7	REV. DATE:	REV. DATE:
	EKOSION AND SEDIMENI		RALSTON PROPERTY	HERMOSA AVENUE	APN 048-065-190
		SHE	E	T	
		<u> </u>	-	\bigcirc	




Construction Best Management Practices (BMPs)

Construction projects are required to implement the stormwater best management practices (BMP) on this page, as they apply to your project, all year long.

Clean Water. Healthy Community.

Materials & Waste Management

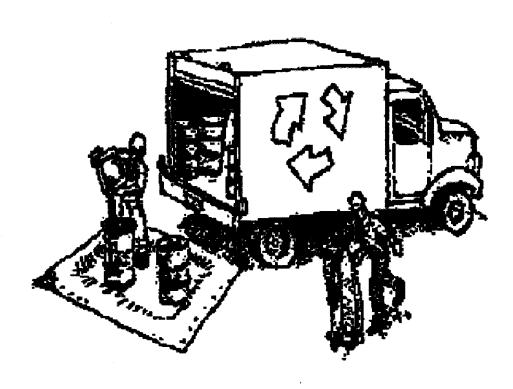

Non-Hazardous Materials

- ☐ Berm and cover stockpiles of sand, dirt or other construction material with tarps when rain is forecast or if not actively being used within 14 days.
- ☐ Use (but don't overuse) reclaimed water for dust control.

Hazardous Materials

- ☐ Label all hazardous materials and hazardous wastes (such as pesticides, paints, thinners, solvents, fuel, oil, and antifreeze) in accordance with city, county, state and federal regulations.
- ☐ Store hazardous materials and wastes in water tight containers, store in appropriate secondary containment, and cover them at the end of every work day or during wet weather or when rain is forecast.
- ☐ Follow manufacturer's application instructions for hazardous materials and be careful not to use more than necessary. Do not apply chemicals outdoors when rain is forecast within 24 hours.
- Arrange for appropriate disposal of all hazardous wastes.


Waste Management

- M Cover waste disposal containers securely with tarps at the end of every work day and during wet weather.
- Check waste disposal containers frequently for leaks and to make sure they are not overfilled. Never hose down a dumpster on the construction site.
- Clean or replace portable toilets, and inspect them frequently for leaks and spills.
- Dispose of all wastes and debris properly. Recycle materials and wastes that can be recycled (such as asphalt, concrete, aggregate base materials, wood, gyp board, pipe, etc.)
- Dispose of liquid residues from paints, thinners, solvents, glues, and cleaning fluids as hazardous waste.

Construction Entrances and Perimeter

- Establish and maintain effective perimeter controls and stabilize all construction entrances and exits to sufficiently control erosion and sediment discharges from site and tracking off site.
- Sweep or vacuum any street tracking immediately and secure sediment source to prevent further tracking. Never hose down streets to clean up tracking.

Equipment Management & Spill Control

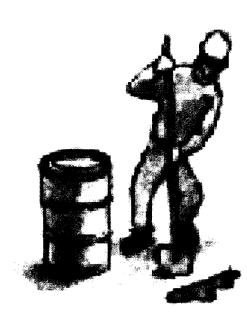

Maintenance and Parking

- ☐ Designate an area, fitted with appropriate BMPs, for vehicle and equipment parking and storage.
- ☐ Perform major maintenance, repair jobs, and vehicle and equipment washing off site.
- ☐ If refueling or vehicle maintenance must be done onsite, work in a bermed area away from storm drains and over a drip pan or drop cloths big enough to collect fluids. Recycle or dispose of fluids as hazardous waste.
- ☐ If vehicle or equipment cleaning must be done onsite, clean with water only in a bermed area that will not allow rinse water to run into gutters, streets, storm drains, or surface waters.
- ☐ Do not clean vehicle or equipment onsite using soaps, solvents, degreasers, or steam cleaning equipment.

Spill Prevention and Control

- Keep spill cleanup materials (e.g., rags, absorbents and cat litter) available at the construction site at all times.
- ☐ Inspect vehicles and equipment frequently for and repair leaks promptly. Use drip pans to catch leaks until repairs are made.
- Clean up spills or leaks immediately and dispose of cleanup materials properly.
- Do not hose down surfaces where fluids have spilled. Use dry cleanup methods (absorbent materials, cat litter, and/or rags).
- Sweep up spilled dry materials immediately. Do not try to wash them away with water, or bury them.
- ☐ Clean up spills on dirt areas by digging up and properly disposing of contaminated soil.
- ☐ Report significant spills immediately. You are required by law to report all significant releases of hazardous materials, including oil. To report a spill: 1) Dial 911 or your local emergency response number, 2) Call the Governor's Office of Emergency Services Warning Center, (800) 852-7550 (24 hours).

Earthmoving




- Schedule grading and excavation work during dry weather.
- X Stabilize all denuded areas, install and maintain temporary erosion controls (such as erosion control fabric or bonded fiber matrix) until vegetation is established.
- Remove existing vegetation only when absolutely necessary, and seed or plant vegetation for erosion control on slopes or where construction is not immediately planned.
- Prevent sediment from migrating offsite and protect storm drain inlets, gutters, ditches, and drainage courses by installing and maintaining appropriate BMPs, such as fiber rolls, silt fences, sediment basins, gravel bags, berms, etc.
- ☐ Keep excavated soil on site and transfer it to dump trucks on site, not in the streets.

Contaminated Soils

- ☐ If any of the following conditions are observed, test for contamination and contact the Regional Water Quality Control Board:
 - Unusual soil conditions, discoloration, or odor.
- Abandoned underground tanks.
- Abandoned wells
- Buried barrels, debris, or trash.

Paving/Asphalt Work

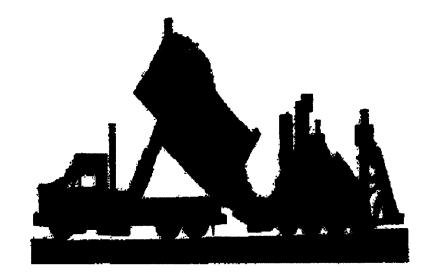


- Avoid paving and seal coating in wet weather or when rain is forecast, to prevent materials that have not cured from contacting stormwater runoff.
- ☐ Cover storm drain inlets and manholes when applying seal coat, tack coat, slurry seal, fog seal, etc.
- Collect and recycle or appropriately dispose of excess abrasive gravel or sand. Do NOT sweep or wash it into gutters.
- Do not use water to wash down fresh asphalt concrete pavement.

Sawcutting & Asphalt/Concrete Removal


- ☐ Protect nearby storm drain inlets when saw cutting. Use filter fabric, catch basin inlet filters, or gravel bags to keep slurry out of the storm drain system.
- ☐ Shovel, abosorb, or vacuum saw-cut slurry and dispose of all waste as soon as you are finished in one location or at the end of each work day (whichever is sooner!).
- ☐ If sawcut slurry enters a catch basin, clean it up immediately.

Concrete, Grout & Mortar

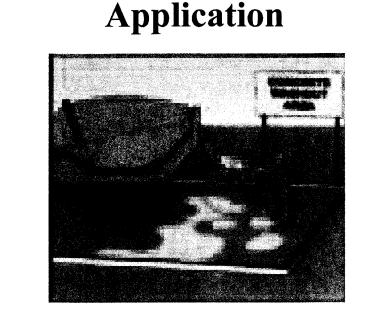


- ☐ Store concrete, grout, and mortar away from storm drains or waterways, and on pallets under cover to protect them from rain, runoff, and wind.
- Wash out concrete equipment/trucks offsite or in a designated washout area, where the water will flow into a temporary waste pit, and in a manner that will prevent leaching into the underlying soil or onto surrounding areas. Let concrete harden and dispose of as
- ☐ When washing exposed aggregate, prevent washwater from entering storm drains. Block any inlets and vacuum gutters, hose washwater onto dirt areas, or drain onto a bermed surface to be pumped and disposed of properly.

Landscaping

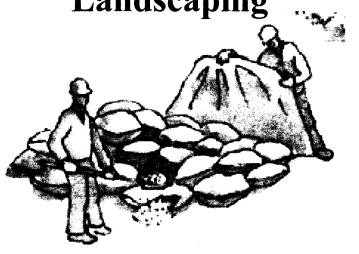

- ☐ Protect stockpiled landscaping materials from wind and rain by storing them under tarps all year-round.
- ☐ Stack bagged material on pallets and under cover.
- Discontinue application of any erodible landscape material within 2 days before a forecast rain event or during wet weather.


Painting & Paint Removal

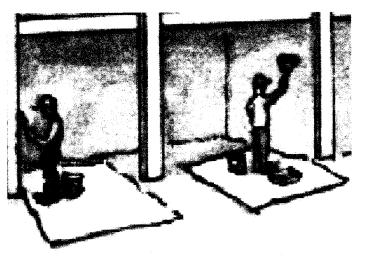

Painting Cleanup and Removal

- Never clean brushes or rinse paint containers into a street, gutter, storm drain, or stream.
- For water-based paints, paint out brushes to the extent possible, and rinse into a drain that goes to the sanitary sewer. Never pour paint down a storm drain.
- ☐ For oil-based paints, paint out brushes to the extent possible and clean with thinner or solvent in a proper container. Filter and reuse thinners and solvents. Dispose of excess liquids as hazardous waste.
- ☐ Paint chips and dust from non-hazardous dry stripping and sand blasting may be swept up or collected in plastic drop cloths and disposed of as trash.
- ☐ Chemical paint stripping residue and chips and dust from marine paints or paints containing lead, mercury, or tributyltin must be disposed of as hazardous waste. Lead based paint removal requires a statecertified contractor.

Dewatering

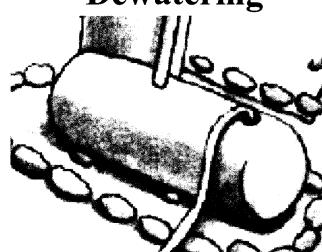

- ☐ Discharges of groundwater or captured runoff from dewatering operations must be properly managed and disposed. When possible send dewatering discharge to landscaped area or sanitary sewer. If discharging to the sanitary sewer call your local wastewater treatment plant.
- ☐ Divert run-on water from offsite away from all disturbed areas.
- ☐ When dewatering, notify and obtain approval from the local municipality before discharging water to a street gutter or storm drain. Filtration or diversion through a basin, tank, or sediment trap may be required.
- ☐ In areas of known or suspected contamination, call your local agency to determine whether the ground water must be tested. Pumped groundwater may need to be collected and hauled off-site for treatment and proper disposal.

Storm drain polluters may be liable for fines of up to \$10,000 per day!

THE GARAGE AND/OR CARPORT SHALL BE SEPARATED WITH NOT LESS THAN %-INCH TYPE X GYPSUM BOARD, AND ALL WALLS SUPPORTING THE CEILING TO BE MINIMUM 1/2-INCH GYPSUM BOARD. OPENINGS IN GARAGE WALLS SHALL COMPLY WITH SECTION R302.5.

-EXTERIOR WALLS AND WALL SEPARATING THE HOUSE AND GARAGE TO BE 2x6 -INTERIOR WALLS TO BE 2x4 EXCEPT FOR INTERIOR WALLS MARKED AS BELOW SHALL BE 2x6

TILE FLOORS REQUIRE THINSET,

1/4" HARDIEBACKER CEMENT
BOARD AND A MAXIMUM WEIGHT
OF CERAMIC TILE OF 4.7 psf.

CM

WINDOW SCHEDULE

DOUBLE HUNG

SINGLE HUNG

SLIDER

CASEMENT

TEMPERED

TRANSOM

FIXED

TABLE R3026

ADLL NOVE	
SEPARATION	MATERIAL
FROM THE RESIDENCE AND ATTICS	NOT LESS THAN 1/2-INCH GYPSUM BOARD OR EQUIVALENT APPLIED TO THE GARAGE SIDE.
FROM ALL HABITABLE ROOMS ABOVE THE GARAGE OR CARPORT	NOT LESS THAN 1/2-INCH TYPE X GYPSUM BOARD OR EQUIVALENT.
STRUCTURE(S) SUPPORTING FLOOR/CEILING ASSEMBLIES USED FOR SEPARATION REQUIRED BY THIS SECTION.	NOT LESS THAN 1/2-INCH GYPSUM BOARD OR EQUIVALENT.
GARAGES LOCATED LESS THAN 3 FEET FROM A DWELLING UNIT ON THE SAME LOT.	NOT LESS THAN 1/2-INCH GYPSUM BOARD OR EQUIVALENT APPLIED TO THE INTERIOR SIDE OF THE EXTERIOR WALLS THAT ARE WITHIN THIS AREA.

DOOR SCHEDULE

- SOLID WOOD DOORS NOT LESS THAN 1-3% INCHES (35 MM) IN THICKNESS, SOLID OR HONEYCOMB CORE STEEL DOORS NOT LESS THAN 1-3% INCHES (35 MM) THICK, OR 20-MINUTE FIRE-RATED DOORS. DOORS SHALL BE SELF-CLOSING AND SELF-LATCHING DEVICE. SEE GENERAL NOTES FOR EXCEPTION.
- 2 36" EXTERIOR EXIT DOOR NET CLEAR DOOR WAY SHALL BE 32". DOOR SHALL BE OPENABLE FROM INSIDE WITHOUT THE USE OF A KEY OR ANY SPECIAL KNOWLEDGE OR EFFORT. DOOR SHALL SWING TO THE FULL OPEN POSITION WHEN AN OPENING FORCE NOT EXCEEDING 30 Ibs. IS APPLIED TO THE LATCH SIDE. GLAZING IN DOORS SHALL BE DUAL PANE SAFETY GLASS WITH MIN. U-VALUE OF 060. PERIMETER OF DOOR SHALL BE WEATHER STRIPPED. GLAZING IN DOORS SHALL BE DUAL PANE SAFETY GLASS.
- EXTERIOR DOORS SHALL COMPLY WITH ONE OF THE FOLLOWING:

 1. THE EXTERIOR SURFACE OR CLADDING SHALL BE OF NONCOMBUSTIBLE OR IGNITION-RESISTANT MATERIAL, OR

 2. SHALL BE CONSTRUCTED OF SOLID CORE WOOD THAT COMPLY WITH THE FOLLOWING
- REQUIREMENTS:
 2.1 STILES AND RAILS SHALL NOT BE LESS THAN 13/8" THICK
 2.2 RAISED PANELS SHALL NOT BE LESS THAN 11/4" THICK, EXCEPT FOR THE
 EXTERIOR PERIMETER OF THE RAISED PANEL THAT MAY TAPER TO A TONGUE NOT LESS
- THAN 36" THICK.

 3. SHALL HAVE A FIRE-RESISTANCE RATING OF NOT LESS THAN 20 MINUTES WHEN TESTED ACCORDING TO NFPA 252.
- 4. SHALL BE TESTED TO MEET THE PERFORMANCE REQUIREMENTS OF SFM STANDARD 12-7A-1.
- GLAZING IN DOORS SHALL BE DUAL PANE SAFETY GLASS
- 4 INTERIOR DOORS HOLLOW CORE
- (5) SECTIONAL HIGH LIFT OVERHEAD DOOR.
- EXTERIOR DOORS AND DOORS LEADING TO GARAGE SHALL HAVE SINGLE CYLINDER DEAD BOLT IN ADDITION TO DOOR LATCHES.
- GLASS SLIDING DOORS SHALL BE SUPPLEMENTED WITH AN AUXILLARY DOOR LOCK OR PASS STRESS TEST.

LANDING

PROVIDE A MIN. 36" DEEP LANDING ON EACH SIDE OF EACH EXTERIOR DOOR. EACH LANDING SHALL HAVE A DIMENSION OF NOT LESS THAN 36 INCHES MEASURED IN THE DIRECTION OF TRAVEL. THE SLOPE AT EXTERIOR LANDINGS SHALL NOT EXCEED 2%. LANDINGS OR FINISHED FLOORS AT THE REQUIRED EGRESS DOOR SHALL NOT BE MORE THAN $1\frac{1}{2}$ " LOWER THAN THE TOP OF THE THRESHOLD, EXCEPT ON THE EXTERIOR SIDE SHALL NOT BE MORE THAN $1\frac{3}{4}$ " BELOW THE TOP OF THE THRESHOLD PROVIDED THE DOOR DOES NOT SWING OVER THE LANDING OR FLOOR. ALL OTHER EXTERIOR DOORS SHALL BE PROVIDED WITH LANDING NOT MORE THAN $1\frac{3}{4}$ " BELOW THE TOP OF THE THRESHOLD.

STAIR RAILING AND GUARDRAIL NOTES

- STAIRWAYS SHALL HAVE A MINIMUM WIDTH OF 36". HAND RAILS
- MAY ENCROACH A MAXIMUM OF 31/2" INTO THE REQUIRED WIDTH.
- ENCLOSED ACCESSIBLE SPACE UNDER STAIRS SHALL HAVE WALLS, UNDER STAIR SURFACE AND ANY SOFFITS PROTECTED ON THE ENCLOSED SIDE WITH $\frac{1}{2}$ -INCH GYPSUM BOARD, PER R302.7 OF 2016 CRC.
- TREADS SHALL HAVE A MINIMUM LENGTH OF 10".
- RISERS SHALL BE A MAXIMUM OF 734".
- A NOSING NOT LESS THAN 0.75" BUT NOT MORE THAN 1.25" SHALL BE PROVIDED ON STAIRWAYS WITH SOLID RISERS WHERE THE TREAD DEPTH IS LESS THAN 11".
 TOLERANCE LARGEST AND SMALLEST RISER HEIGHT OR TREAD DEPTH SHALL BE 0.375"
- STAIRWAYS SHALL HAVE A MINIMUM OF 6'-8" OF HEADROOM AT THE NOSE OF THE STAIR. - STAIRWAYS HAVING LESS THAN 4 RISERS DO NOT REQUIRE A HAND RAIL.
- GUARDRAILS SHALL BE PROVIDED FOR AT PORCHES, DECKS, BALCONIES, STAIRWAYS AND LANDINGS WHERE THE ADJACENT SURFACE IS GREATER THAN 30" BELOW.
- HANDRAILS SHALL BE CONTINUOUS THE FULL LENGTH OF THE STAIRS.
- THE ENDS OF HANDRAILS SHALL RETURN TO WALL OR TERMINATE INTO A NEWEL
- POST OR SAFETY TERMINAL.
 GUARDRAILS SHALL BE AT NOT LESS THAN 42" IN HEIGHT, PER CRC R312.1.2
 GUARDS ON THE OPEN SIDES OF STAIRS OR SERVES AS A HANDRAIL, THE TOP OF THE
- GUARD SHALL HAVE A HEIGHT NOT LESS THAN 34" AND NO MORE THAN 38"
- REQUIRED GUARDS SHALL NOT HAVE OPENINGS FROM THE WALKING SURFACE TO THE REQUIRED GUARD HEIGHT THAT ALLOW PASSAGE OF A SPHERE 4" IN DIAMETER. (R312.3)
- THE TRIANGULAR OPENINGS AT THE OPEN SIDE OF A STAIR, FORMED BY THE RISER, TREAD, AND BOTTOM RAIL OF A GUARD, SHALL NOT ALLOW PASSAGE OF A SPHERE 6" IN DIAMETER. (R312.3 exception *1)

TYPE I HANDRAILS WITH A CIRCULAR CROSS SECTION SHALL HAVE AN OUTSIDE DIAMETER OF NOT LESS THAN 11/4" AND NOT GREATER THAN 2". IF THE HANDRAIL IS NOT CIRCULAR, IT SHALL HAVE A PERIMETER DIMENSION OF NOT LESS THAN 4" AND NOT GREATER THAN 61/4" WITH A CROSS SECTION OF DIMENSION OF NOT MORE THAN 21/4". EDGES SHALL HAVE A RADIUS OF NOT LESS THAN ØØI". TYPE 2 HANDRAILS WITH A PERIMETER GREATER THAN 61/4 SHALL HAVE A GRASP ABLE FINGER RECESS AREA ON BOTH SIDES OF THE PROFILE. THE FINGER RECESS SHALL BEGIN WITHIN A DISTANCE OF 3/4" MEASURED VERTICALLY FROM THE TALLEST PORTION OF THE PROFILE AND ACHIEVE A DEPTH OF NOT LESS THAN 5/16" WITHIN 1/8 BELOW THE WIDEST PORTION OF THE PROFILE. THIS REQUIRED DEPTH SHALL CONTINUE FOR NOT LESS THAN 3/8" TO A LEVEL THAT IS NOT LESS THAN 13/4" BELOW THE TALLEST PORTION OF THE PROFILE THE WIDTH OF THE HANDRAIL ABOVE THE RECESS SHALL BE NOT LESS THAN 11/4" AND NOT MORE THAN 23/4". EDGES SHALL HAVE A RADIUS OF NOT LESS THAN ØØI".

GENERAL NOTES

REFERENCE THE ELECTRICAL PLAN FOR LOCATION AND SPECIFICATIONS OF SMOKE DETECTORS AND OTHER ELECTRICAL REQUIREMENTS.

ATTIC ACCESS SHALL BE:

ATTIC ACCESS SHALL BE:

- REQUIRED IN A BUILDING WITH
COMBUSTIBLE CEILING OR ROOF
CONSTRUCTION WITH A VERTICAL
HEIGHT OF 30" OR GREATER OVER
AN AREA OF NOT LESS THAN 30 SQ.
FT. THE VERTICAL HEIGHT SHALL
BE MEASURED FROM THE TOP OF

FT. THE VERTICAL HEIGHT SHALL BE MEASURED FROM THE TOP OF THE CEILING FRAMING MEMBERS TO THE UNDERSIDE OF THE ROOF FRAMING MEMBERS.

NOT LESS THAN 22" × 30" AT THE ROUGH-FRAMED OPENING..

ATTICS PER 2016 R807.

LOCATED IN A CORRIDOR, HALLWAY OR OTHER READILY ACCESSIBLE LOCATION. WHERE LOCATED IN A WALL, THE ROUGH OPENING SHALL BE NOT LESS THAN 22" WIDE BY 30" HIGH. WHEN THE ACCESS IS LOCATED IN A CEILING, MINIMUM UNOBSTRUCTED HEADROOM IN THE ATTIC SPACE SHALL BE 30" AT SOME POINT ABOVE THE ACCESS MEASURED VERTICALLY FROM THE BOTTOM OF CEILING FRAMING MEMBERS. SEE THE CALIFORNIA MECHANICAL CODE FOR ACCESS REQUIREMENTS WHERE MECHANICAL EQUIPMENT IS LOCATED IN

WINDOWS AND GLAZING

WINDOWS SHALL BE DUAL PANE

EMERGENCY AND ESCAPE RESCUE OPENINGS SHALL HAVE A NET CLEAR OPENING OF NOT LESS THAN 5.7 SQ. FT., 5.0 SQ. FT. ALLOWED AT GRADE. THE NET CLEAR OPENING DIMENSIONS REQUIRED BY THIS SECTION SHALL BE OBTAINED BY THE NORMAL OPERATION OF THE EMERGENCY ESCAPE AND RESCUE OPENING FROM THE INSIDE. THE NET CLEAR HEIGHT OPENINGS SHALL BE NOT LESS THAN 24" AND THE NET CLEAR WIDTH SHALL BE NOT LESS THAN 20 INCHES. FINISHED SILL HEIGHT SHALL BE NOT MORE THAN 44 INCHES ABOVE THE FINISHED FLOOR.

RESCUE WINDOW'S IN BEDROOMS ARE LABELED AS EGRESS, CONTRACTOR / OWNER TO VERIFY THAT THEY MEET ALL REQUIREMENTS.

ALL GLAZING LESS THAN 60 INCHES ABOVE A SHOWER OR TUB FLOOR, GLAZING ADJACENT TO STAIRWAYS, LANDINGS AND RAMPS WITHIN 36 INCHES HORIZONTALLY OF A WALKING SURFACE WHEN THE EXPOSED SURFACE OF THE GLAZING IS LESS THAN 60 INCHES ABOVE THE PLANE OF THE ADJACENT WALKING SURFACES AND GLAZING IN ALL FIXED AND OPERABLE PANELS OF SWINGING, SLIDING AND BI-FOLD DOORS SHALL BE TEMPERED GLAZING PER 2016 CRC R308.4.

SHOWER COMPARTMENTS AND WALLS ABOVE BATHTUBS WITH INSTALLED SHOWER HEADS SHALL BE FINISHED WITH A NONABSORBENT SURFACE TO A HEIGHT OF NOT LESS THAN 6 FEET ABOVE THE FLOOR PER CRC 301.2.


PER CBC 308.4.3 GLAZING IN AN INDIVIDUAL FIXED OR OPERABLE PANEL THAT MEETS ALL OF THE FOLLOWING CONDITIONS SHALL BE CONSIDERED TO BE A HAZARDOUS

LOCATION:

1. THE EXPOSED AREA OF AN INDIVIDUAL PANE IS LARGER THAN 9 SQ. FT. AND

2. THE BOTTOM EDGE OF THE GLAZING IS LESS THAN 18 INCHES ABOVE THE FLOORS

3. THE TOP EDGE OF THE GLAZING IS MORE THAN 36 INCHES ABOVE THE FLOOR AND 4. ONE OR MORE WALKING SURFACES ARE WITHIN 36 INCHES MEASURED HORIZONTALLY AND IN A STRAIGHT LINE, OF THE GLAZING.

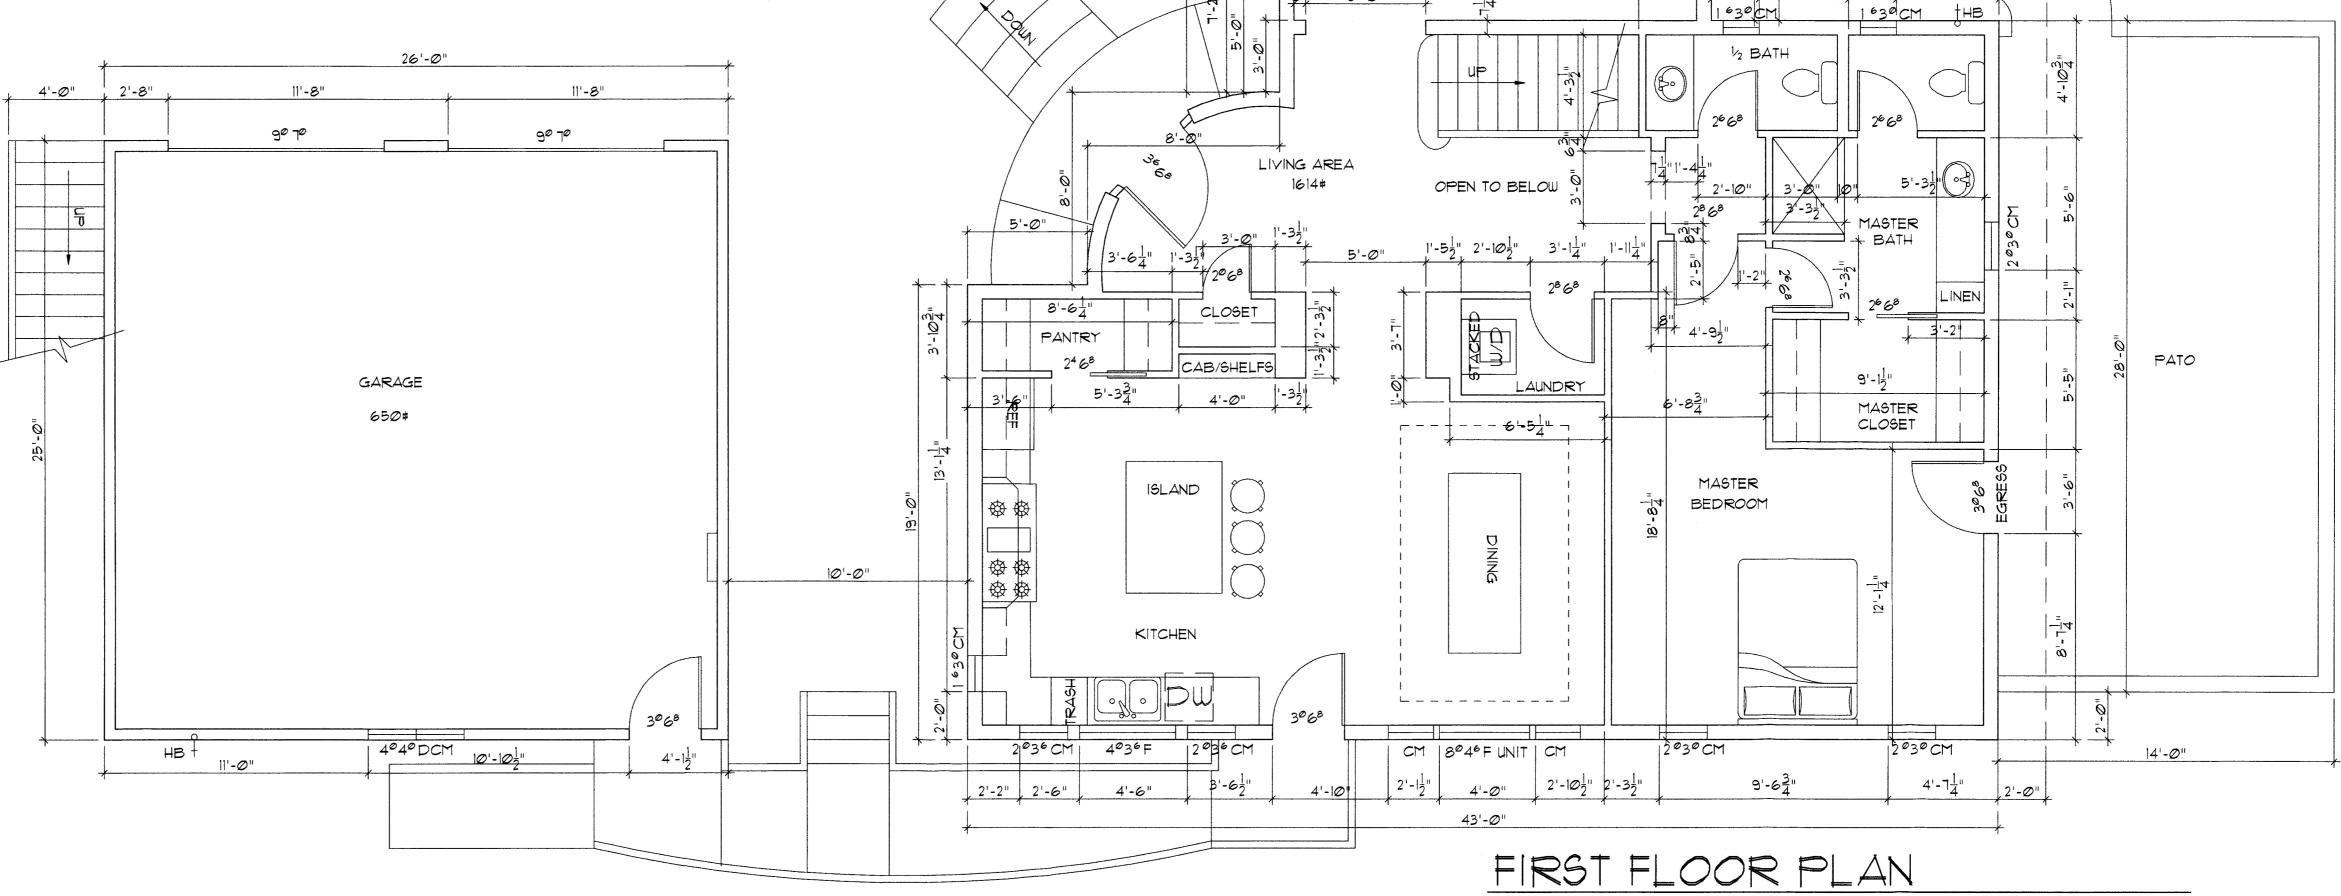

CALGREEN MANDATORY MEASURES

- 1. DUCT SYSTEMS ARE SIZED, DESIGNED, AND EQUIPMENT IS SELECTED PER SECTION 4.501.2 HVAC SYSTEM INSTALLERS MUST BE TRAINED AND CERTIFIED AND SPECIAL INSPECTORS EMPLOYED BY THE ENFORCING AGENCY MUST BE QUALIFIED.
- 2. PROTECT ANNULAR SPACES AROUND PIPES, ELECTRIC CABLES, CONDUITS AT EXTERIOR WALLS AGAINST THE PASSAGE OF RODENTS (44061)
- 3. COVER DUCT OPENINGS AND OTHER RELATED AIR DISTRIBUTION COMPONENT OPENINGS DURING CONSTRUCTION (4.504.1)
 4. ADHESIVES, SEALANTS AND CAULKS SHALL BE COMPLIANT WITH VOC LIMITS AND OTHER TOXIC COMPOUNDS DURING CONSTRUCTION (4.504.2.1)
 5. PAINTS, STAINS AND OTHER COATING SHALL BE COMPLIANT WITH VOC LIMITS (4.504.2.2)
- 6. AEROSOL PAINTS AND COATINGS SHALL BE COMPLIANT WITH PRODUCT WEIGHTED MIR LIMITS FOR ROC AND OTHER TOXIC COMPOUNDS (4.504.2.3) DOCUMENTATIONS SHALL BE PROVIDED TO VERIFY COMPLIANCE
- T. CARPET AND CARPET SYSTEMS SHALL BE COMPLIANT WITH VOC

GRADE FOUNDATIONS (4.5052)

- LIMITS (4.504.3)

 8. MINIMUM 80% OF FLOOR AREA RECEIVING RESILIENT FLOORING
 SHALL COMPLY WITH THE VOC-EMISSION LIMITS PER SECTIONS 4.504.4

 9. PARTICLEBOARD, MEDIUM DENSITY FIBERBOARD (MDF) AND
 HARDWOOD PLYWOOD USED IN INTERIOR FINISH SYSTEM SHALL COMPLY
 WITH LOW FORMALDEHYDE EMISSION STANDARDS (4.504.5)

 10. INSTALL CAPILLARY BREAK AND VAPOR RETARDER AT SLAB ON
- 11. CHECK MOISTURE CONTENT OF BUILDING MATERIALS USED IN WALL AND FLOOR FRAMING BEFORE ENCLOSURE (4.505.3)
 12. PROVIDE A COPY OF THE OPERATION AND MAINTAINENANCE MANUAL TO THE BUILDING OCCUPANT OR OWNER ADDRESSING ITEMS 1 THROUGH 10 IN SECTION 4.410.1 BELOW:

SECTION 4.410.1 OPERATION AND MAINTENANCE MANUAL

5'-0"

GAS FIREPLACE

LIVING ROOM

4040 DCM

2'-5"

PATO

SECOND STORY FLOOR LIN

5'-0"

4040 DCM

- AT THE TIME OF INSPECTION, A MANUAL, COMPACT DISC, WEB-BASED REFERENCE OR OTHER MEDIA ACCEPTABLE TO THE ENFORCING AGENCY WHICH INCLUDES ALL OF THE FOLLOWING SHALL BE PLACED IN THE BUILDING:
- 1. DIRECTIONS TO THE OWNER OR OCCUPANT THAT THE MANUAL SHALL REMAIN WITH THE BUILDING THROUGHOUT THE LIFE CYCLE OF THE STRUCTURE.
 2. OPERATION AND MAINTENANCE INSTRUCTIONS FOR THE FOLLOWING:
- a. EQUIPMENT AND APPLIANCES, INCLUDING WATER-SAVING DEVICES AND SYSTEMS, HVAC SYSTEMS, PHOTOVOLTAIC SYSTEMS, ELECTRICAL VEHICLE CHARGERS, WATER-HEATING SYSTEMS AND OTHER MAJOR APPLIANCES AND EQUIPMENT. b. ROOF AND YARD DRAINAGE, INCLUDING GUTTERS AND DOWNSPOUTS.
- c. SPACE CONDITIONING SYSTEMS, INCLUDING CONDENSERS AND AIR FILTERS.
 d. LANDSCAPE IRRIGATION SYSTEMS.
 e. WATER REUSE SYSTEMS.
- 3. INFORMATION FROM LOCAL UTILITY, WATER AND WASTE RECOVERY PROVIDERS ON METHODS TO FURTHER REDUCE RESOURCE CONSUMPTION, INCLUDING RECYCLE PROGRAMS LOCATIONS.
- 4. PUBLIC TRANSPORTATION AND/OR CARPOOL OPTIONS AVAILABLE IN THE AREA.
 5. EDUCATIONAL MATERIAL ON THE POSITIVE IMPACTS OF AN INTERIOR RELATIVE HUMIDITY BETWEEN 30-60 PERCENT AND WHAT METHODS AN OCCUPANT MAY USE TO MAINTAIN THE RELATIVE HUMIDITY LEVEL IN THAT RANGE.
- 6. INFORMATION ABOUT WATER-CONSERVING LANDSCAPE AND IRRIGATION DESIGN AND CONTROLLERS WHICH CONSERVE WATER.
 1. INSTRUCTIONS FOR MAINTAINING GUTTERS AND DOWNSPOUTS AND THE IMPORTANCE OF
- 1. INSTRUCTIONS FOR MAINTAINING GUTTERS AND DOWNSPOUTS AND THE IMPORTANCE OF DIVERTING WATER AT LEAST 5 FEET AWAY FROM THE FOUNDATION.

 8. INFORMATION ON REQUIRED ROUTINE MAINTENANCE MEASURES, INCLUDING, BUT NOT
- 9. INFORMATION ABOUT STATE SOLAR ENERGY AND INCENTIVE PROGRAMS AVAILABLE.
 10. A COPY OF ALL SPECIAL INSPECTION VERIFICATIONS BY THE ENFORCING AGENCY OR THIS CODE.


LIMITED TO CAULKING, PAINTING, GRADING AROUND THE BUILDING, ETC.

FIRST FLOOR AREA SECOND FLOOR AREA	1614# 952#
SECOND FLOOR AREA OVER GARAGE	650#
TOTAL LIVING AREA:	3216
GARAGE AREA	650
2ND FLOOR COVERED DECK	109
TOTAL FLOOR AREA:	3975

 $SCALE: \frac{1}{4}" = 1' - 0"$

VENTILATION SEE SHEET AI-2.1

FOR SECOND FLOOR PLAN - SEE SHEET A1-1.2 FOR ELECTRICAL PLAN - SEE SHEET E1-1.1

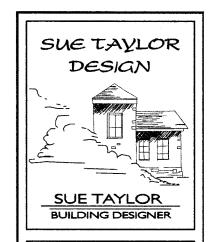

P.O. BOX 961
CAMINO, CA 95709
(530) 391-2190
suetaylordesign@comcast.ne

VEW RESIDENCE IRST FLOOR PLAN

RANDY RALSTON ≰ LINDA MENDIOLA HERMOSA AVENUE HALF MOON BAY CA 94019


Sue Taylor

DATE:
FEBRUARY 07, 2019

DESIGNED BY: SRT
DRAUN BY: SRT
CHECKED BY: SRT

FILE *
PROJECTS/2018/007/001AIII


PROJECTS/2018/007/007AIII
PROJECT *
18007
PAGE OF

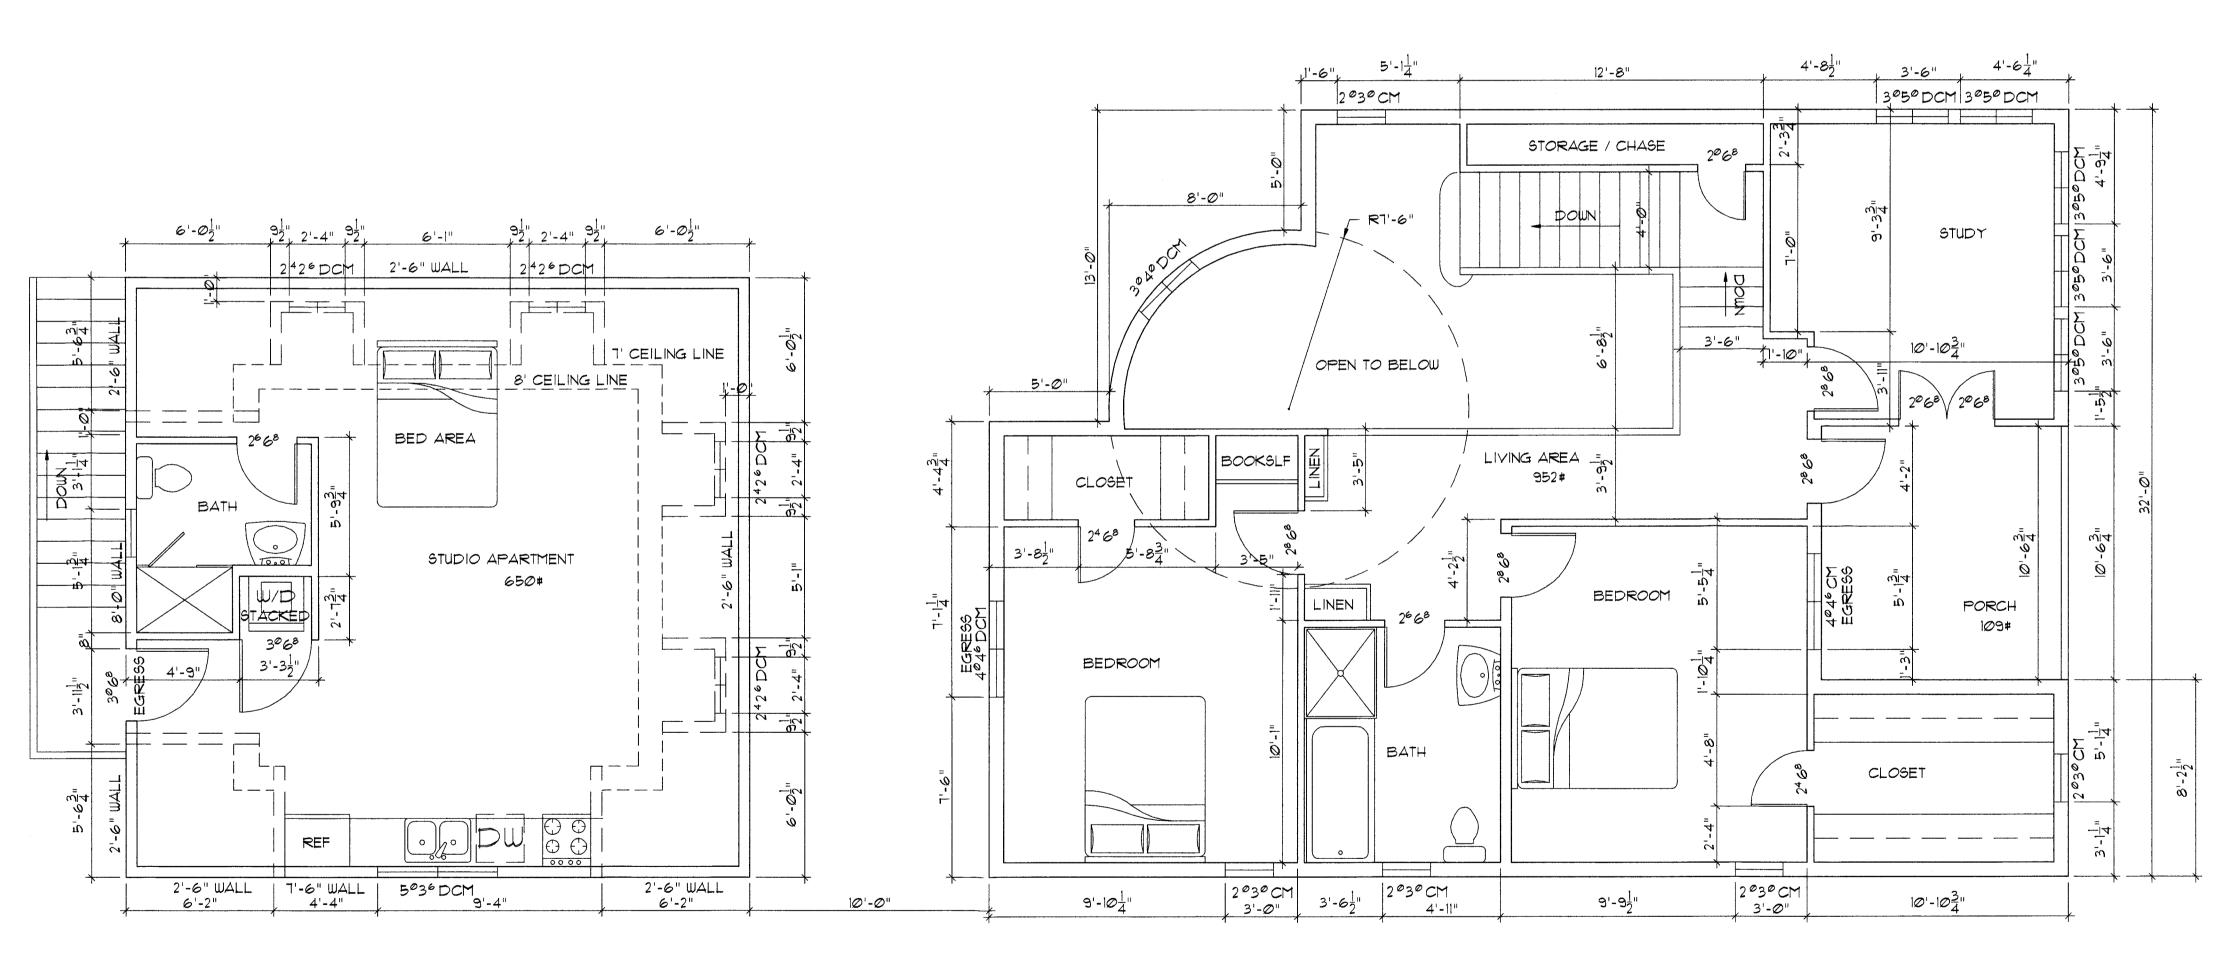

SECOND FLOOR PLAN

SCALE: 1/4" = 1'-0"

FOR FIRST FLOOR PLAN AND NOTES - SEE SHEET AI-1.1 FOR ELECTRICAL PLAN - SEE SHEET E1-1.2

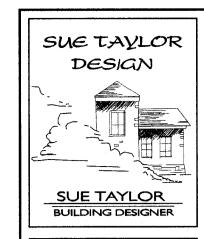

P.O. BOX 961 CAMINO, CA 95709 (530) 391-2190

suetaylordesign@comcast.net

RANDY

REVISION	DATE	DESCRIPTION
-	6-21-19	REVISIONS PER DESIGN REVIEW 6-13-19
2	7-24-19	REVISIONS PER DESIGN REVIEW 7-11-19

DATE: FEBRUARY Ø1, 2019

| Sue Taylor |

FILE *
PROJECTS/2018/007/007A112 PAGE OF

F.F. = 93.115F.F. = 83.0 4.9# OF UNDER FLOOR FOUNDATION WEST ELEVATION YENTS REQUIRED (7 VENTS TOTAL)

SCALE: 1/4" = 1'-0"

RESIDENCE

PROVIDED BY EAVE OR CORNICE VENTS. AS AN ALTERNATIVE, THE NET FREE CROSS-VENTILATION AREA MAY BE REDUCED TO 1/300 WHEN A CLASS I OR I YAPOR BARRIER IS INSTALLED ON THE WARM-IN-WINTER SIDE OF THE CEILING.

PER CRC SECTION R806.3: WHERE EAVE OR CORNICE VENTS ARE INSTALLED, INSULATION SHALL NOT BLOCK THE FREE FLOW OF AIR. A MINIMUM OF A 1-INCH SPACE SHALL BE PROVIDED BETWEEN THE INSULATION AND THE ROOF SHEATHING AND AT THE LOCATION OF THE VENT.

NECESSARY LOWER ROOF VENTILATION:

ROOF: 378# / 150 = 2.52# OF VENTILATION NECESSARY

PROPOSED LOWER ROOF VENTILATION:

ROOF: 20 L.F. OF RIDGE VENT (.125 PER SQ. FT.) = 2.5 ON EAST SIDE: 10 (TOTAL) - BAY VENTS (.13 PER BAY#) = 1.3# ON WEST SIDE: 10 (TOTAL) - BAY VENTS (.13 PER BAY#) = 1.3#

TOTAL PROPOSED LOWER ROOF:

NECESSARY UPPER ROOF VENTILATION:

ROOF: 1323# / 150 = 8.82# OF VENTILATION NECESSARY

ROOF: $112 \pm / 150 = .75 \pm 0 \pm VENTILATION NECESSARY$


NECESSARY GARAGE ROOF VENTILATION: ROOF: 650# / 150 = 4.33# OF VENTILATION NECESSARY

PROPOSED GARAGE ROOF

ROOF: 112# / 150 = .75# OF VENTILATION NECESSARY

PROPOSED GARAGE ROOF

IN NO CASE SHOULD THE AMOUNT OF EXHAUST VENTILATION EXCEED THE AMOUNT OF INTAKE VENTILATION.

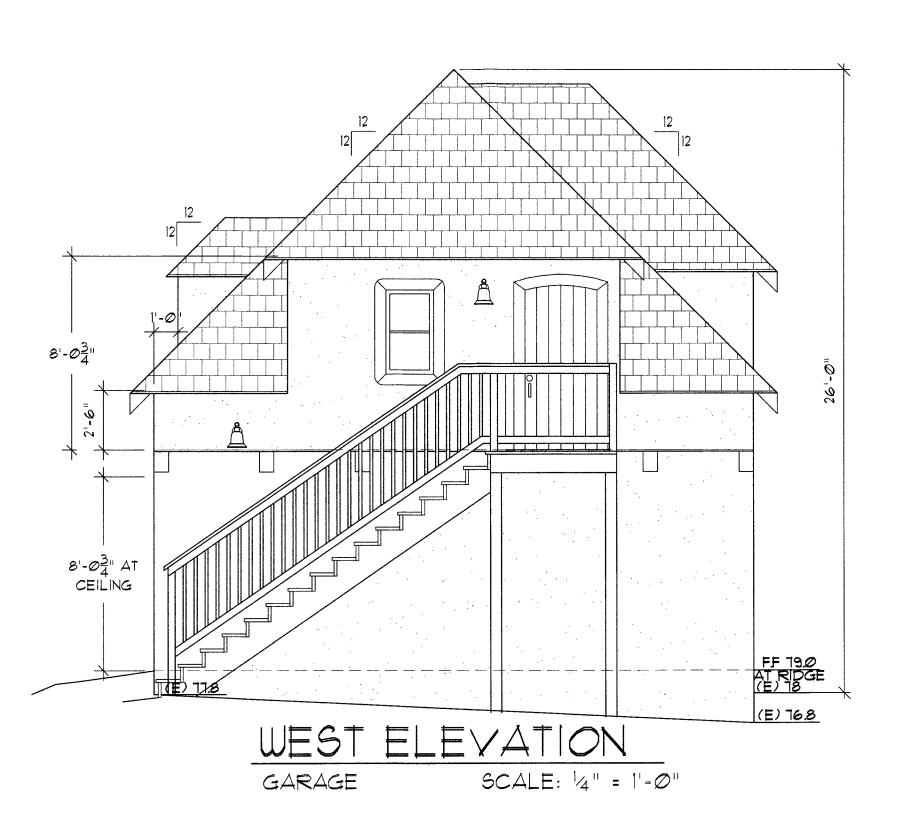

SUE TAYLOR DESIGN SUE TAYLOR


BUILDING DESIGNER P.O. BOX 961 CAMINO, CA 95709

(530) 391-2190

- | 4 | W | 4

, Sue Taylor

FEBRUARY 07, 2019 designed by: || Sr DRAWN BY: SRT CHECKED BY: SRT PROJECTS/2018/007/007A121 18007 PAGE OF

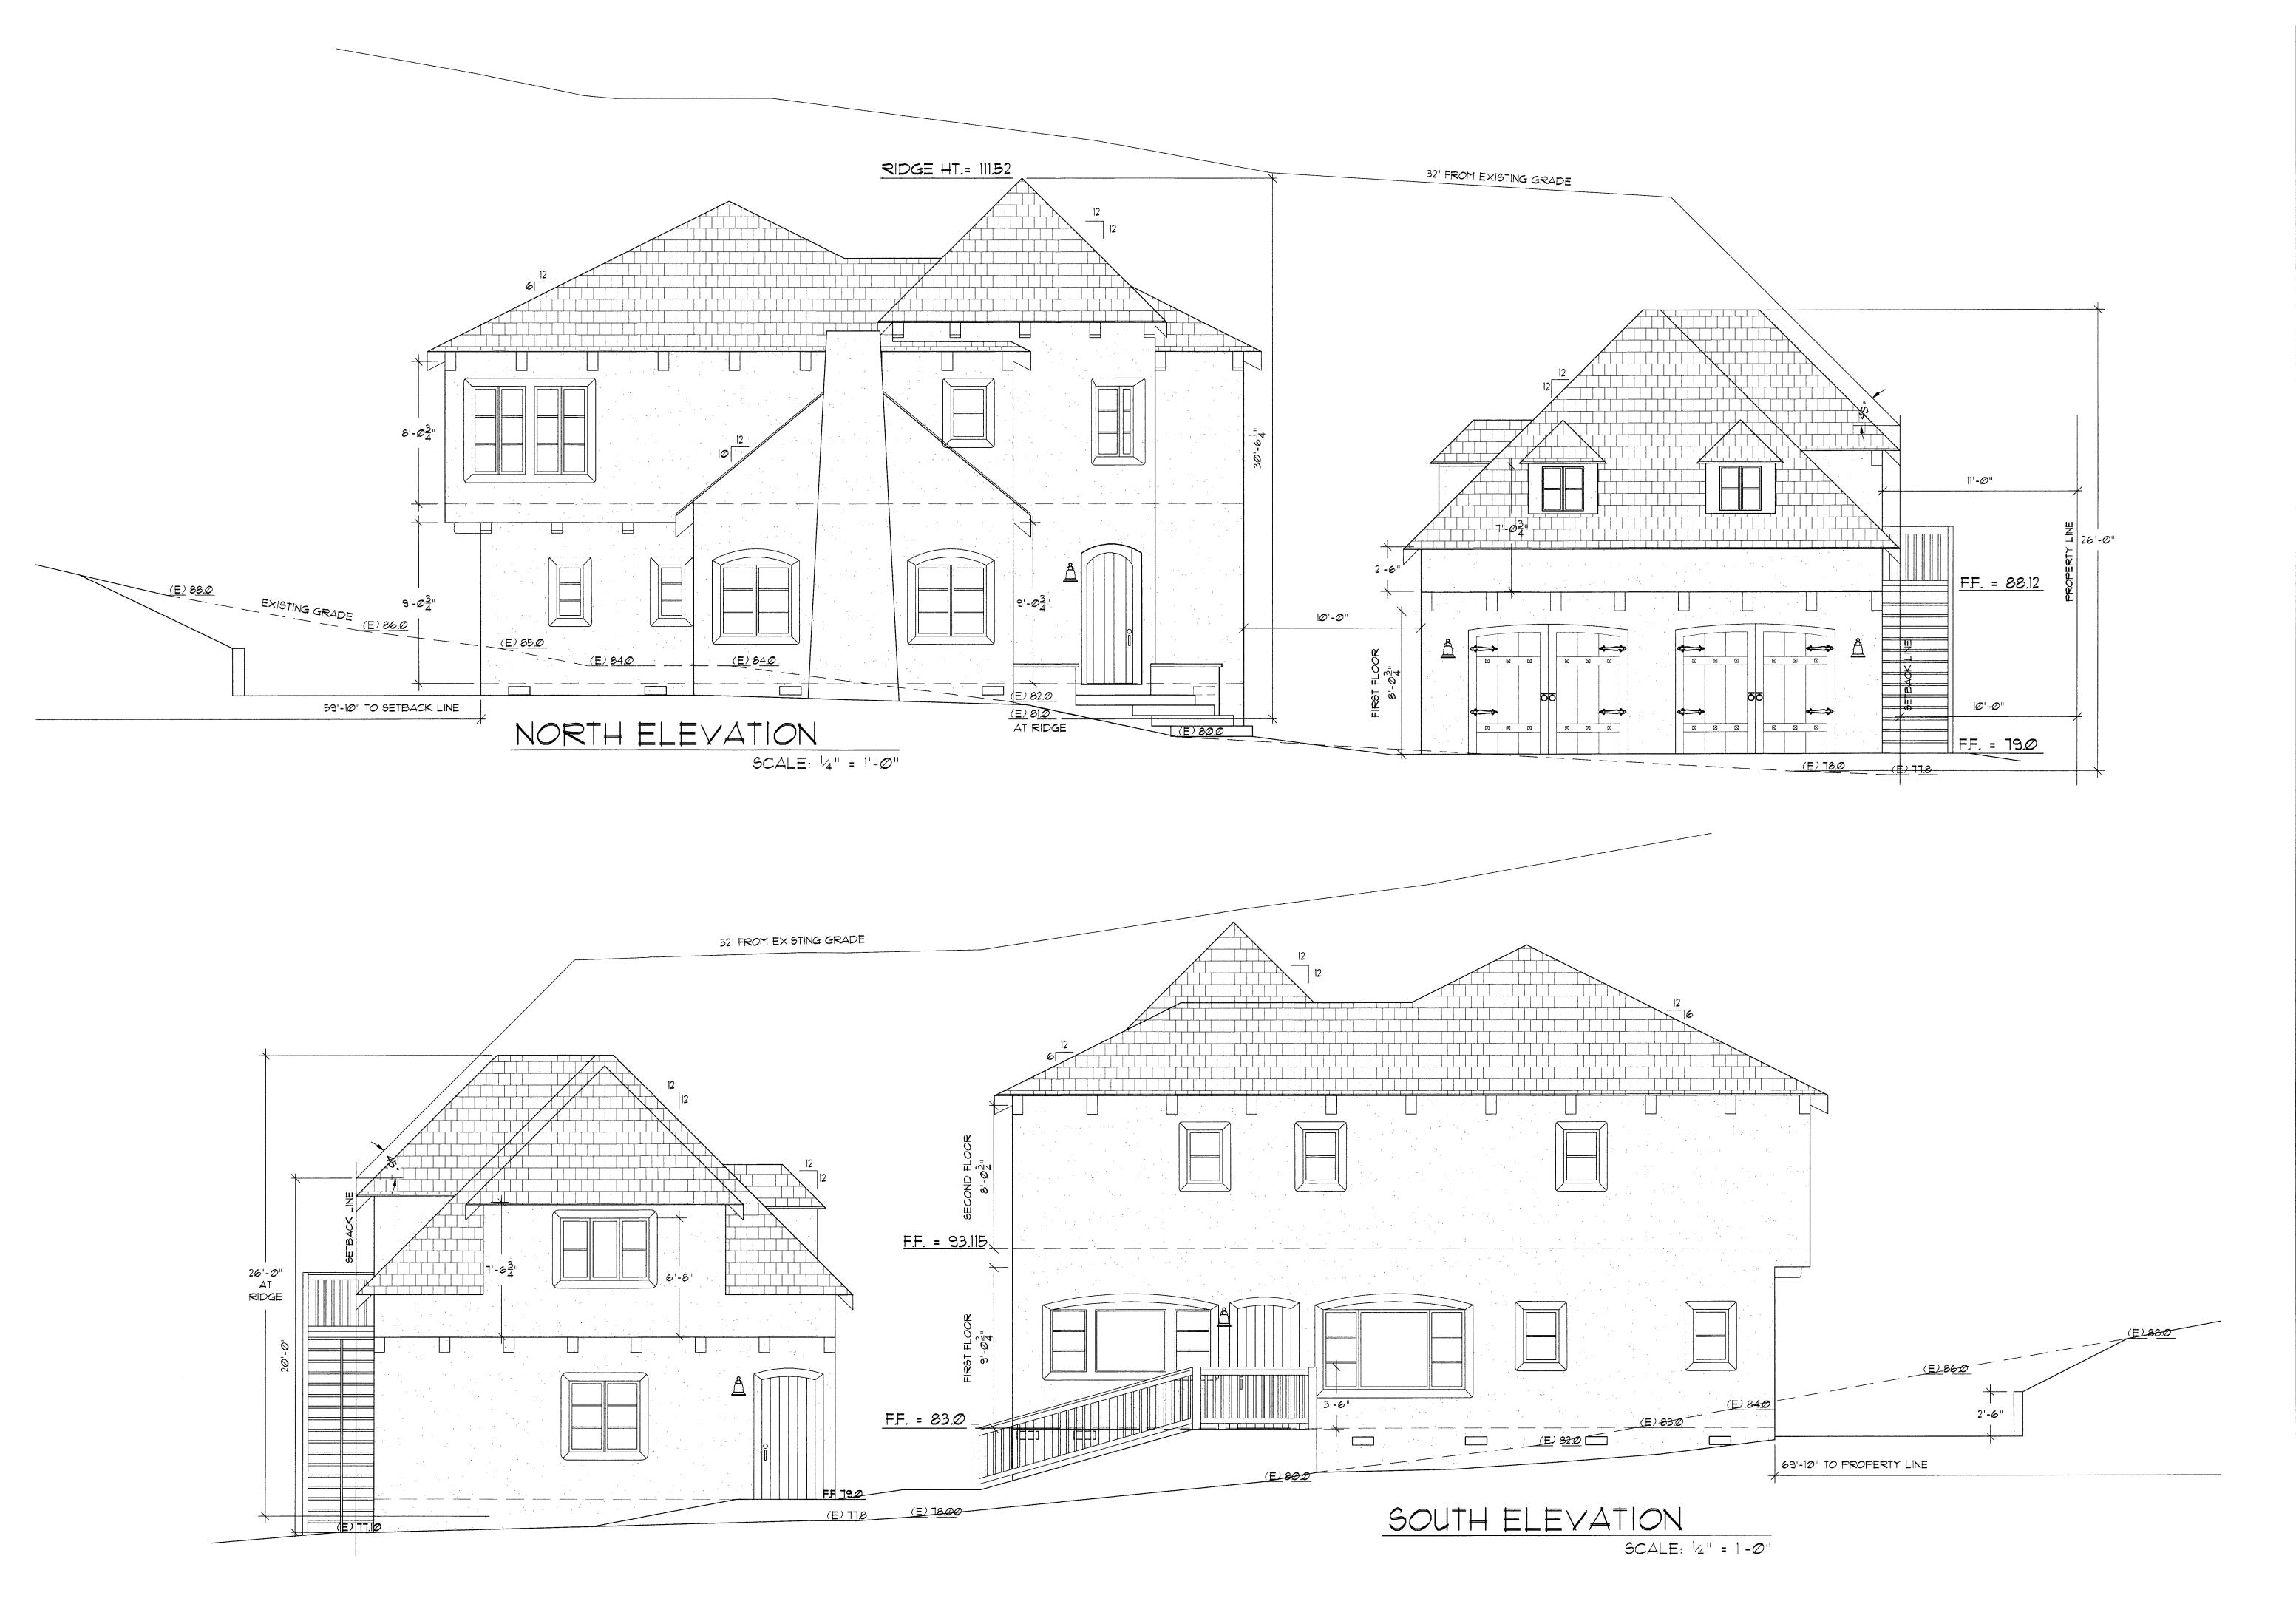



P.O. BOX 961

CAMINO, CA 95709

(530) 391-2190

suetaylordesign@comcast.net

NEW REGIOENOM NORTH A COULT

RANDY RALSTON & LINDA MENDIOLA HERMOSA AVENUE HALF MOON BAY, CA 94@19

1 4-2-19 REVISIONS PER PLANNING 2 6-21-19 REVISIONS PER DESIGN RE 3 1-24-19 REVISIONS PER DESIGN RE			
			
	-	4-2-19	REVISIONS PER PLANNING 3-18-19
	2	6-21-19	REVISIONS PER DESIGN REVIEW 6-13-19
	6	7-24-19	REVISIONS PER DESIGN REVIEW 7-11-19

Sue Taylor

PATE: FEBRUARY Ø1, 2019

DESIGNED BY: SRT

DRAWN BY: SRT


CHECKED BY: SRT


FILE *


PROJECTS/2018/007/007A122


PROJECT *

PAGE OF 11
SHEET NO.

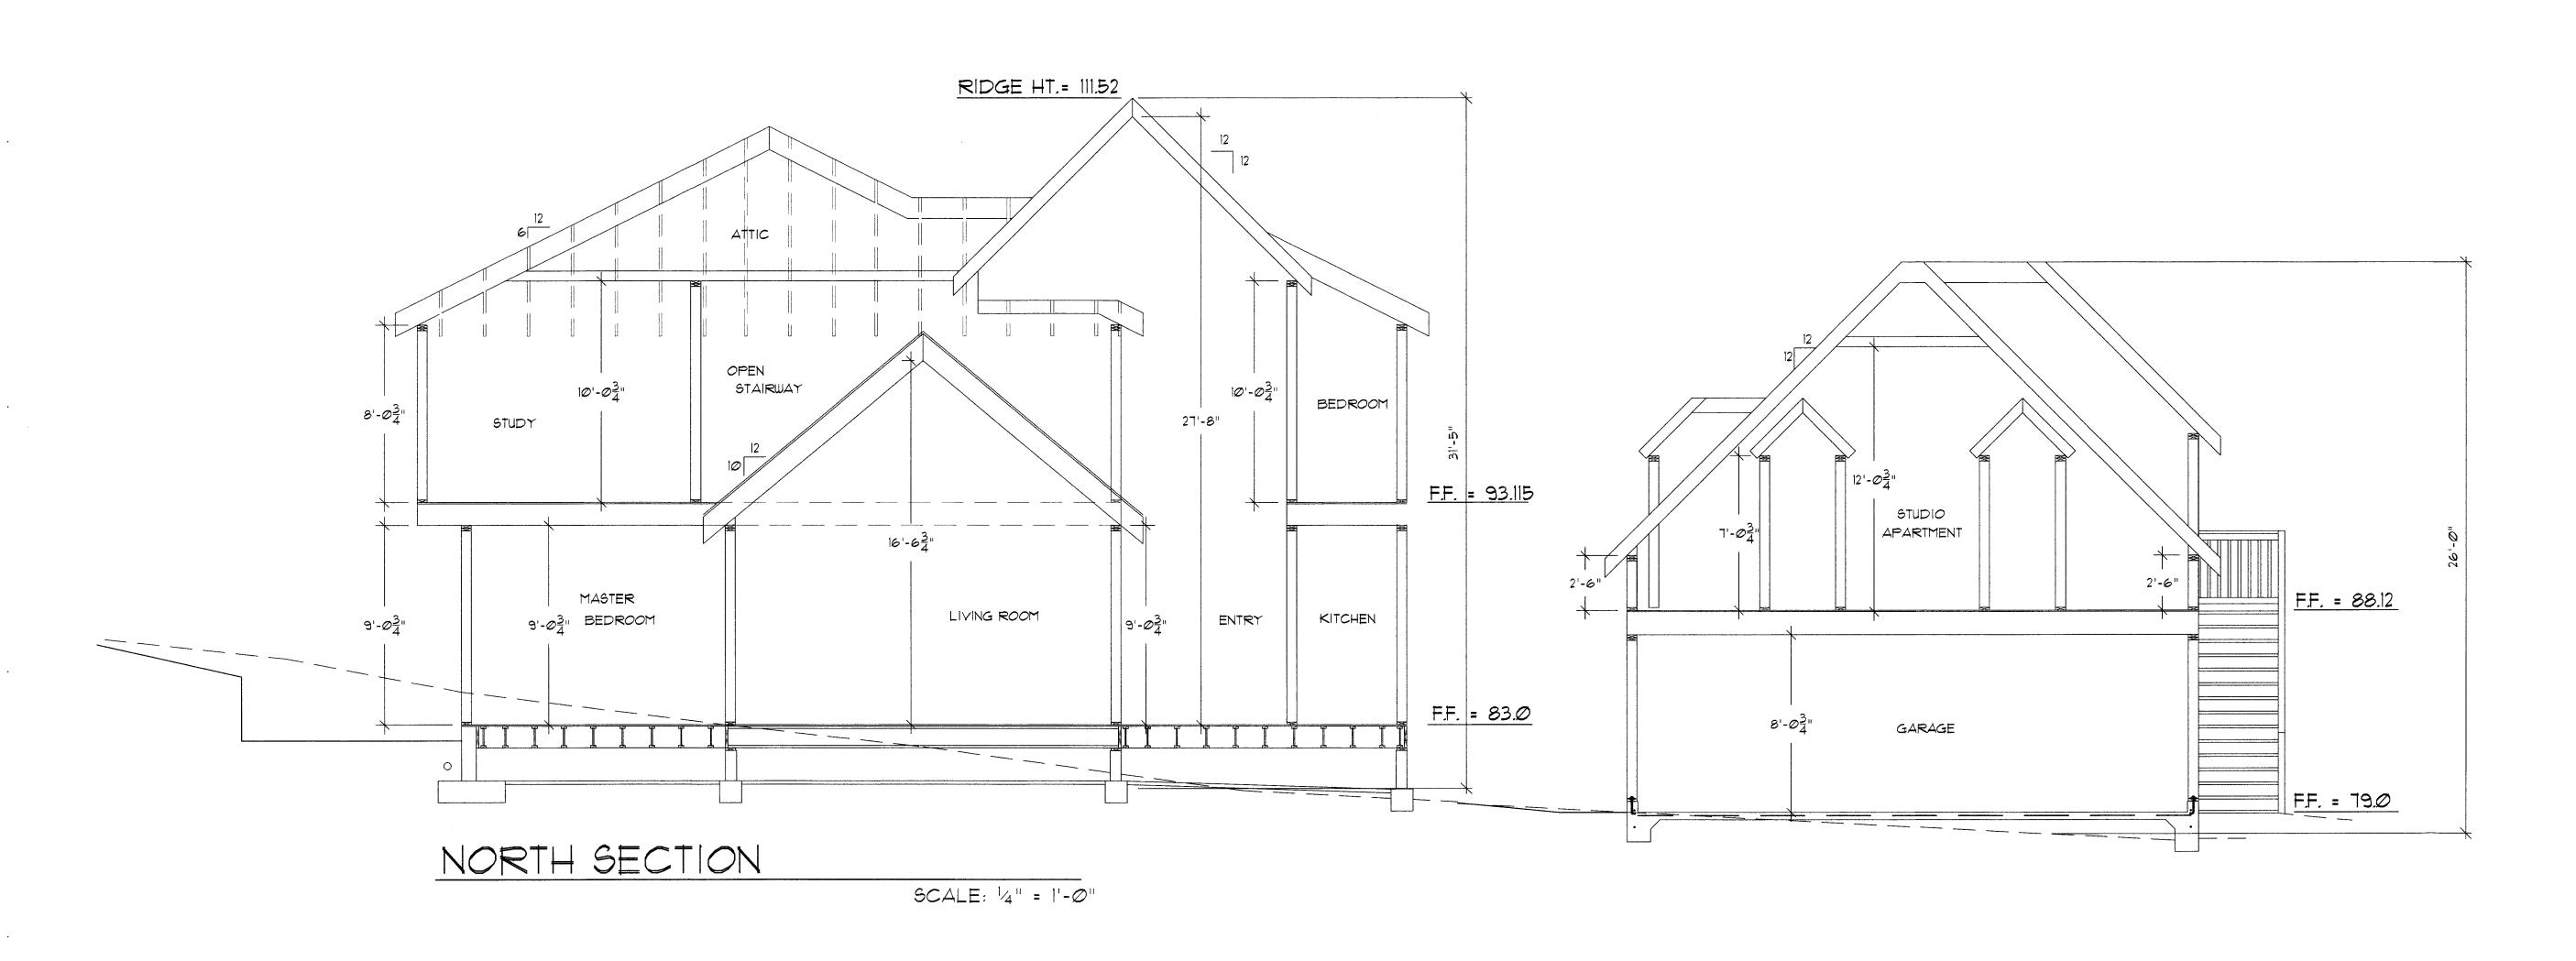

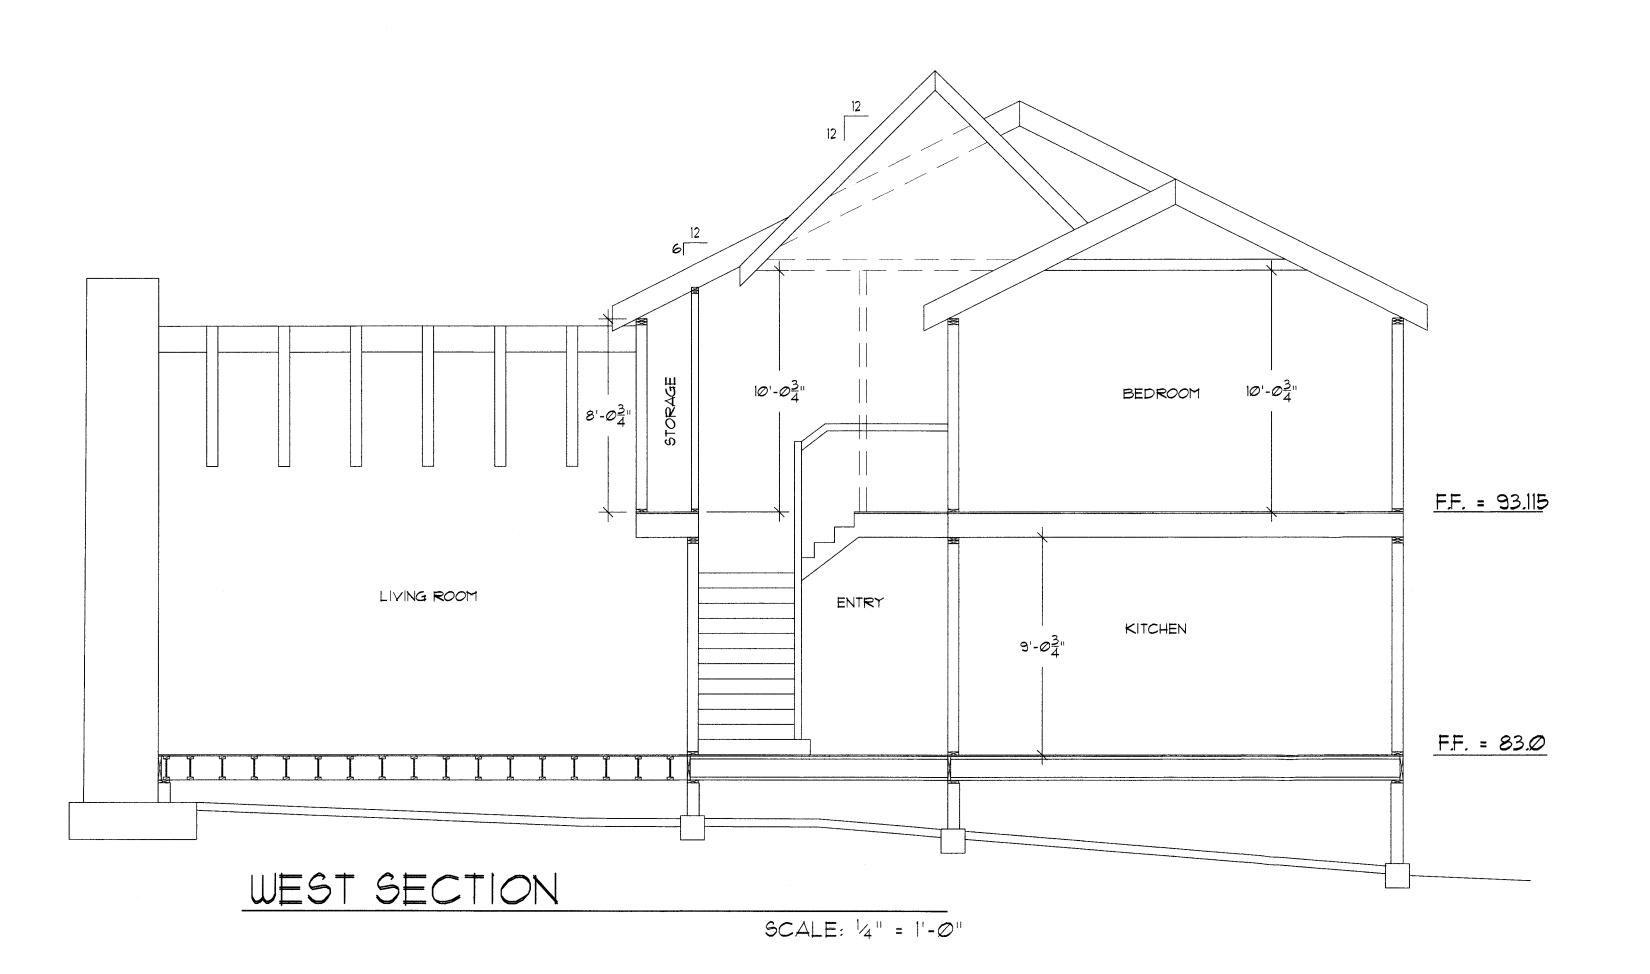

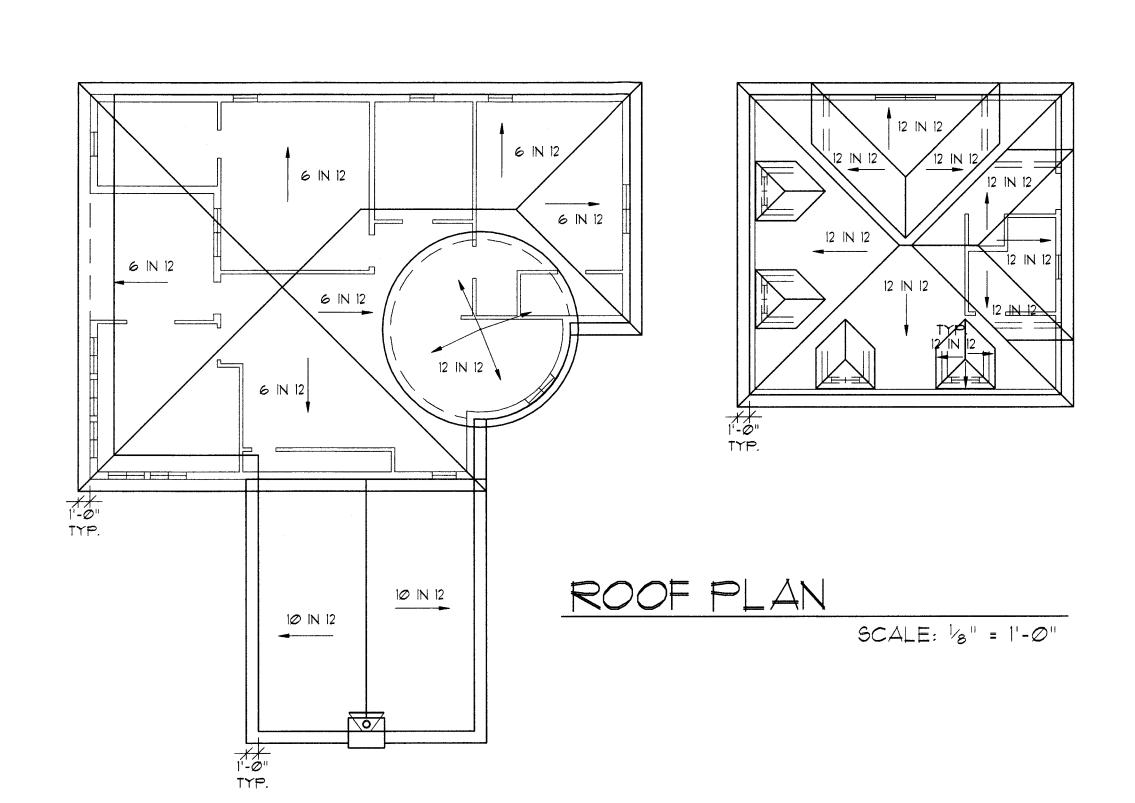


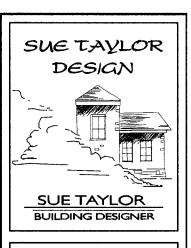

P.O. BOX 961
CAMINO, CA 95709
(530) 391-2190
suetaylordesign@comcast.net

NEW RESIDENCE BUILDING SECTIONS

RANDY RALSTON & LINDA MENDIOLA HERMOSA AVENUE HALF MOON BAY, CA 94019

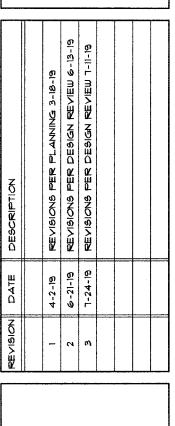

Sue Taylor

DATE: FEBRUARY Ø7, 2019

DESIGNED BY: SRT
DRAWN BY: SRT
CHECKED BY: SRT
FILE *
PROJECTS/2018/001/001A131
PROJECT *
18001
PAGE OF

FIRE JURISDICTION:	San Mateo County Building Dept.
☐ BELMONT FIRE	2013 CRC –R327 Development Worksheet
☑ COASTSIDE FIRE	· · · · · · · · · · · · · · · · · · ·
SM COUNTY FIRE	Materials and Construction Methods for Exterior Wildfire Exposure
☐ WOODSIDE FIRE	Extend vinding Exposure

Project is located in State Responsibility Area (SRA):

✓ Yes ☐ No

If in SRA, is project in a Very High Fire Hazard Severity Zone (VHFHSZ): ☐ Yes ☐ No

Project is located in Local Responsibility Area (LRA):

Yes No
If in LRA, is project in a Very High Fire Hazard Severity Zone (VHFHSZ):

Yes No

Applicable Code Section(s)	OK	N/A	Approved Material (if applicable)	Location On Plans
Roofing				
Class B minimum (SM Co Div VII, Sec 9113; 2013 CRC R902.1.2)	Х		Armourshake, Premium Dimensional IKO Shingles - Western Redwood	007A121
Class A in VHFHSZ (2013 CRC R902.1.1)		Х		
Where roof profile allows for a space between the roof covering and deck, the spaces shall be constructed to prevent the intrusion of flames and embers, fire stopped or have one layer of No. 72 ASTM D 3909 cap sheet over the combustible decking. (R327.5.2)	X			007A121
Valley flashings min. 0.019-inch (No 26 galv.) corrosion resistant metal over 36 inch wide underlayment of No. 72 lb mineral-surfaced nonperforated ASTM D 3909 cap sheet. (R327.5.3)				007A121
Roof gutters shall be provided with the means to prevent the accumulation of debris. (R327.5.4)	Х			007A121

Applicable Code Section(s)	OK	N/A	Approved Material (if applicable)	Location
		<u></u>		On Plans
Exterior Coverings (continued)		 		
The exposed underside of enclosed roof eaves and roof	Х			007A121
eave soffits shall be protected by one of the 1 through 4	į			
items as for exterior walls or have boxed in soffits				
meeting SFM 7A-3 (R327.7.5).				
Ex: Fascia and other architectural trim boards.				
Exterior porch ceilings shall be protected by one of the 1	Х			007A121
through 4 items as for exterior walls or have porch				
ceiling assemblies meeting SFM 7A-3 (R327.7.6).				
Ex: Architectural trim boards.				
Exposed underside of floor projections shall be	Х			007A121
protected by one of the 1 through 4 items as for exterior	^			00/A121
walls or have an underside assembly meeting SFM 7A-3				
(R327.7.7).				
Ex: Architectural trim boards.				
The underfloor area of overhangs, or elevated buildings;	X			007A121
and underside of appendages shall be enclosed to grade	^			00/A121
or the underside shall be protected by one of the 1				
through 4 items as for exterior walls or have an				
assembly meeting SFM 7A-3 (R327.7.8 & R327.7.9).				
Ex: Heavy-timber structural columns and beams do not				
require protection.				

Exterior Glazing		
Exterior windows, glazed doors, glazed openings within exterior doors and structural glass veneer shall be constructed of one of the following:	х	007A111
Note - Provide on window schedule and call out on floor plan. (R327.8.2)		
1. Multipane glass units with a minimum of one		
tempered pane meeting Section 2406 Safety Glazing.		
2. Glass block units.		
3. 20 minute minimum Fire Rated Window.		
4. Meet SFM 12-7A-2.		

Applicable Code Section(s)	ОК	N/A	Approved Material (if applicable)	Location On Plans
Vents	· A ,			
Ventilation openings for attics, enclosed eave soffits,	Х			007A121
enclosed rafter spaces and underfloor areas shall be non-	^			W/A121
combustible, corrosion resistant, and have wire mesh				
with 1/16 th to 1/8 th inch (1.6-3.2 mm) openings or its				
equivalent. (R327.6.2)				
Eave Vents				
Vents shall not be installed in eaves and cornices.	X			007A121
Exceptions: 1. Approved flame and ember resistant	^	1		John L.
vents. 2.1 Attic is fully protected by an automatic fire				
sprinkler system, and 2.2 Exterior wall and underside of				
eave is non-combustible, and is more than 12 ft from				
ground, patio, porch, deck or similar surface. (R327.6.3)				
Exterior Coverings	7	T		
Exterior walls shall comply with one of the following	l x			007A121
(R327.7.3):				
1. Noncombustible material				
2. Ignition-resistant material	l			
3. One layer of 5/8" type X gypsum sheathing behind				
exterior covering.				
 1-hour fire resistant exterior assembly. Heavy-timber exterior wall assembly 				
6. Log wall construction.				
7. Wall assemblies meeting SFM 12-7A-1				
Open Roof Eaves: The exposed roof deck on the	 	 		
underside of the roof eave shall comply with one of 1	X			007A121
through 4 as for exterior walls above (R327.7.4).				
Ex: 1, 2" nominal solid wood rafter tails, 2, 2" nominal				
solid wood blocking between rafter tails. 3. Fascia and				
other architectural trim boards.				

2

Applicable Code Section(s)	OK	N/A	Approved Material (if applicable)	Location On Plans
Doors				
 Exterior door assemblies, including garage doors, shall comply with one of the following (R327.8.3): Surface or cladding be of non-combustible, or ignition-resistant material. Constructed of solid core wood having stiles and rails not less than 1-3/8" with interior field panel thickness no less than 1-1/4" thick. Have a fire resistance rating of not less than 20 minutes. Meet SFM 12-7A-1 	X			007A111
Decking		· · · · · · · · · · · · · · · · · · ·		
The walking surface material of decks, porches, balconies and stairs shall be constructed of one of the following where any portion of such surface is within 10 ft. of the structure (R327.9.3): 1. Ignition-resistant materials that complies with SFM 12-7A-4 and 12-7A-5. 2. Exterior fire-retardant-treated wood. 3. Noncombustible material. 4. Material complying with SFM 12-7A-4A when attached to a noncombustible or ignition resistant wall covering. Ex: When decking surface material meets ASTM E 84, Class B flame spread, the wall material can of any that other wise complies with R327.7.3.	X			007A111
Accessory Structure				
Trellises, arbors, patio covers, carports, gazebos and similar structures attached to applicable buildings and detached buildings within 50 ft shall be constructed of paneombustible or ignition resistant material. (P.327.10)	X			007A111

Office of the State Fire Marshal – Building Materials Listing: http://osfm.fire.ca.gov/licensinglistings/licenselisting bml searchcotest.php 8110-Decking Materials, 8120-Exterior Windows, 8140-Exterior Siding & Sheathings, 8150-Exterior Doors, 8160-Under Eave

noncombustible or ignition resistant material. (R327.10)

SUE TAYLOR

SUE TAYLOR

BUILDING DESIGNER

P.O. BOX 961

CAMINO, CA 95709

(530) 391-2190

suetaylordesign@comcast.net

NEW RESIDENOE COUNTY FIRE WORKSHEET

RANDY RALSTON & LINDA MENDIOLA HERMOSA AVENUE HALF MOON BAY, CA 94@19

	,			 	
DESCRIPTION		REVISIONS PER COUNTY FIRE 3-3-19			
DATE		4-2-19			
ZOISION SI SI ON					

Sue Taylor

DATE: FEBRUARY Ø7, 2019

	L					
1						
İ	DESIGNED BY:	SRT				
	DRAWN BY:	SRT				
İ	CHECKED BY:	SRT				
	FILE * PROJECTS/2018/007/007FIII					
	PROJECT * 18007					
ı	PAGE	OF .				
		11				