

## COUNTY OF SAN MATEO PLANNING AND BUILDING

County Government Center 455 County Center, 2nd Floor Redwood City, CA 94063 650-363-4161 T 650-363-4849 F www.planning.smcgov.org

January 29, 2016

Brian Brinkman 648 Navarre Drive Pacifica, CA 94044

Dear Mr. Brinkman:

SUBJECT: Coastside Design Review

439 Vermont Avenue, Moss Beach

APN 037-133-170; File No. PLN 2015-00289

At its meeting of November 12, 2015, the San Mateo County Coastside Design Review Committee (CDRC) considered your application for a design review permit to allow construction of a 1,091 sq. ft., first and second-story addition to an existing 1,411 sq. ft. one-story single-family residence, with an existing 576 sq. ft. attached two-car garage, on a 7,800 sq. ft. legal parcel. No trees are proposed for removal.

The CDRC found that, although the style and scale of the house is consistent with several other houses in the area, the location of the proposed addition, the simplicity of its forms, and proposed color causes the residence to appear massive and bulky. The placement of the addition above one portion of the house appears imbalanced. The proposed balconies and decks mitigate the mass and bulk of the structure, but are absent in the front elevation of the residence. Also, the proposed windows are not proportional to each other. Finally, the proposed colors and materials do not elevate the project to a higher level of design and/or construction.

The CDRC was unable to make the findings for design review approval based on certain design deficiencies, as described in this letter. In order to resolve these deficiencies in the project's design, a more thorough review of the "Standards for Design for One-Family and Two-Family Residential Development in the Midcoast" manual is required, with emphasis on, but not limited to, Section 6565.20(D)2.a(1),(2) and (3), Section 6565.20(D)2.b, Section 6565.20(D)c(1)(a), Section 6565.20(D)1.d and e, and Section 6565.20(D)4. As such, recommendations and requirements from the CDRC for further project redesign are as follows:

- 1. Develop a consistent architectural style.
- 2. Mitigate the massing of the second-story addition over the garage by positioning it toward the center of the residence.



- 3. Increase the wall articulation by sculpting the walls.
- 4. Reduce massing by improving/adding exterior materials and colors.
- 5. Adjust the size and location of the windows.
- 6. Add grids to the two front facing windows on the first floor.
- 7. Modify the front porch for compatibility with the remodeled home.

At the meeting, you were presented the following available options at the end of the CDRC's deliberation of the project: (i) request for a decision from the CDRC on the plans presented; or (ii) request that the project be considered at the next meeting to provide you with ample time to consider and incorporate the elements recommended for project redesign. You chose the second option, and the CDRC directed staff to schedule your project for consideration at a later date.

Please contact Dennis P. Aguirre, Design Review Officer, at 650/363-1867 if you have any questions.

Sincerely,

Camille Leung, Senior/Planner, for


Dennis P. Aguirre, Design Review Officer

DPA:fc - DPAAA54 WFN.DOCX

cc: Dianne Whitaker, Member Architect


Kris Lannin-Liang, Moss Beach Community Representative

Andrew and Melanie Yee

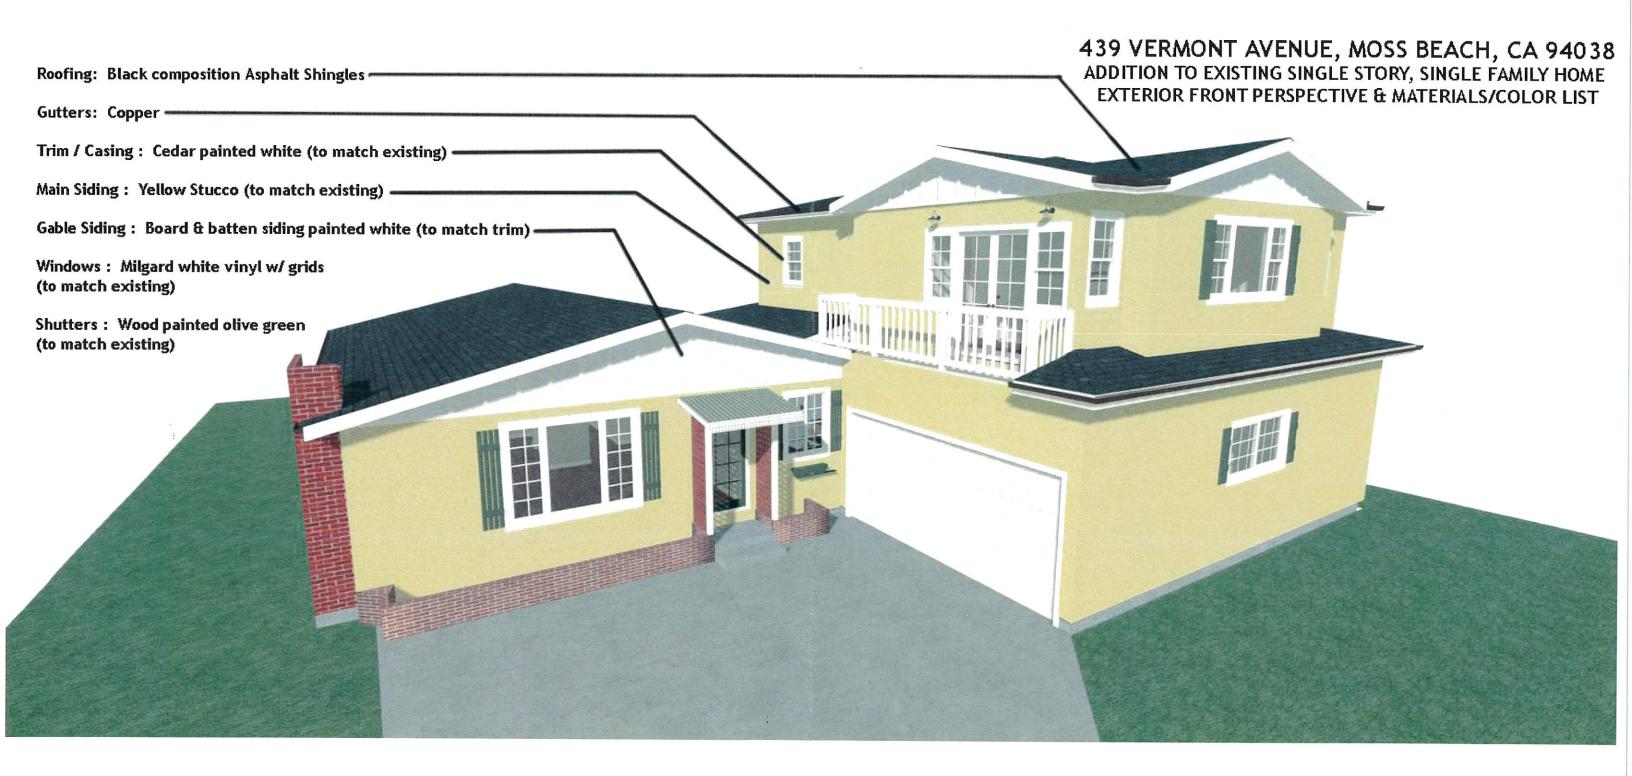

## PLN2015-00289

# ADDITION TO (E) SINGLE FAMILY HOME: YEE RESIDENCE 439 VERMONT AVENUE, MOSS BEACH, CA

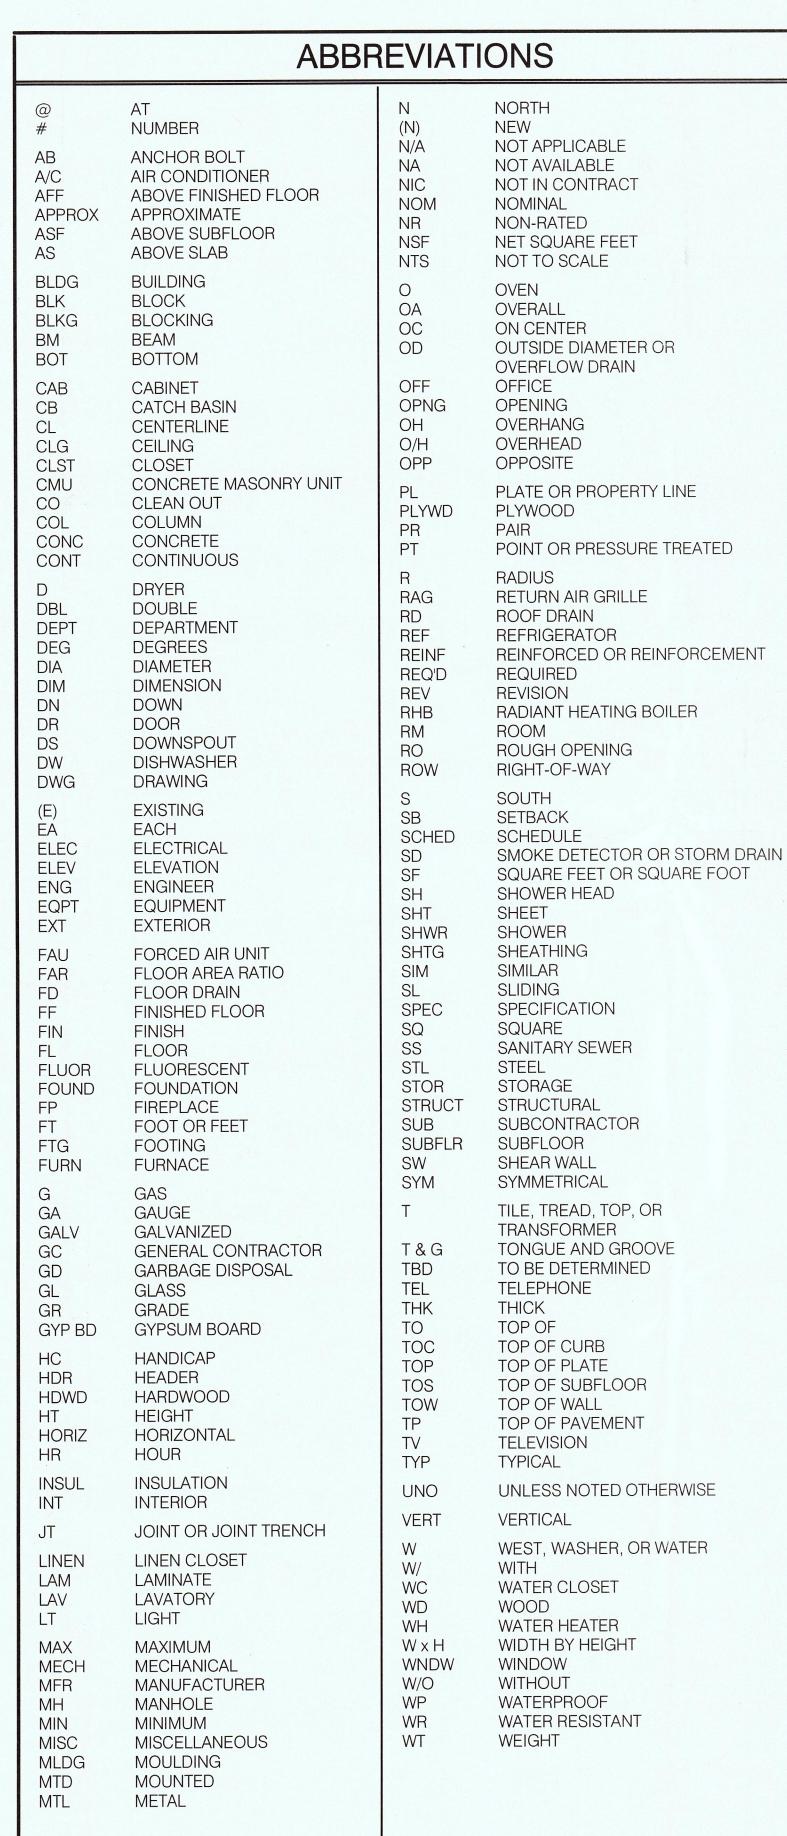

## PROJECT SCOPE SINGLE STORY ADDITION BEHIND (E) GARAGE, AND PARTIAL 2-STORY ADDITION OVER (E) GARAGE, AT (E) SINGLE STORY, SINGLE FAMILY HOME


# **PLANNING DATA**

PROJECT COMMON ADDRESS:

439 VERMONT AVENUE MOSS BEACH, CA 94038 ASSESSOR'S PARCEL NUMBER: 037-133-170 ZONING: R-1/S-17 COMBINING DISTRICT (MIDCOAST

## **BUILDING CODE DATA**

TYPE OF OCCUPANCY: CONSTRUCTION TYPE: BEARING AND NON-BEARING WALLS (LESS THAN 5' FROM PROPERTY LINE): OPENINGS NOT PERMITTED LESS THAN 3' FROM PROPERTY LINE NUMBER OF STORIES: ALL WORK TO CONFORM TO 2013 CRC, CBC, CFC, CPC, CMC, CEC, 2013 CALIFORNIA ENERGY CODE, AND 2013 CGBC

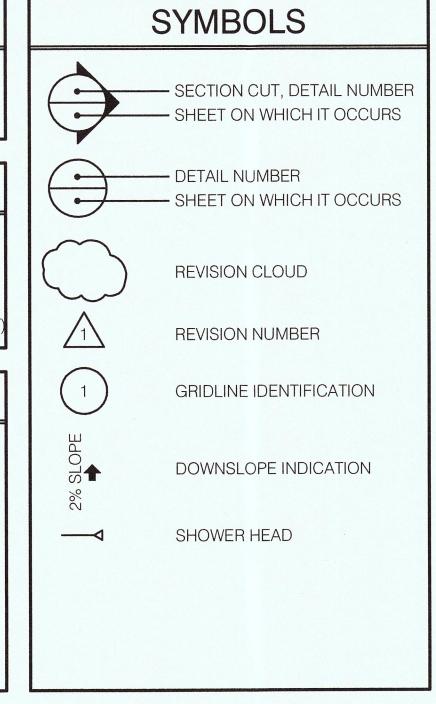

	PROJECT DIREC	10111	
SERVICE	COMPANY	CONTACT	TELEPHONE
APPLICANT / OWNER	-	ANDREW / MELANIE YEE	(650) 728-7805
DRAFTING / DESIGN	BRIAN BRINKMAN DRAFTING & DESIGN	BRIAN BRINKMAN	(650) 922-7993
SURVEYOR	SAVIOR P MICALLEF LAND SURVEYING	SAVIOR MICALLEF	(805) 709-2423
>			

PRO IECT DIRECTORY

PROJECT NOTES	

PROJECT	INFORMATION
LOT SIZE	7,800 SF
(E) LOT COVERAGE	1,987 SF / 7,800 SF = 25.47%
(N) LOT COVERAGE	2,524 SF / 7,800 SF = 32.36%
(E) 1ST FLOOR (TOTAL) LIVING AREA	1,411 SF (CONDITIONED)
(E) FLOOR AREA RATIO (F.A.R.)	1,411 + 576 = 1,987 1,987 / 7,800 = 0.2547 (0.53 MAX)
(N) 1ST FLOOR LIVING AREA	1,999 SF (CONDITIONED)
(N) 2ND FLOOR LIVING AREA	769 SF (CONDITIONED)
(N) TOTAL LIVING AREA	2,768 SF (CONDITIONED)
ADDED LIVING AREA	2,768 - 1,411 = 1,357 SF (CONDITIONED)
(E) GARAGE AREA	576 SF (UN-CONDITIONED)
(N) GARAGE AREA	494 SF (UN-CONDITIONED)
(N) FLOOR AREA RATIO (F.A.R.)	1,999 + 769 + 494 = 3,262 3,262 / 7,800 = 0.4182 (0.53 MAX)

## DRAWING INDEX

ARCHITECTU	URAL
A0.0	TITLE SHEET
A1.0	ORIGINAL SITE SURVEY
A1.1	SITE PLAN
A2.1	EXISTING FLOOR PLAN
A2.2	EXISTING ROOF PLAN
A3.1	PROPOSED 1ST FLOOR PLAN
A3.2	PROPOSED 2ND FLOOR / LOWER ROOF PLAN
A3.3	PROPOSED UPPER ROOF PLAN
A4.1	EXISTING AND PROPOSED FRONT (SOUTHEAST) ELEVATIONS
A4.2	EXISTING AND PROPOSED LEFT (SOUTHWEST) ELEVATIONS
A4.3	EXISTING AND PROPOSED REAR (NORTHWEST) ELEVATIONS
A4.4	EXISTING AND PROPOSED RIGHT (NORTHEAST) ELEVATIONS

648 Navarre Drive Pacifica, CA 94044 (650) 922-7993

SRIAN BRINKMAN ORAFTING & DESIGN

	A	V		
	I		1	

DESCRIPTION	PRE-APPLICATION MEETING	PLANNING SUBMITTAL	PLANNING RESUBMITTAL		
DATE	07/01/15	07/15/15	04/12/16		
REV	0	_	2		
	Barrier Mar			_	

1-STORY AD GARAGE AN ADDITION AE  $\Xi$ AMIL

SINGLE

SHEET TITLE:

TITLE SHEET

RECEIVED

San Mateo County Planning and Building Department


MAY 23 2016

PLN2015-00289

A0.0

N 28'42'00" E miniminimini, SINGLE STOREY RESIDENCE FF=100.69' gmmmmmmmx. GARAGE FF=99.10' Ammunimin M N 28'42'00" E 75.00 BENCHMARK STATEMENT: THE ELEVATIONS SHOWN ARE ON AN ASSUMED DATUM. **VERMONT AVENUE** (50' WIDE) SAVIOR P. MICALLEF LAND SURVEYOR, LS 8289 (805) 709-2423

SURVEYOR'S STATEMENT:
THIS SITE SURVEY WAS MADE BY ME OR UNDER MY
DIRECTION ON THE GROUND AND REPRESENTS
MEASUREMENTS MADE MAY 2015. THE BOUNDARY SHOWN IS
A RECORD BOUNDARY ONLY. A TITLE REPORT WAS NOT
PROVIDED TO THE SURVEYOR BY THE CLIENT. NO PROPERTY
CORNERS WERE FOUND ON THE SUBJECT PROPERTY AND
NO WARRANTY IS MADE ABOUT THE BOUNDARY SHOWN. NO
EASEMENTS ARE SHOWN OR PLOTTED. EASEMENTS MAY
EXIST.

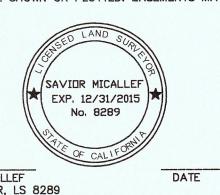

AVENUE -036706)


439 VERMONT , DOC. NO. 98-


0F 170

SURVE)

SITE APN 0

OF

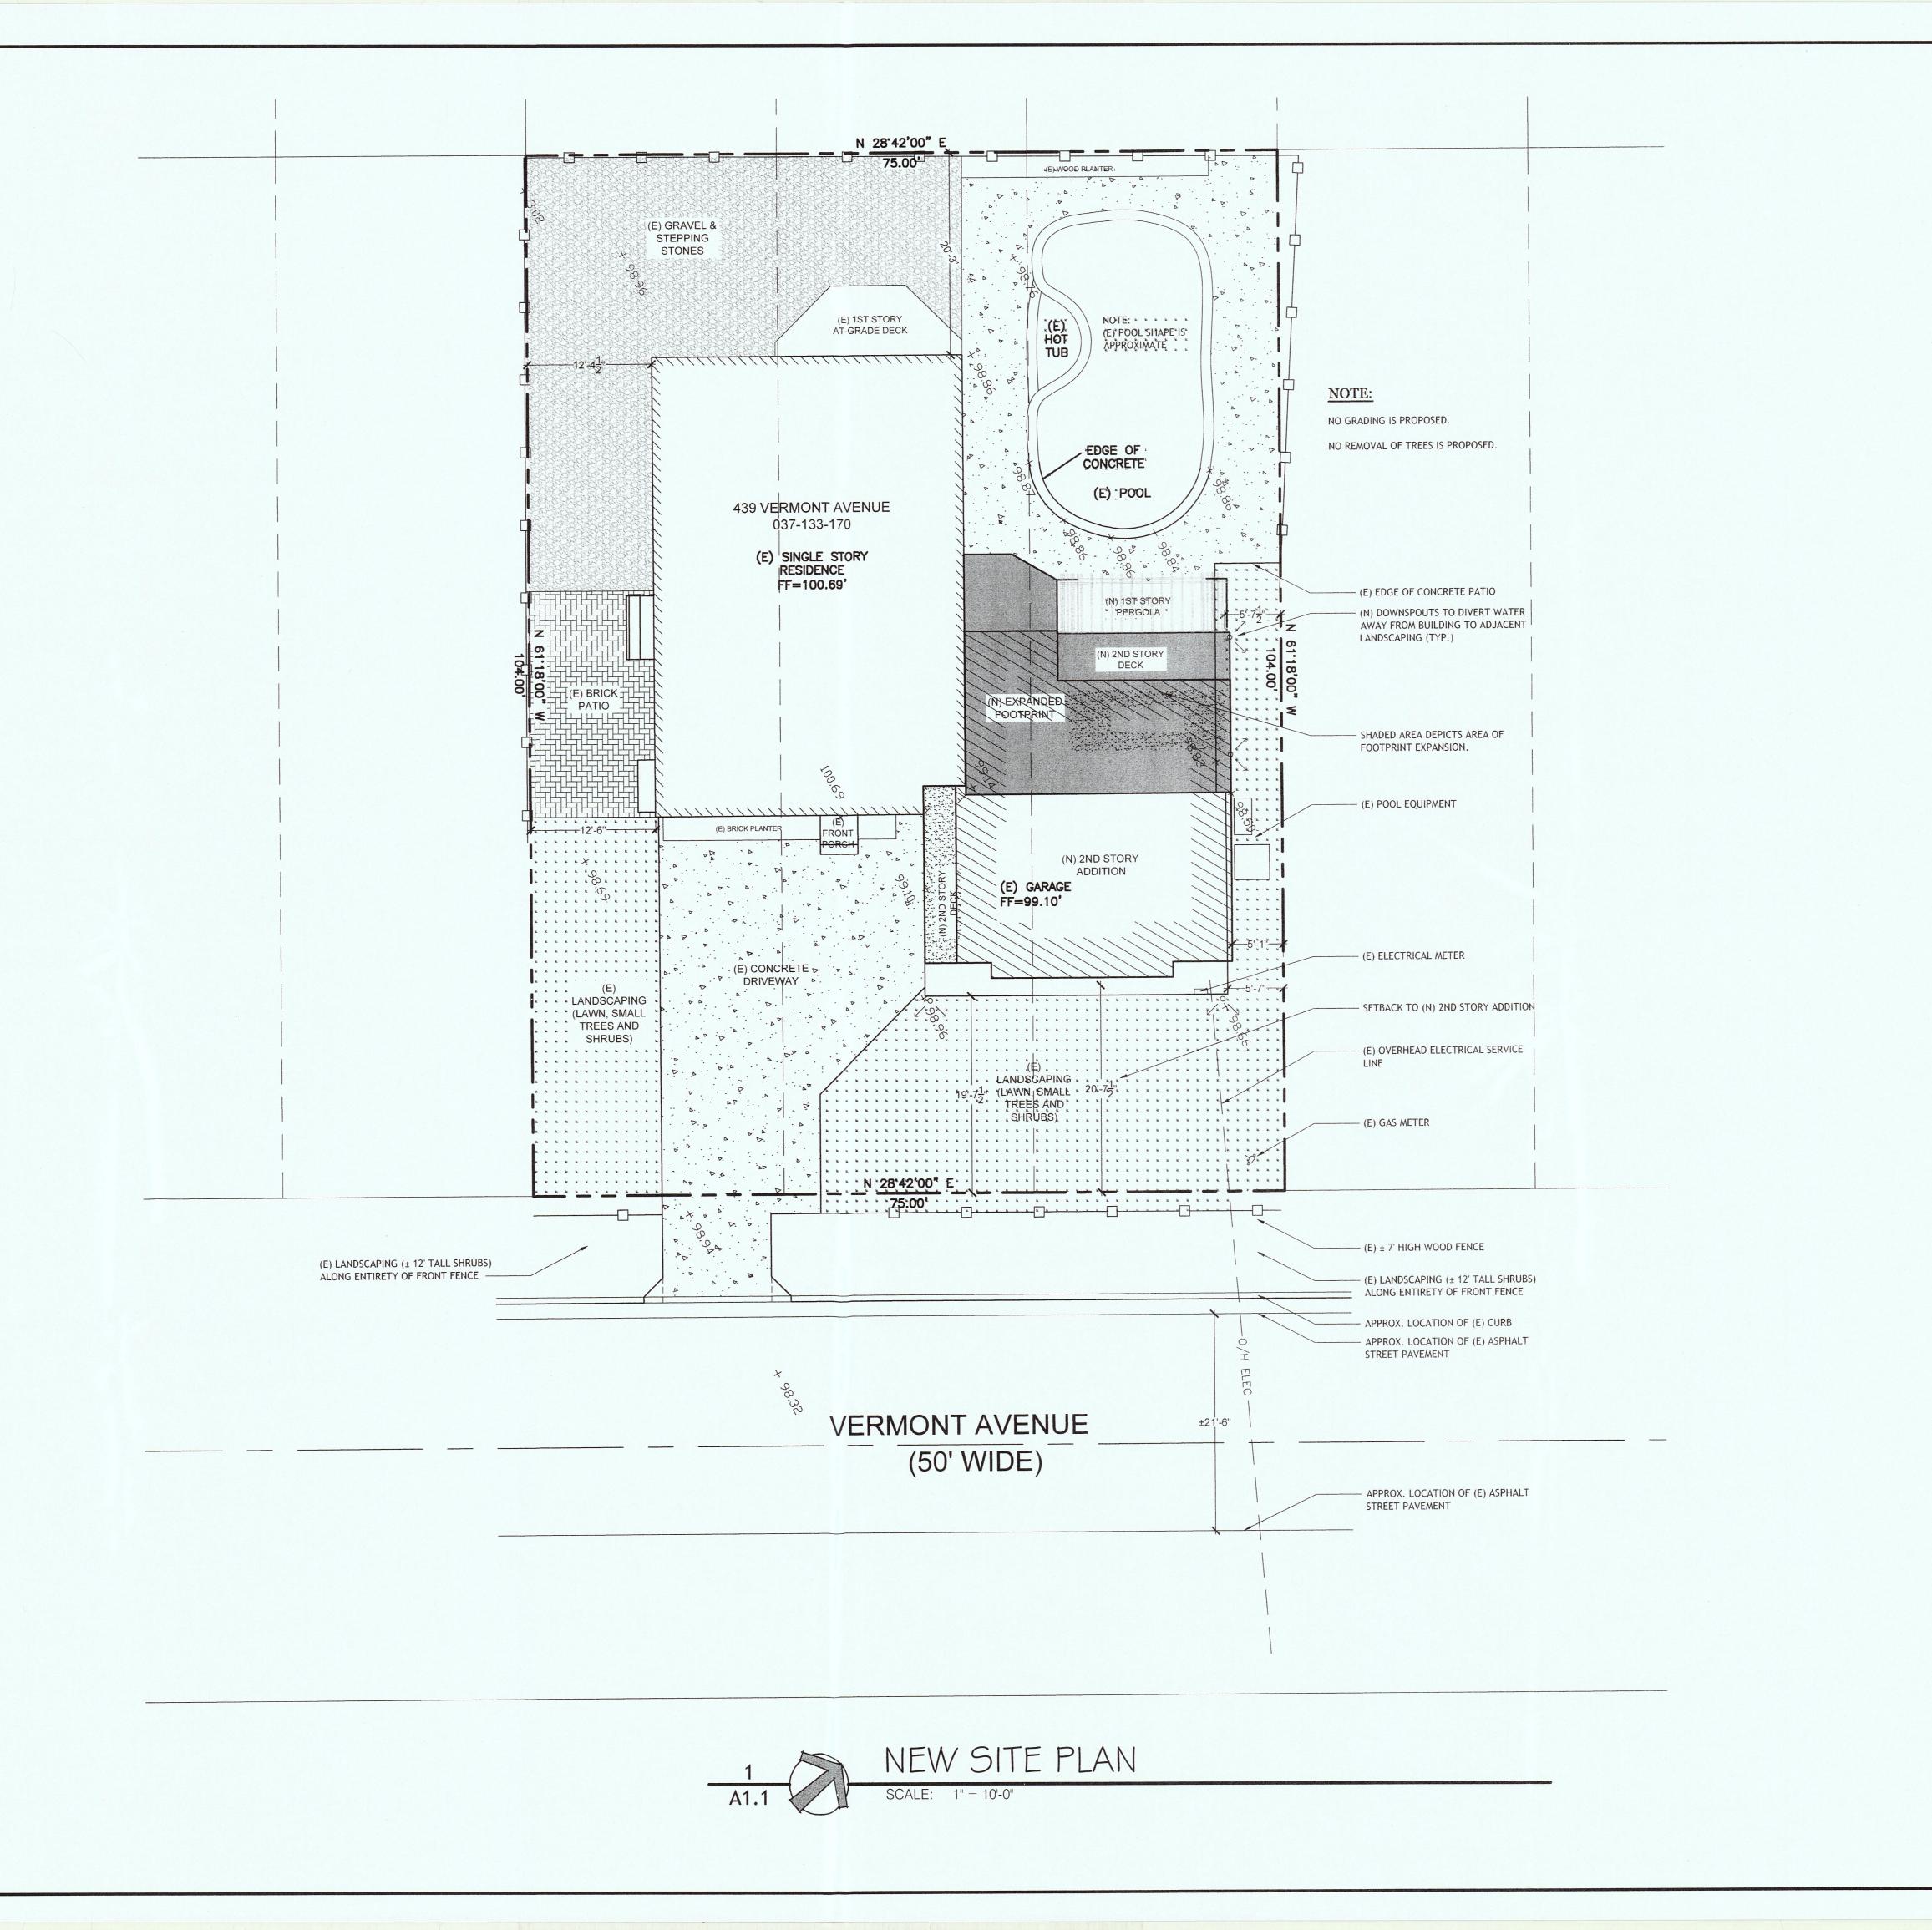

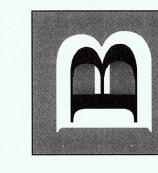

07/01/15 07/15/15 04/12/16

OME AMILY SINGL

SHEET TITLE: NEW SITE PLAN

SHEET:

A1.1

- MAX FLOW RATE OF KITCHEN FAUCETS SHALL BE 1.8 GPM
- ALL TOILETS SHALL BE MAX 1.28 GPF

SILL A MAX. OF 44" ABOVE FINISHED FLOOR

**EGRESS NOTE:** 


AT LEAST ONE WINDOW IN EACH BEDROOM SHALL MEET THE

- FOLLOWING REQUIREMENTS:
- MIN. 5.7 SF IN OVERALL SIZE MIN. 24" CLEAR OPENING HEIGHT
- MIN. 20" CLEAR OPENING WIDTH

 MAX FLOW RATE OF SHOWERHEADS SHALL BE 2.0 GPM MAX FLOW RATE OF LAVATORY FAUCETS SHALL BE 1.5 GPM

EXISTING WALL OR DECK RAILING TO REMAIN PROPOSED STUD WALL PROPOSED 42" HIGH STUD WALL EXISTING / PROPOSED CONCRETE WALL

WALL LEGEND

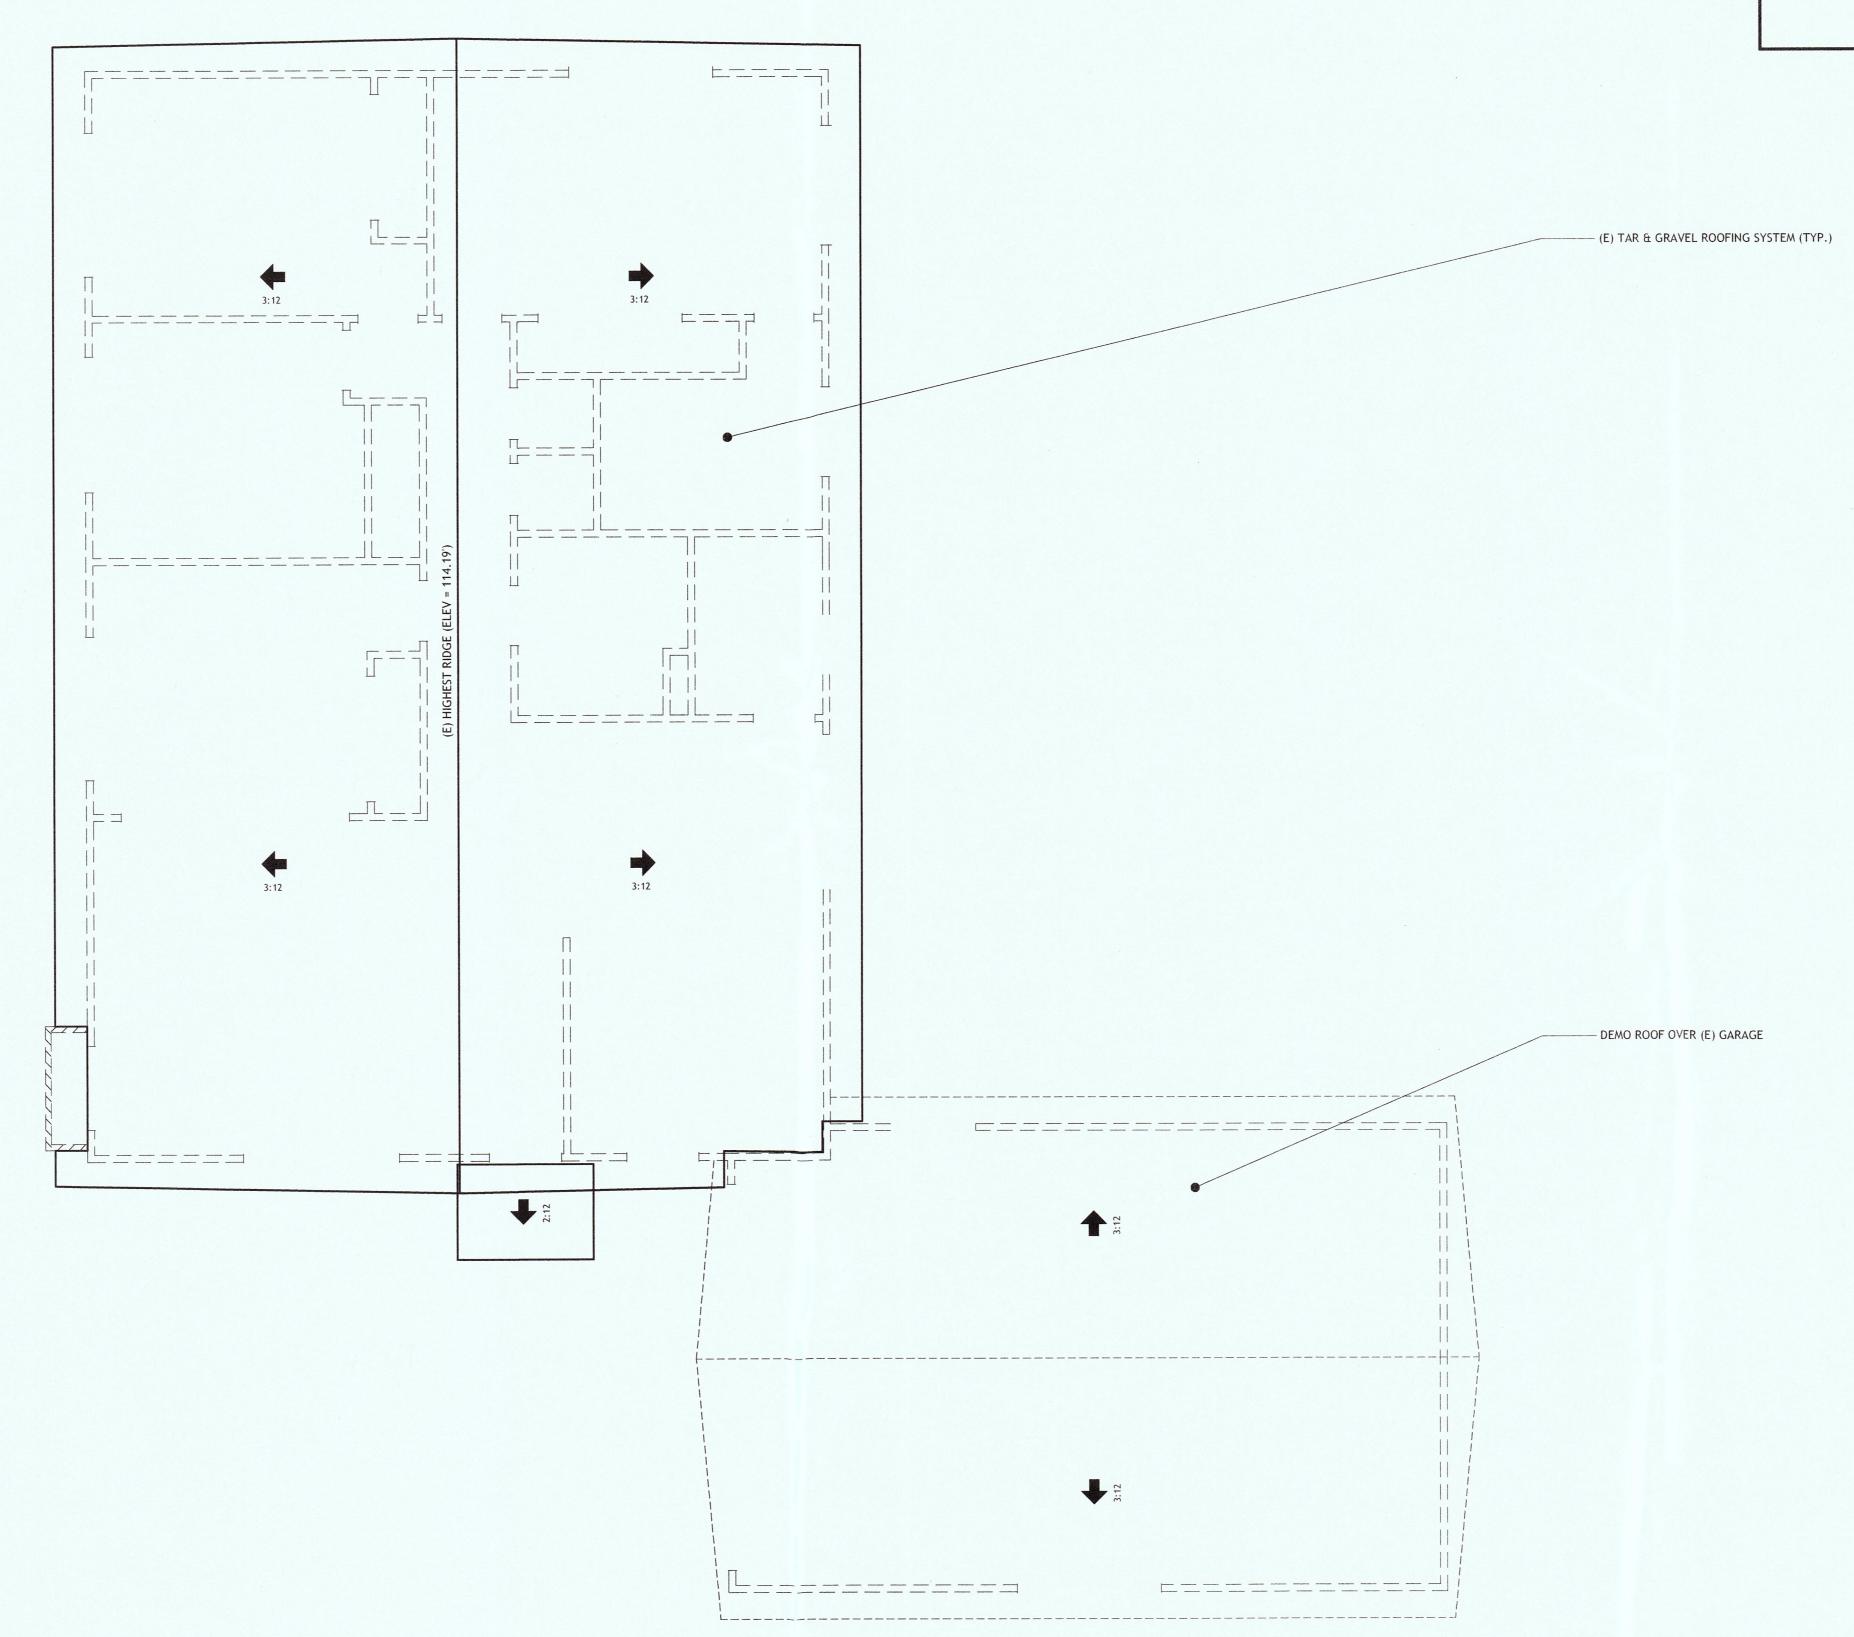

EXISTING ROOF PLAN

BRIAN BRINKMAN DRAFTING & DESIGN



15	PRE-APPLICATION MEETING
15	PLANNING SUBMITTAL
16	PLANNING RESUBMITTAL

		r
O SINGLE FAMILY HOME	MILY HOME:	
NOE		
	PROJECT SCOPE:	
	(T) CIVILIACINOITICA VACEO	
	-VIORY ADDITION BEHIND (E)	
	GARAGE AND 2ND STORY	
00000		

SHEET TITLE: EXISTING ROOF PLAN

A2.2





- MAX FLOW RATE OF SHOWERHEADS SHALL BE 2.0 GPM
- MAX FLOW RATE OF LAVATORY FAUCETS SHALL BE 1.5 GPM
- MAX FLOW RATE OF KITCHEN FAUCETS SHALL BE 1.8 GPM ALL TOILETS SHALL BE MAX 1.28 GPF

### EGRESS NOTE:

AT LEAST ONE WINDOW IN EACH BEDROOM SHALL MEET THE FOLLOWING REQUIREMENTS:

- MIN. 5.7 SF IN OVERALL SIZE
- MIN. 24" CLEAR OPENING HEIGHT

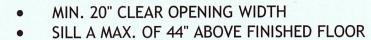

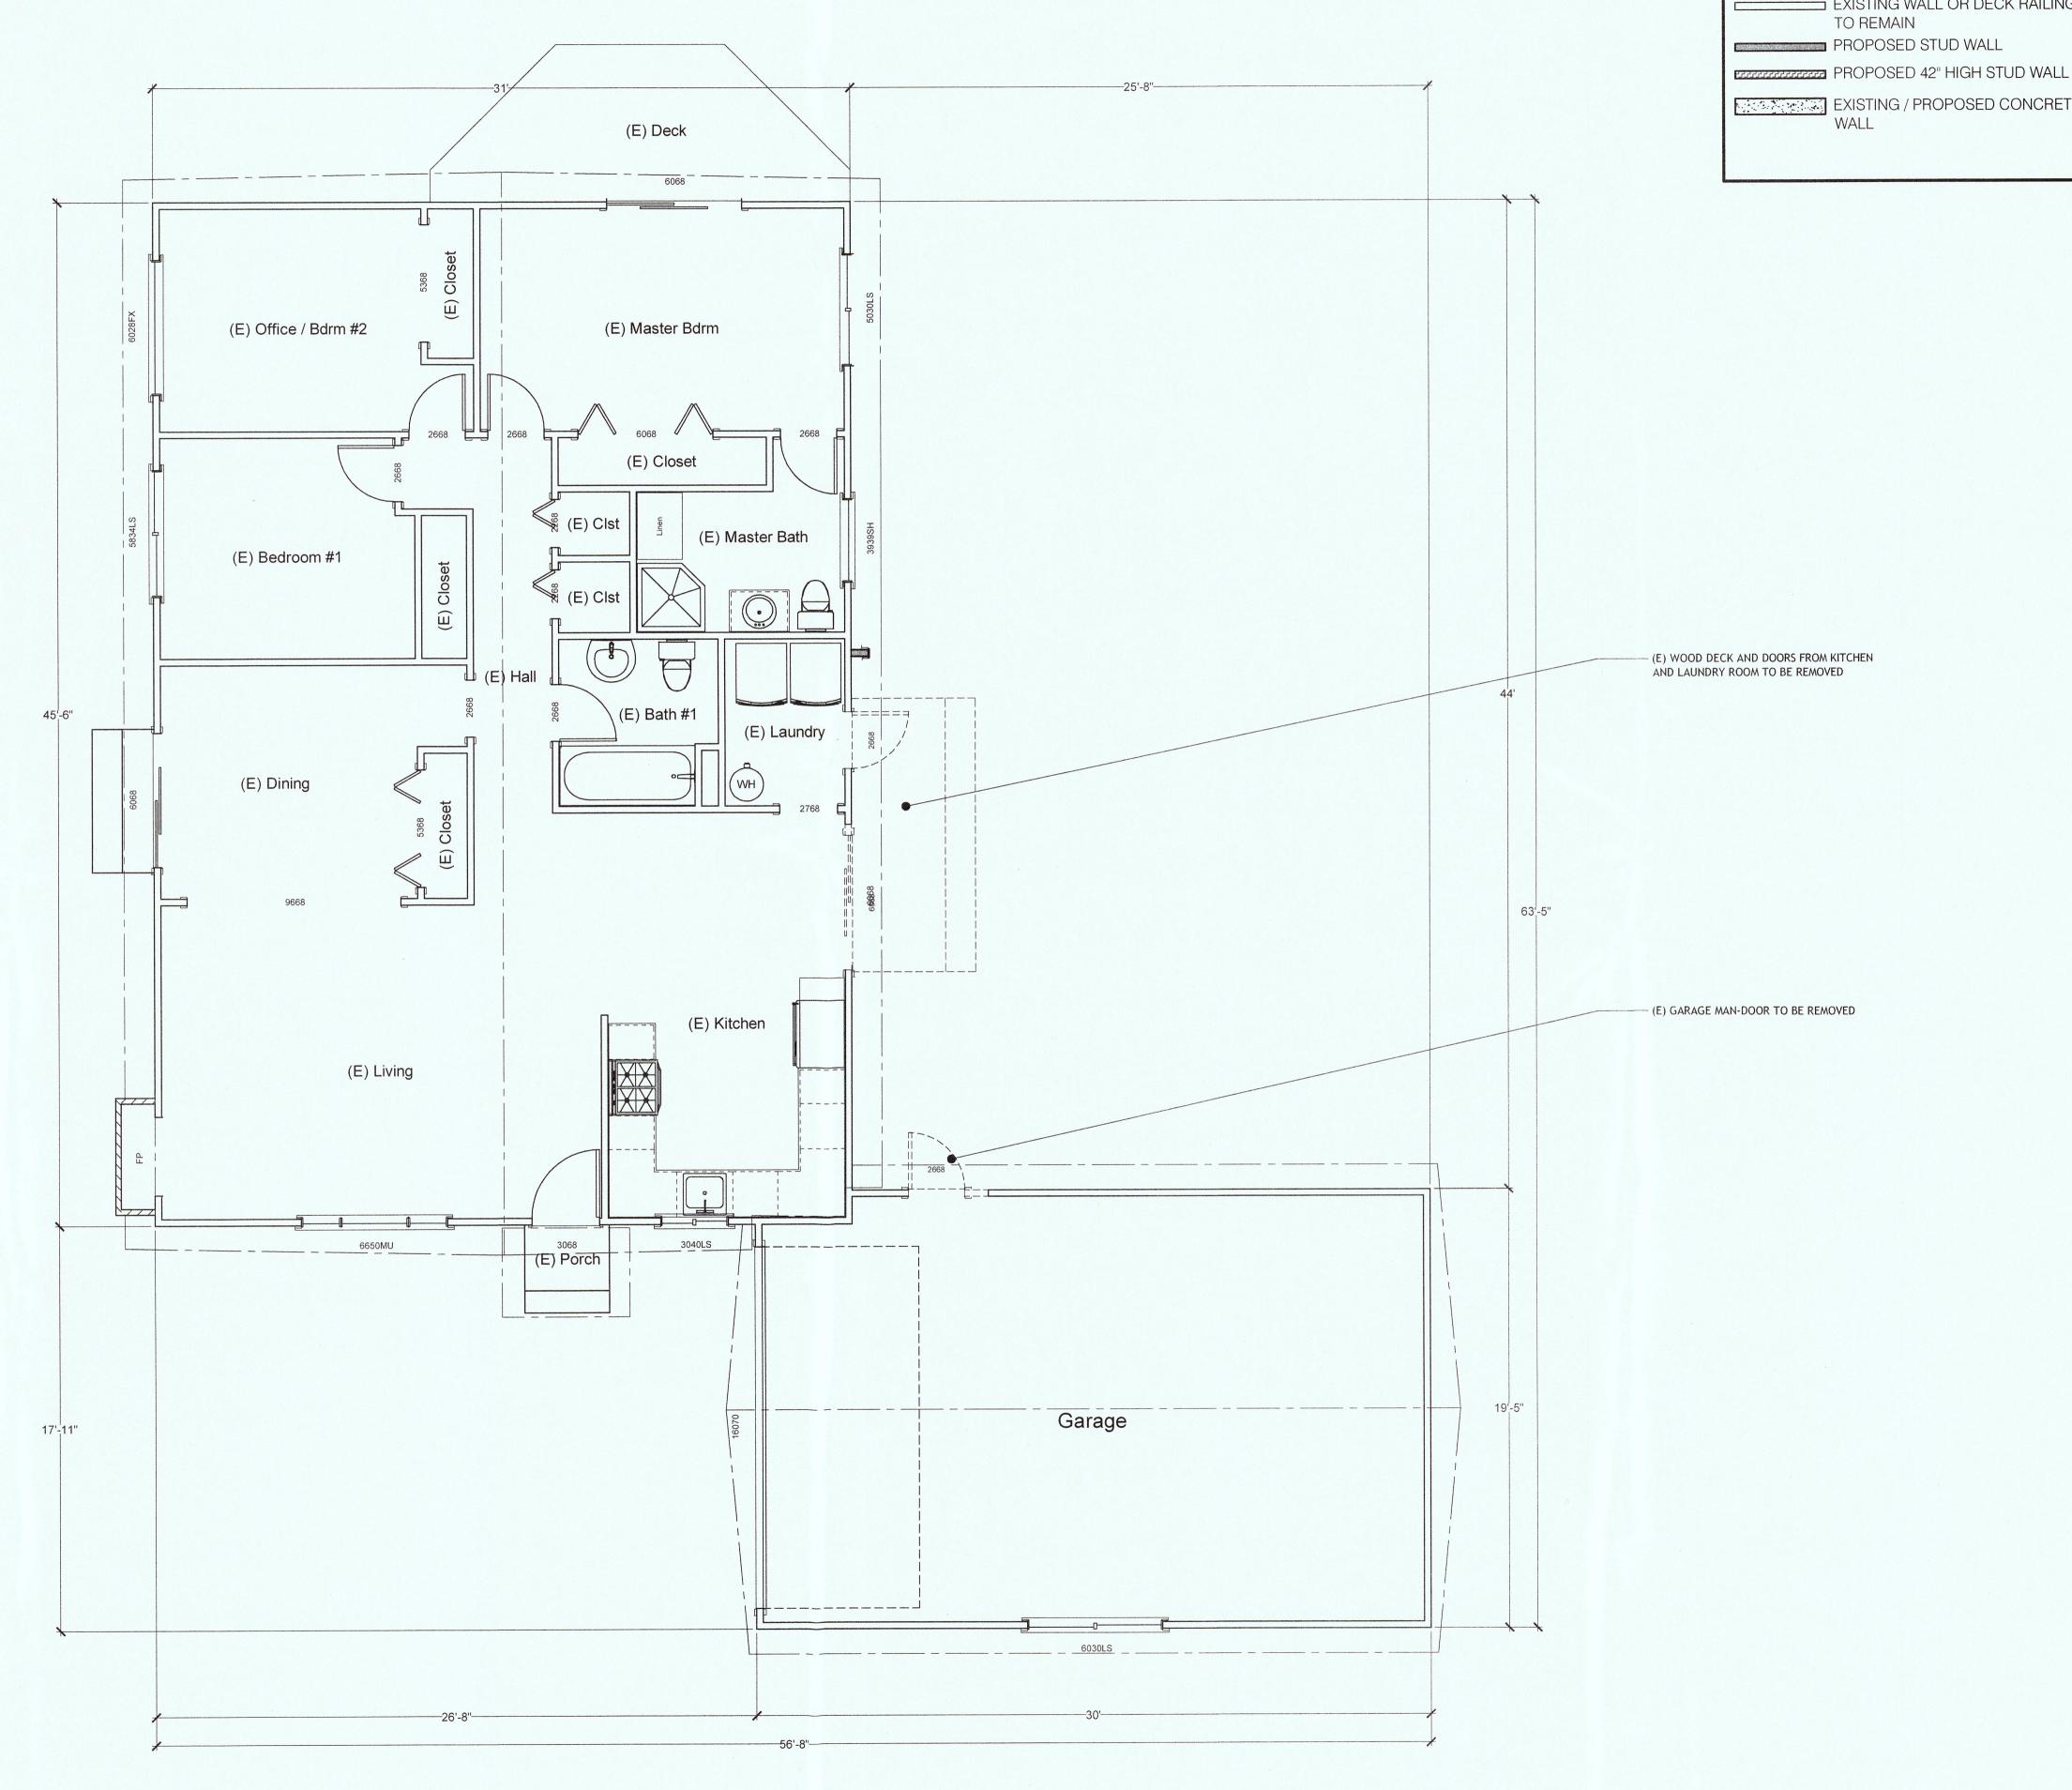

EXISTING FLOOR PLAN

WALL LEGEND

EXISTING WALL OR DECK RAILING

PROPOSED STUD WALL

EXISTING / PROPOSED CONCRETE

BRIAN BRINKMAN DRAFTING & DESIGN

07/01/15 2 | 0 | 匠

DDITION BEHIND ( ND 2ND STORY ABOVE (E) GARAG

FAMILY

- AVENUE , CA 94038

ADDITION TO SINGLE YEE RESIDENCE

SHEET TITLE: EXISTING FLOOR PLAN

A2.1




- MAX FLOW RATE OF SHOWERHEADS SHALL BE 2.0 GPM
- MAX FLOW RATE OF LAVATORY FAUCETS SHALL BE 1.5 GPM MAX FLOW RATE OF KITCHEN FAUCETS SHALL BE 1.8 GPM
- ALL TOILETS SHALL BE MAX 1.28 GPF

#### **EGRESS NOTE:**

AT LEAST ONE WINDOW IN EACH BEDROOM SHALL MEET THE FOLLOWING REQUIREMENTS:

- MIN. 5.7 SF IN OVERALL SIZE
- MIN. 24" CLEAR OPENING HEIGHT
- MIN. 20" CLEAR OPENING WIDTH
- SILL A MAX. OF 44" ABOVE FINISHED FLOOR

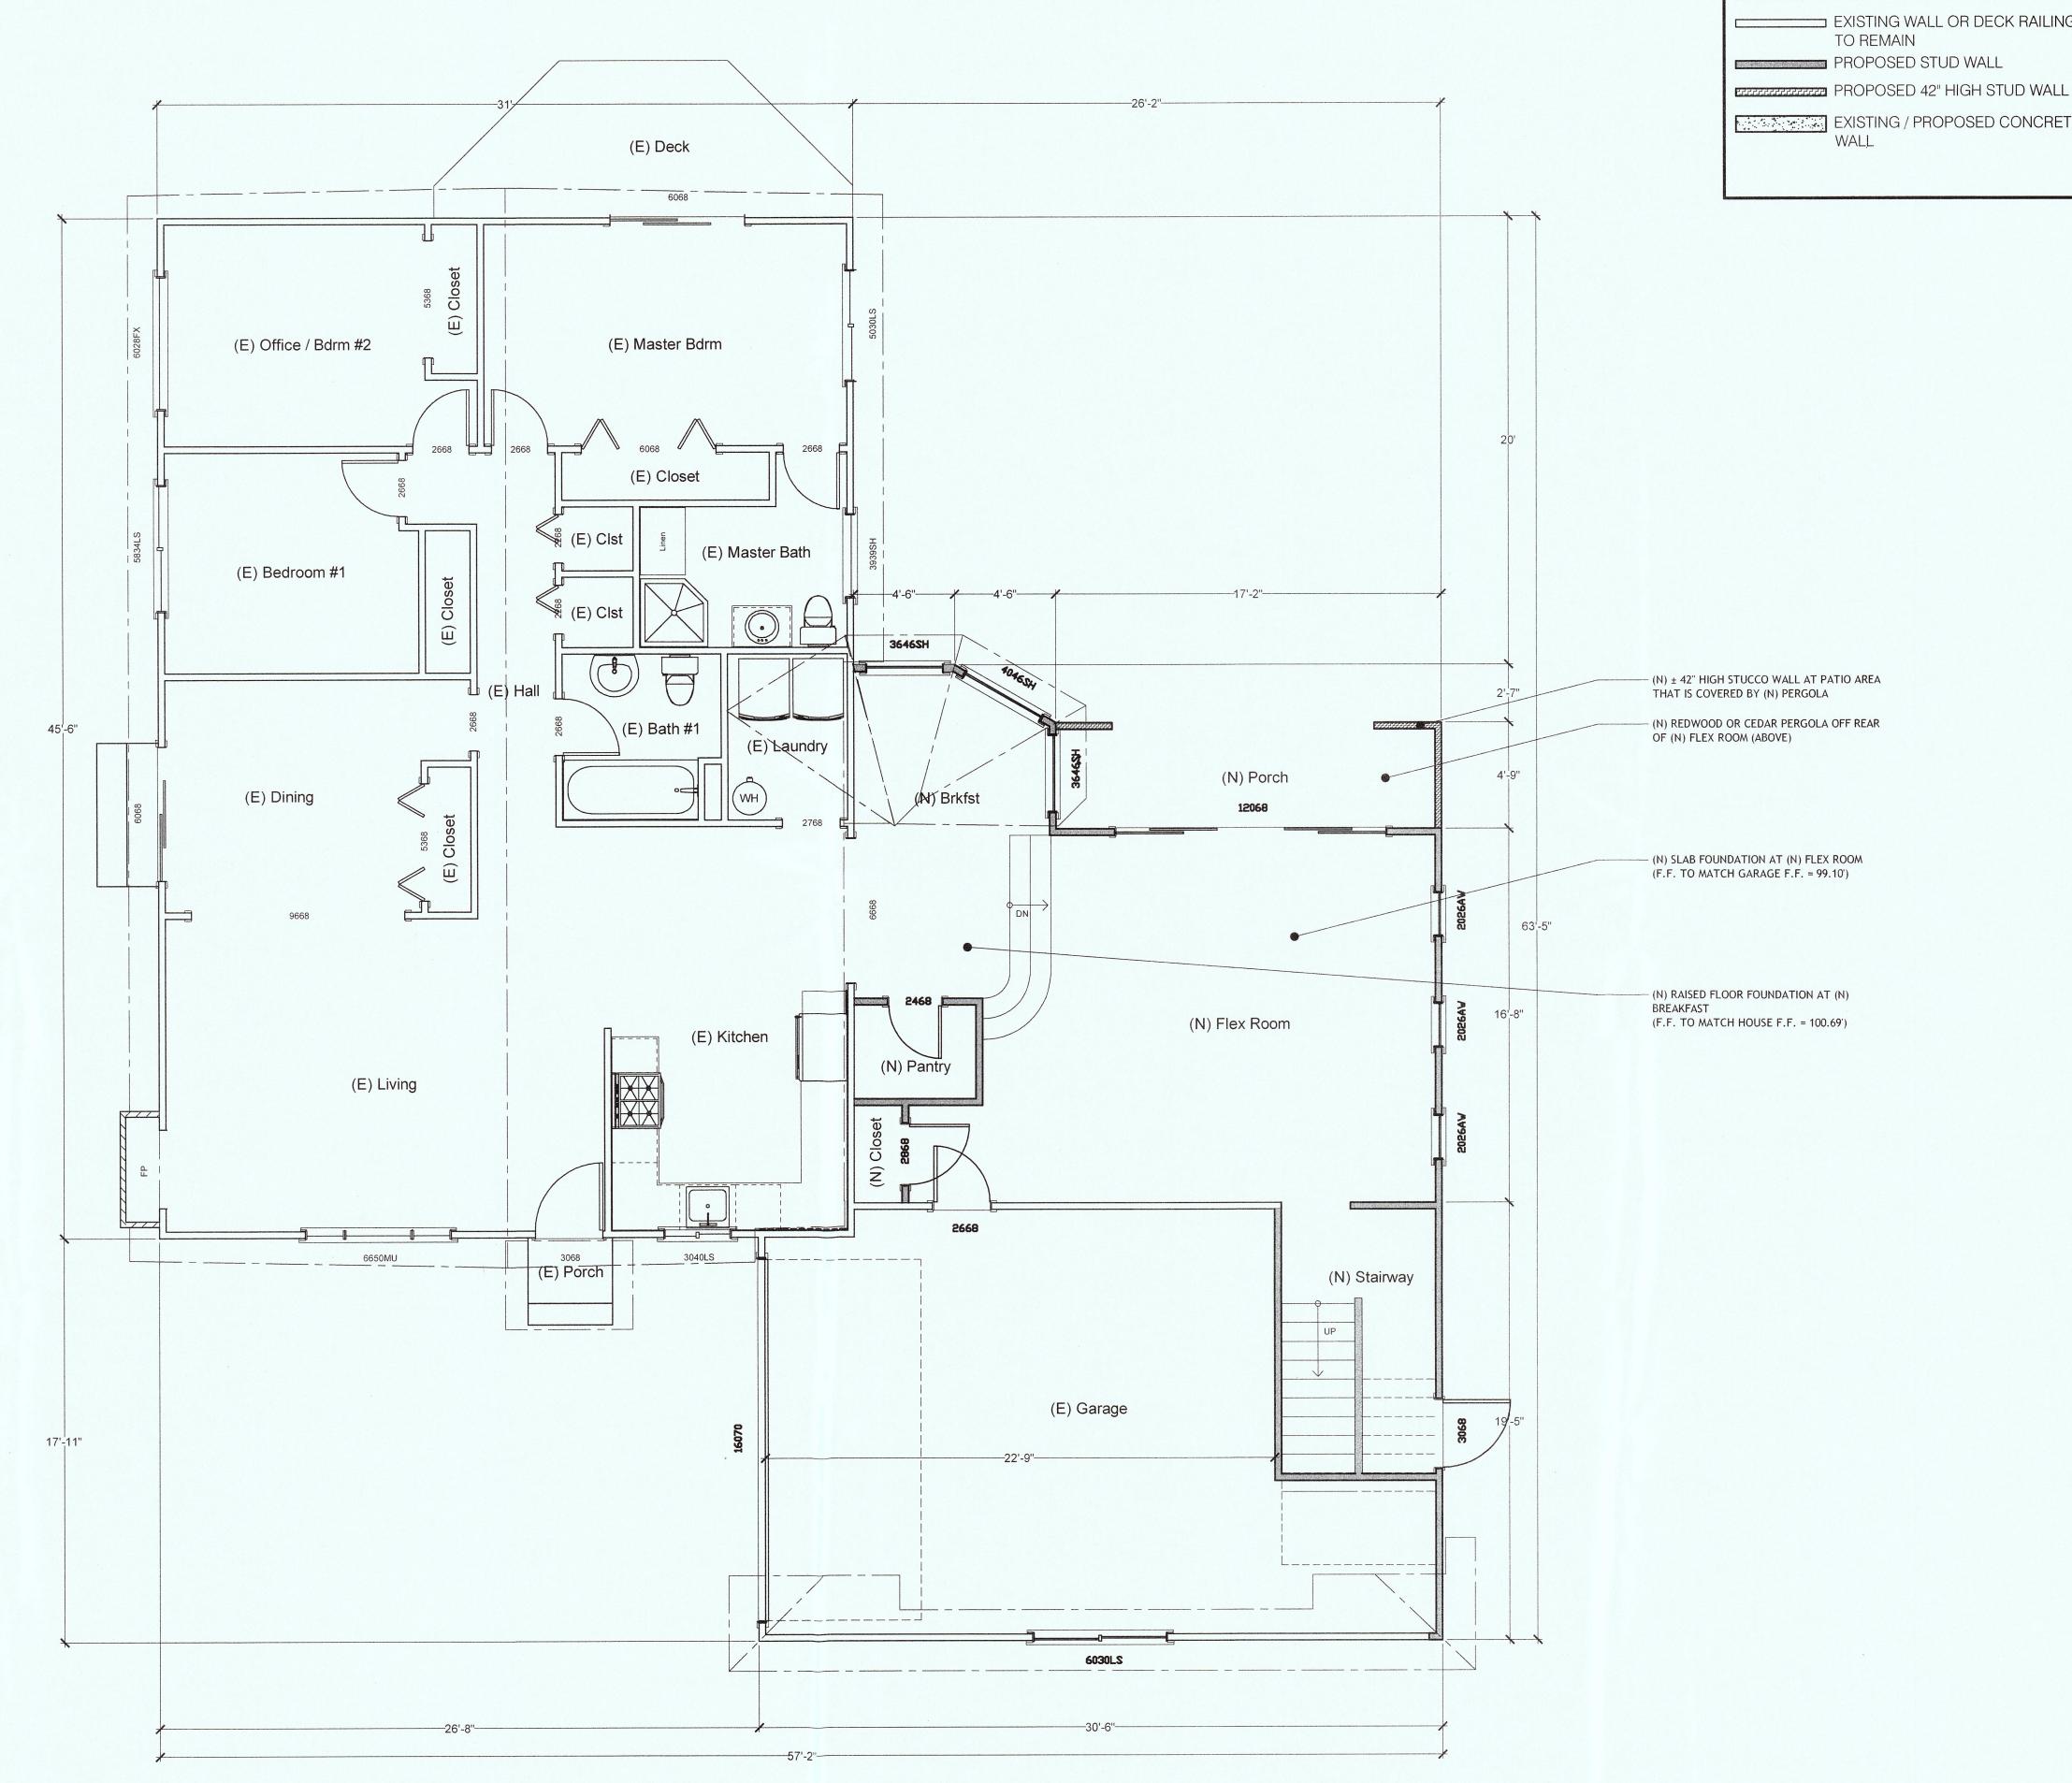

PROPOSED IST FLOOR PLAN

WALL LEGEND

EXISTING WALL OR DECK RAILING

EXISTING / PROPOSED CONCRETE

PRE-APPLICATION MEETING	PLANNING SUBMITTAL	PLANNING RESUBMITTAL	
07/01/15	07/15/15	04/12/16	
0	-	2	

FAMILY

(E)

ADDITION TO SINGLE YEE RESIDENCE

SHEET TITLE: PROPOSED 1ST FLOOR PLAN

A3.1

- MAX FLOW RATE OF SHOWERHEADS SHALL BE 2.0 GPM
- MAX FLOW RATE OF LAVATORY FAUCETS SHALL BE 1.5 GPM
- MAX FLOW RATE OF KITCHEN FAUCETS SHALL BE 1.8 GPM ALL TOILETS SHALL BE MAX 1.28 GPF

**EGRESS NOTE:** 


AT LEAST ONE WINDOW IN EACH BEDROOM SHALL MEET THE


FOLLOWING REQUIREMENTS:

- MIN. 5.7 SF IN OVERALL SIZE MIN. 24" CLEAR OPENING HEIGHT
- MIN. 20" CLEAR OPENING WIDTH
- SILL A MAX. OF 44" ABOVE FINISHED FLOOR



BRIAN BRINKMAN DRAFTING & DESIGN PROPOSED 42" HIGH STUD WALL EXISTING / PROPOSED CONCRETE

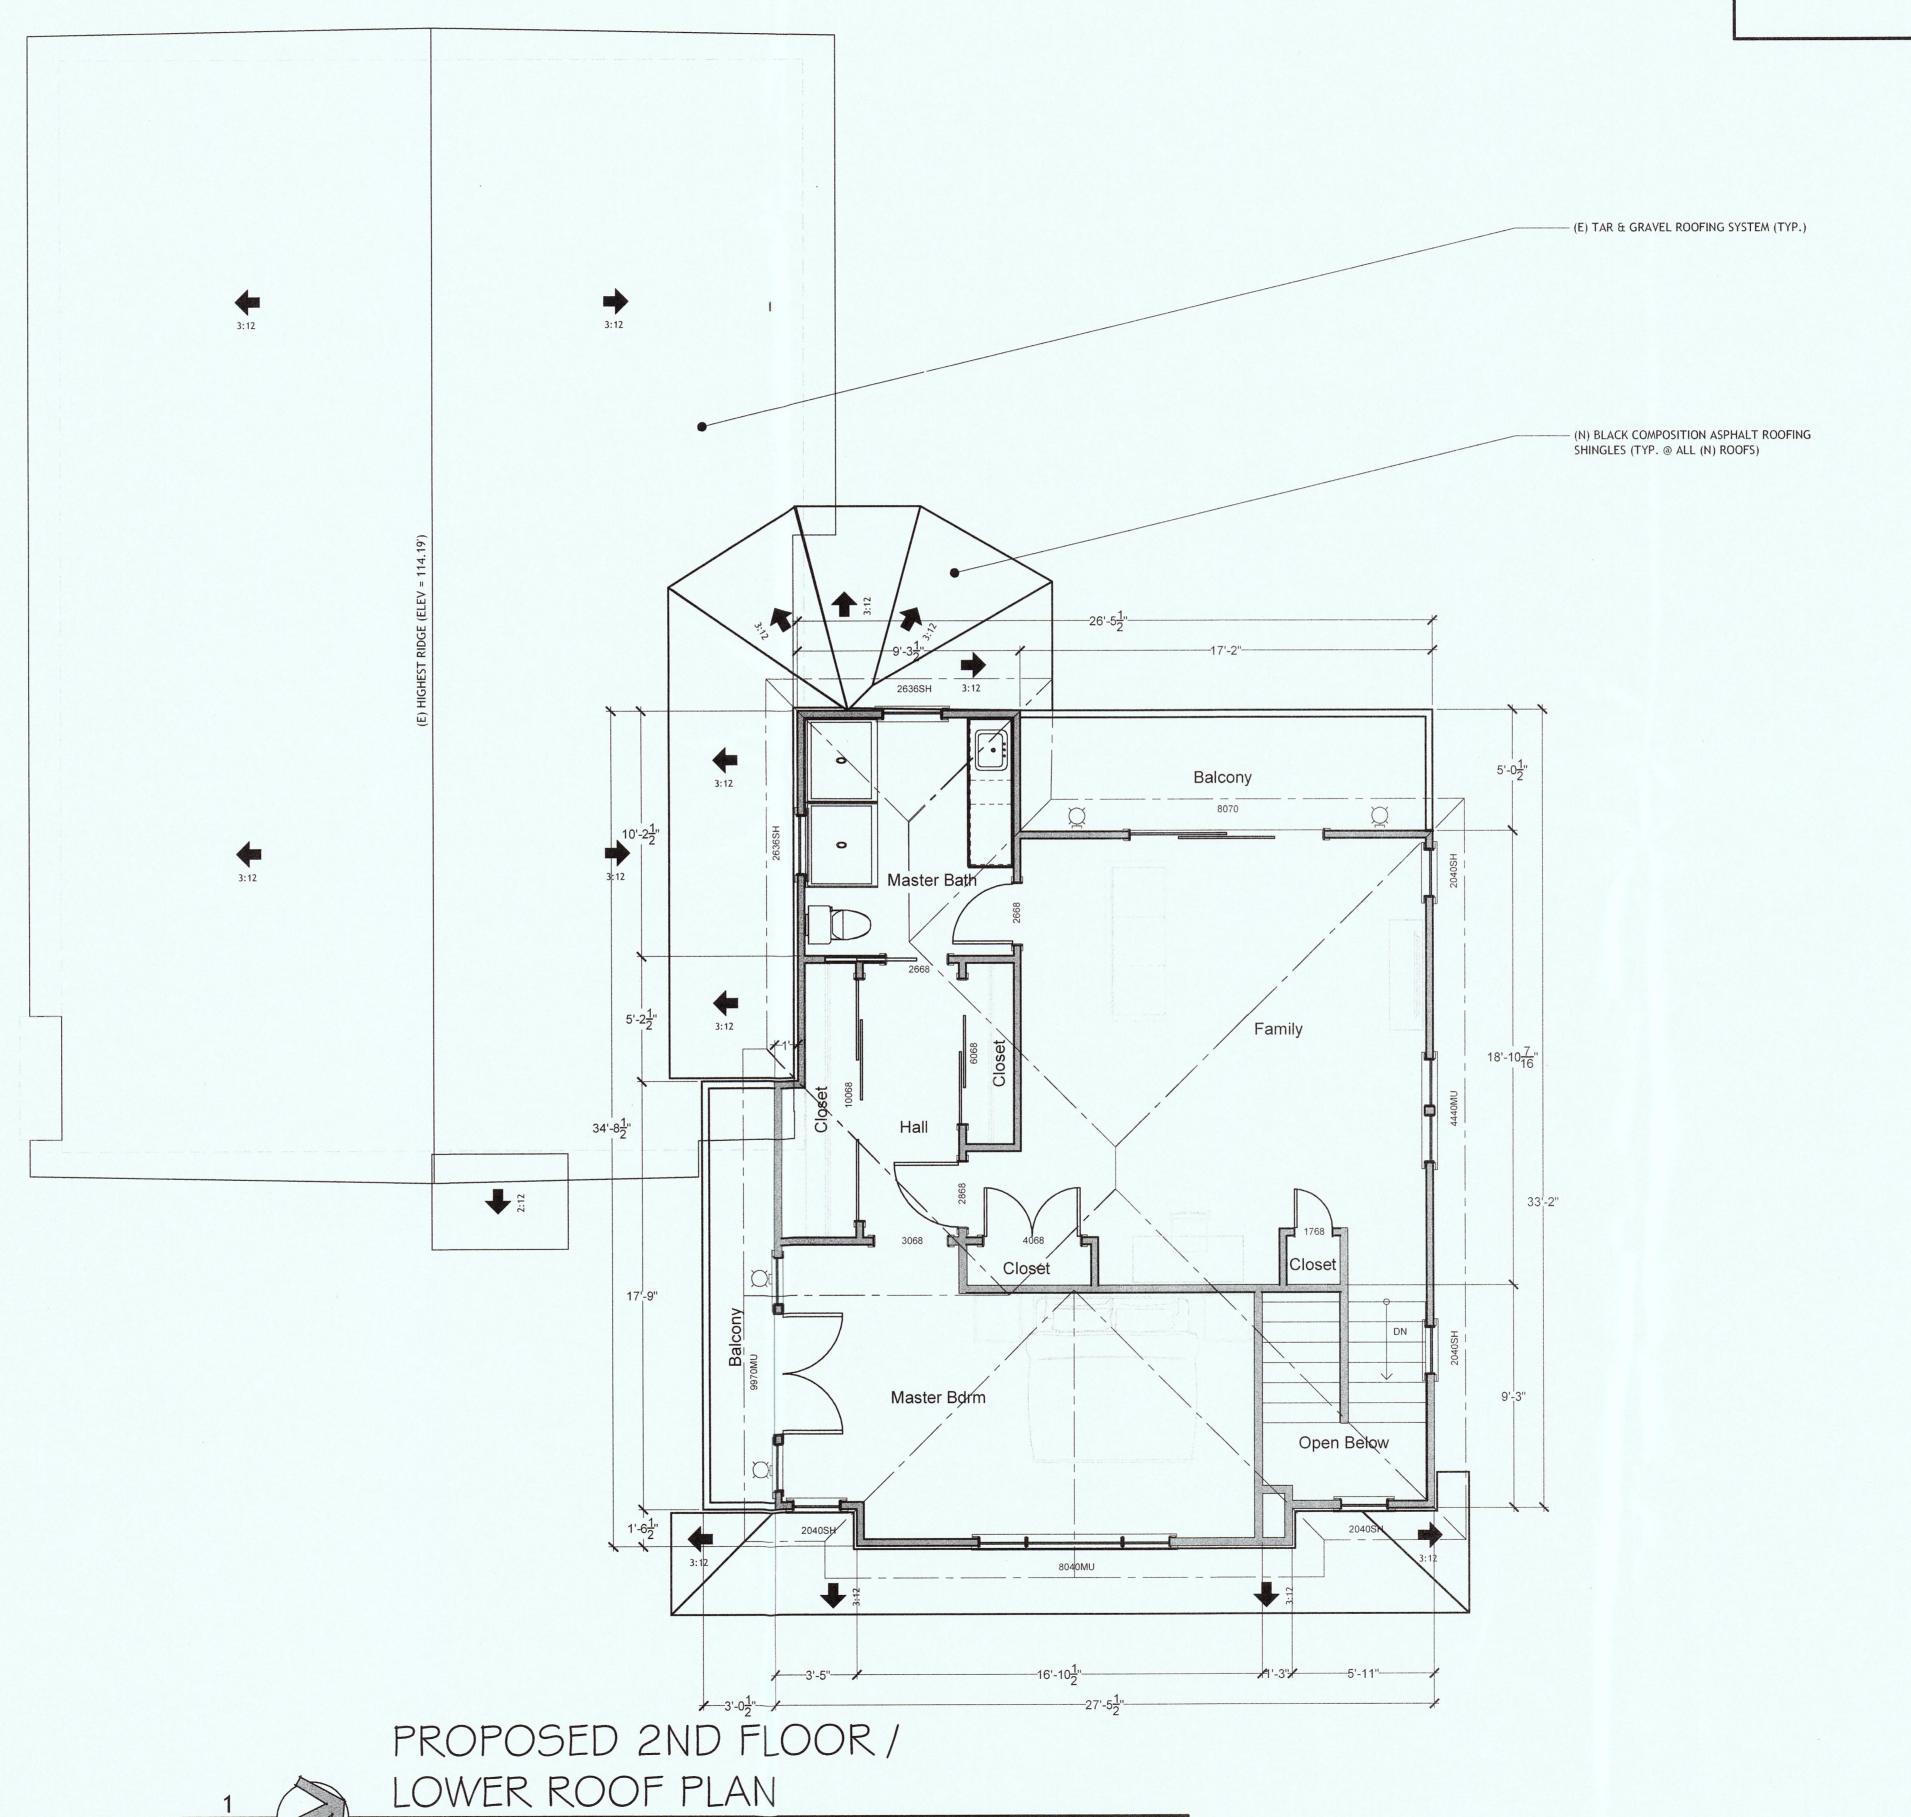

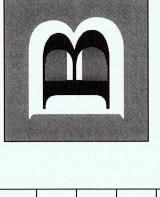

ADDITION TO SINGLE FAMILY HOME:  YEE RESIDENCE  PROJECT SCOPE:  1-STORY ADDITION BEHIND (E)  1-STORY ADDITION BEHIND (E)	07/01/15	PRE-APPLICATION MEETING PLANNING SUBMITTAL PLANNING RESUBMITTAL
--	----------	---

2ND FLOOR / LOWER ROOF PLAN


A3.2


- MAX FLOW RATE OF SHOWERHEADS SHALL BE 2.0 GPM
- MAX FLOW RATE OF LAVATORY FAUCETS SHALL BE 1.5 GPM MAX FLOW RATE OF KITCHEN FAUCETS SHALL BE 1.8 GPM
- ALL TOILETS SHALL BE MAX 1.28 GPF

EGRESS NOTE: AT LEAST ONE WINDOW IN EACH BEDROOM SHALL MEET THE


FOLLOWING REQUIREMENTS:

- MIN. 5.7 SF IN OVERALL SIZE
- MIN. 24" CLEAR OPENING HEIGHT MIN. 20" CLEAR OPENING WIDTH
- SILL A MAX. OF 44" ABOVE FINISHED FLOOR

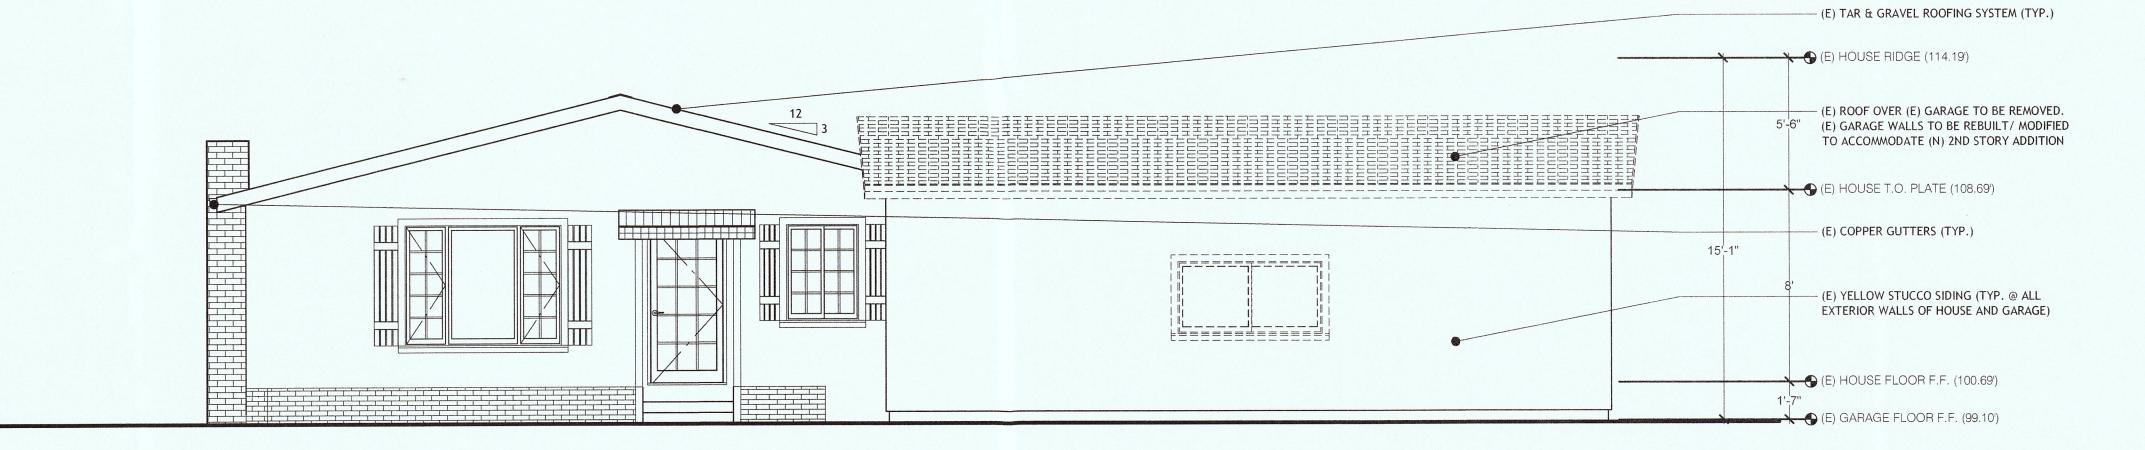

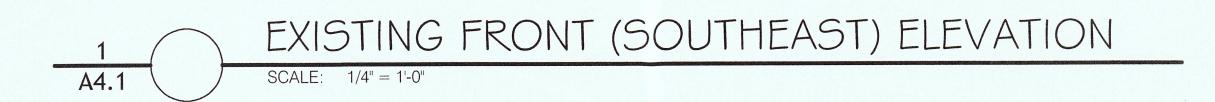



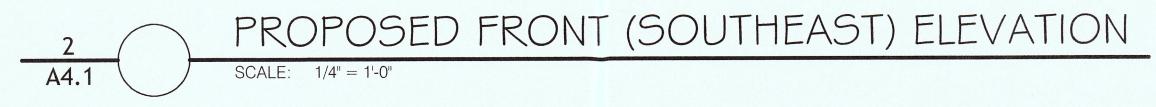



		7 V	UAIE	DESCRIPTION	
FAMILY HOME	JME :	0	0 07/01/15	PRE-APPLICATION MEETING	
		-	1 07/15/15	PLANNING SUBMITTAL	
PROJECT SCOPE:		2	2 04/12/16	PLANNING RESUBMITTAL	
GARAGE AND 2ND STO	1-STORY ADDITION BEHIND (E) GARAGE AND 2ND STORY				
ADDITION A	ADDITION ABOVE (E) GARAGE				

ADDITION TO SINGLE YEE RESIDENCE SHEET TITLE:

EXISTING AND PROPOSED FRONT (SOUTHEAST) ELEVATIONS

AVENUE , CA 94038

A4.1

- MAX FLOW RATE OF SHOWERHEADS SHALL BE 2.0 GPM
- MAX FLOW RATE OF LAVATORY FAUCETS SHALL BE 1.5 GPM
- MAX FLOW RATE OF KITCHEN FAUCETS SHALL BE 1.8 GPM
   ALL TOILETS SHALL BE MAX 1.28 GPF

#### **EGRESS NOTE**

AT LEAST ONE WINDOW IN EACH BEDROOM SHALL MEET THE FOLLOWING REQUIREMENTS:

- MIN. 5.7 SF IN OVERALL SIZE
- MIN. 24" CLEAR OPENING HEIGHT
- MIN. 20" CLEAR OPENING WIDTH
  SILL A MAX. OF 44" ABOVE FINISHED FLOOR

WALL LEGEND


EXISTING WALL TO BE REMOVED

EXISTING WALL OR DECK RAILING
TO REMAIN

PROPOSED STUD WALL

PROPOSED 42" HIGH STUD WALL

EXISTING / PROPOSED CONCRETE

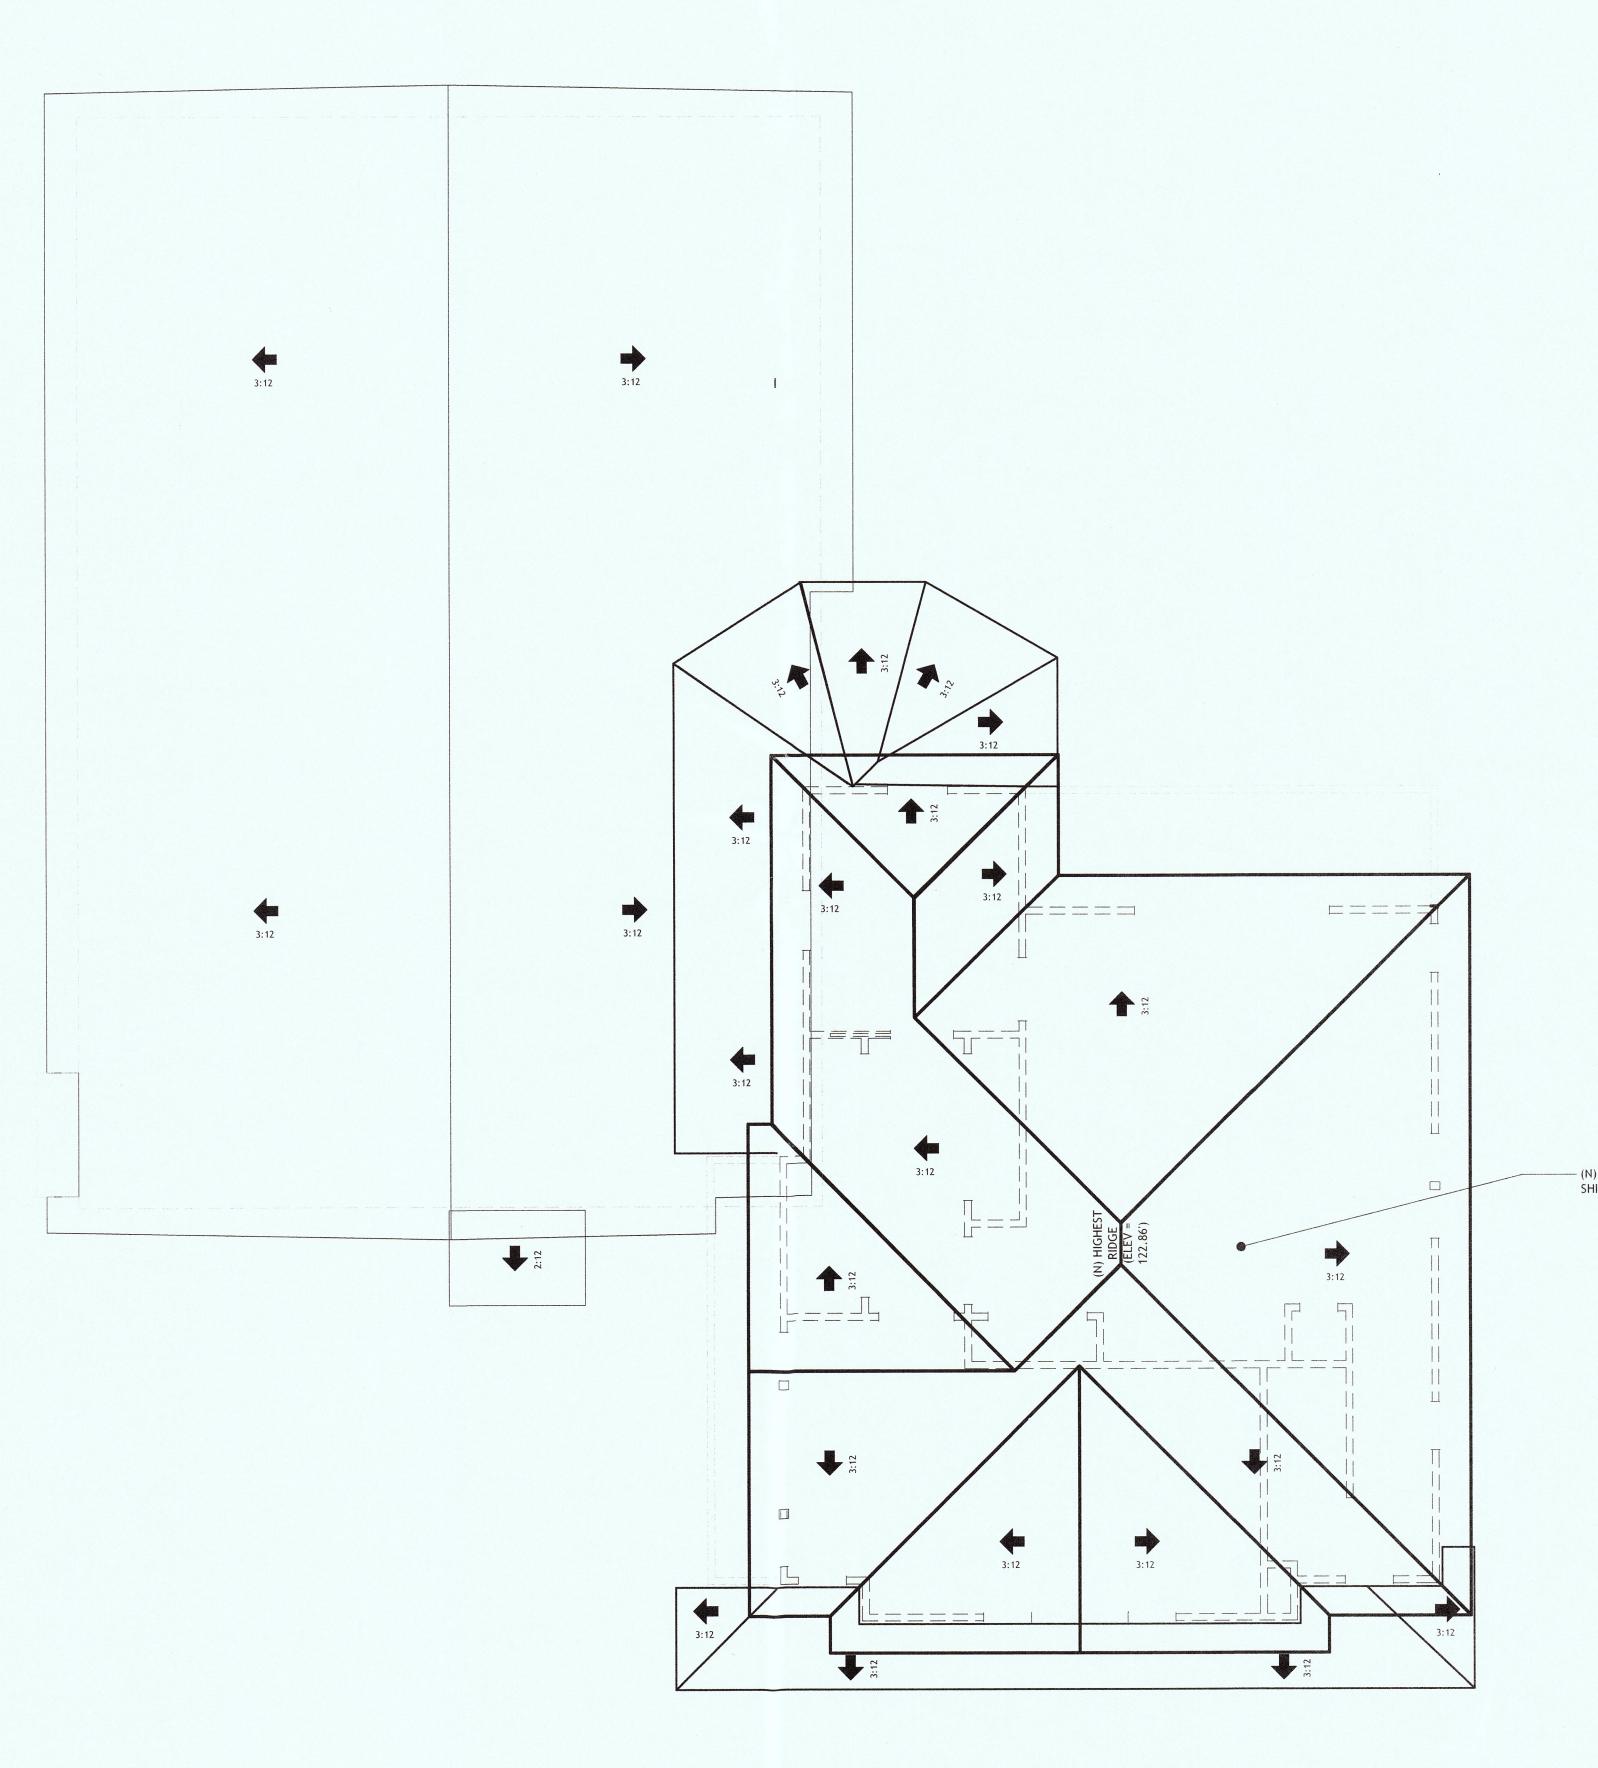

— (N) BLACK COMPOSITION ASPHALT ROOFING SHINGLES (TYP. @ ALL (N) ROOFS)

PROPOSED UPPER ROOF PLAN

SCALE: 1/4" = 1'-0"

BRIAN BRINKMAN DRAFTING & DESIGN

648 Navarre Drive

NAME:		У Ц Ц	MEV DAIE	DESCRIPTION
DITION TO SINGLE FAMILY HON	MILY HOME:	0	0 07/01/15	PRE-APPLICATION MEETIN
RESIDENCE		_	07/15/15	PLANNING SUBMITTAL
- ADDRESS:	PROJECT SCOPE:	2	2 04/12/16	PLANNING RESUBMITTAL
/FBMONIT AVENITE	1-STORY ADDITION BEHIND (E)			
	GARAGE AND 2ND STORY			
C DIVIDIO ONOS				

PROPOSED

PLAN

UPPER ROOF


A3.3

- MAX FLOW RATE OF SHOWERHEADS SHALL BE 2.0 GPM
- MAX FLOW RATE OF LAVATORY FAUCETS SHALL BE 1.5 GPM
- MAX FLOW RATE OF KITCHEN FAUCETS SHALL BE 1.8 GPM
   ALL TOILETS SHALL BE MAX 1.28 GPF

#### EGRESS NOTE:

AT LEAST ONE WINDOW IN EACH BEDROOM SHALL MEET THE

- FOLLOWING REQUIREMENTS:
- MIN. 5.7 SF IN OVERALL SIZEMIN. 24" CLEAR OPENING HEIGHT
- MIN. 24 CLEAR OPENING WIDTH
   MIN. 20" CLEAR OPENING WIDTH
- SILL A MAX. OF 44" ABOVE FINISHED FLOOR

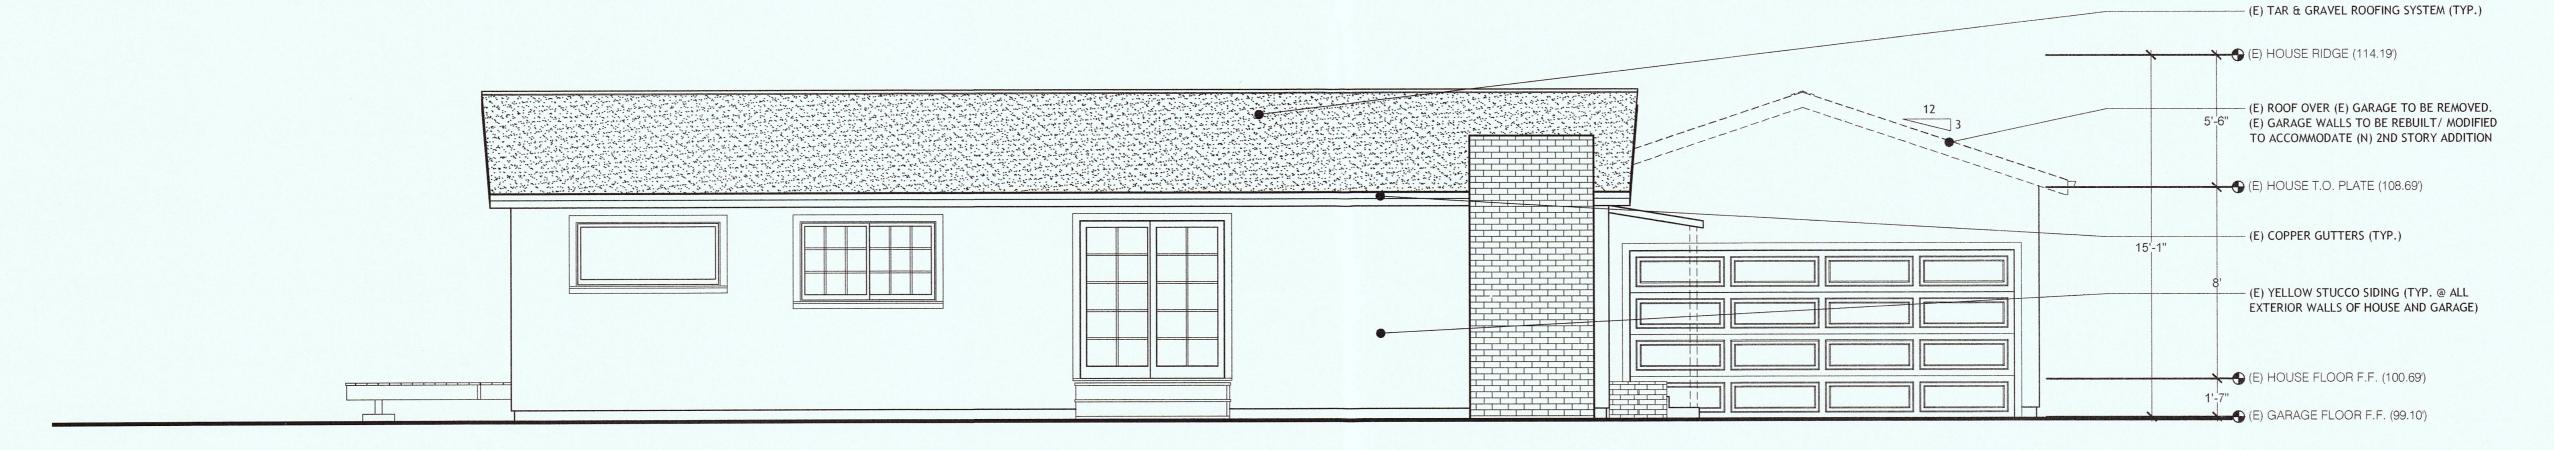

EXISTING LEFT (SOUTHWEST) ELEVATION

SCALE: 1/4" = 1'-0"



PROPOSED LEFT (SOUTHWEST) ELEVATION

SCALE: 1/4" = 1'-0"

BRIAN BRINKMAN DRAFTING & DESIGN

648 Navarre Drive Pacifica, CA 94044



ADDITION TO SINGLE FAMILY HOME:	YMILY HOME:	0	07/01/15	PRE-APPLICATION MEETING
YEE RESIDENCE		-	07/15/15	PLANNING SUBMITTAL
PROJECT ADDRESS:	PROJECT SCOPE:	2	04/12/16	PLANNING RESUBMITTAL
439 VERMONT AVENUE	1-STORY ADDITION BEHIND (E) GARAGE AND 2ND STORY			

EXISTING AND PROPOSED LEFT (SOUTHWEST)

SHEET:

A4.2


**ELEVATIONS** 

- MAX FLOW RATE OF SHOWERHEADS SHALL BE 2.0 GPM
- MAX FLOW RATE OF LAVATORY FAUCETS SHALL BE 1.5 GPM
   MAX FLOW RATE OF KITCHEN FAUCETS SHALL BE 1.8 GPM
- ALL TOILETS SHALL BE MAX 1.28 GPF

#### EGRESS NOTE:

AT LEAST ONE WINDOW IN EACH BEDROOM SHALL MEET THE

- FOLLOWING REQUIREMENTS:
- MIN. 5.7 SF IN OVERALL SIZE
- MIN. 24" CLEAR OPENING HEIGHT
  MIN. 20" CLEAR OPENING WIDTH
- SILL A MAX. OF 44" ABOVE FINISHED FLOOR

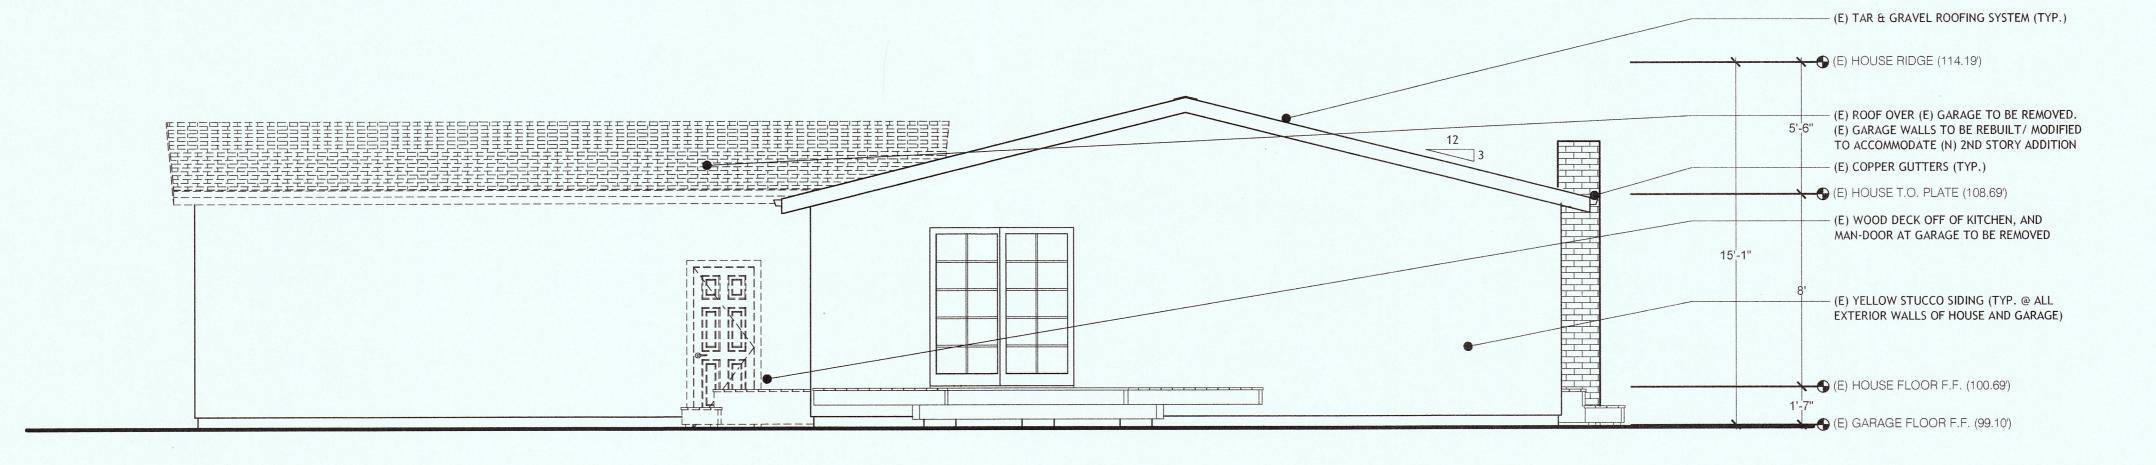

EXISTING REAR (NORTHWEST) ELEVATION

SCALE: 1/4" = 1'-0"



PROPOSED REAR (NORTHWEST) ELEVATION

SCALE: 1/4" = 1'-0"

BRIAN BRINKMAN DRAFTING & DESIGN

648 Navarre Drive Pacifica CA 94044



E FAMILY HOME:	0	07/01/15	PRE-APPLICATION MEETING
	-	07/15/15	PLANNING SUBMITTAL
PROJECT SCOPE:	2	04/12/16	PLANNING RESUBMITTAL
GARAGE AND 2ND STORY			
ADDITION ABOVE (E) GARAGE			

ADDITION TO SINGLE YEE RESIDENCE
BY THE RESIDENCE
ROJECT ADDRESS:
439 VERMONT AVENUE
MOSS BEACH, CA 94038

SHEET:

REAR

A4.3


(NORTHWEST)

ELEVATIONS

- MAX FLOW RATE OF SHOWERHEADS SHALL BE 2.0 GPM
- MAX FLOW RATE OF LAVATORY FAUCETS SHALL BE 1.5 GPM
- MAX FLOW RATE OF KITCHEN FAUCETS SHALL BE 1.8 GPM ALL TOILETS SHALL BE MAX 1.28 GPF

AT LEAST ONE WINDOW IN EACH BEDROOM SHALL MEET THE

- FOLLOWING REQUIREMENTS:
- MIN. 5.7 SF IN OVERALL SIZE
- MIN. 24" CLEAR OPENING HEIGHT MIN. 20" CLEAR OPENING WIDTH
- SILL A MAX. OF 44" ABOVE FINISHED FLOOR

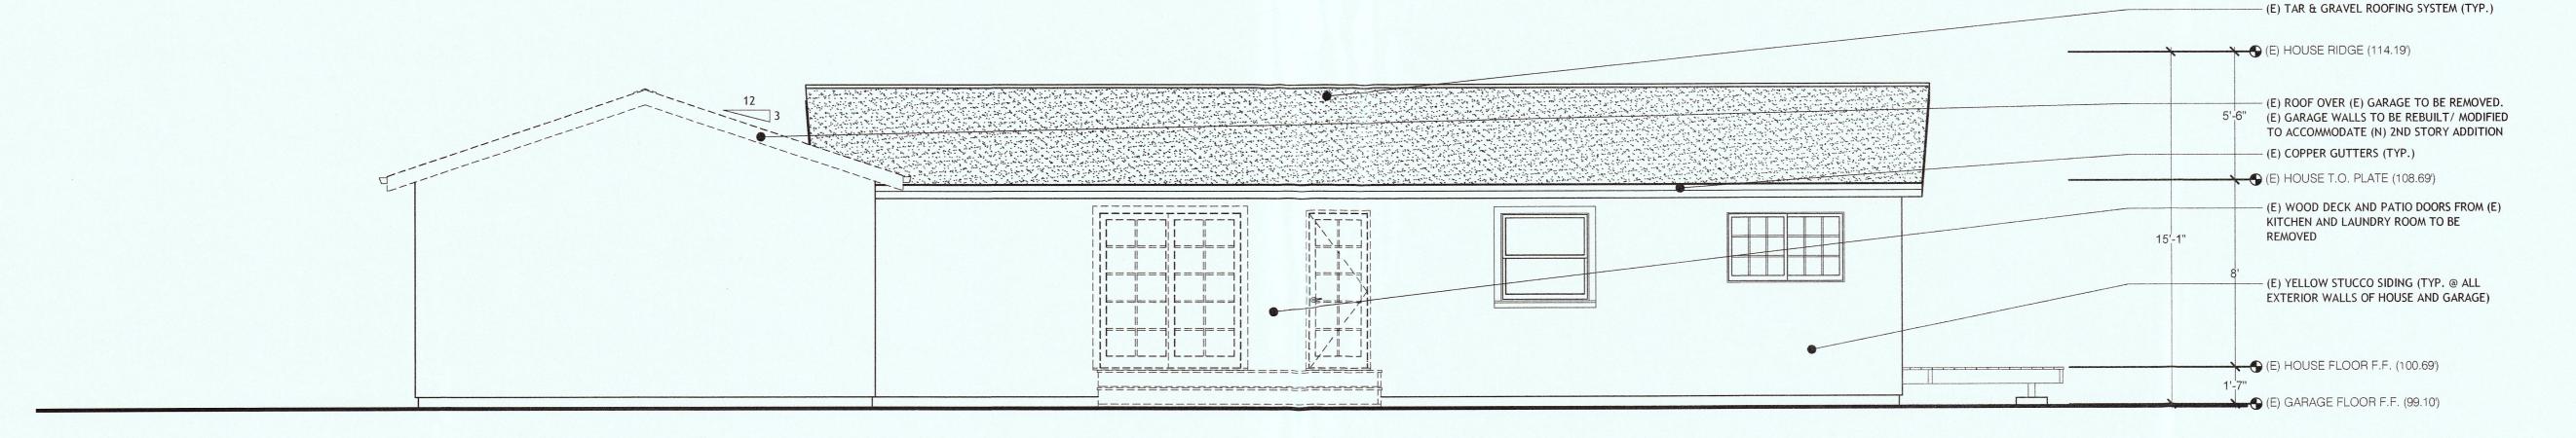

EXISTING RIGHT (NORTHEAST) ELEVATION SCALE: 1/4" = 1'-0"



PROPOSED RIGHT (NORTHEAST) ELEVATION SCALE: 1/4'' = 1'-0''



	· -	5	
	0	07/01/15	PRE-APPLICATION MEETING
	-	07/15/15	PLANNING SUBMITTAL
Ĺ	2	04/12/16	PLANNING RESUBMITTAL
出			

AMILY

ADDITION TO SINGLE YEE RESIDENCE

**EXISTING AND** PROPOSED RIGHT (NORTHEAST) ELEVATIONS

A4.4