

700 GEORGE ST.
 MONTARA, CA 94037
 PARCEL NO. 036-103-620
 NEW SINGLE FAMILY DWELLING w/DETACHED GARAGE

ILLUSTRATIONS ARE NOT INTENDED TO BE AN EXACT REPRESENTATION OF MATERIALS AND FINISHES



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ABBREVIATIONS

(A) ALTERED	MNFR MANUFACTURER
A.C. AIR CONDITIONING	MAX MAXIMUM
A.F.F. ABOVE FINISH	MECH MECHANICAL
FLOOR	MIN MINIMUM
BLDG BUILDING	MISC MISCELLANEOUS
BLKG BLOCKING	(N) NEW
BM BEAM	NO. NUMBER
CBC CALIFORNIA BUILDING CODE	OBSC OBSCURE
CLG CEILING	O.C. ON CENTER
CLR CLEAR	PL PLATE
CMU CONCRETE MASONRY UNIT	PLYWD PLYWOOD
CONC CONCRETE	P.T. PRESSURE TREATED
DIA DIAMETER	(R) TO BE REMOVED / DEMOLISHED
DIM DIMENSION	RAD RADIUS
DN DOWN	REQ'D REQUIRED
DS DOWNSPOUT	RM ROOM
D.T.S. DOUBLE TRIM	RWD REDWOOD
STUD	SM SIMILAR
DW DISHWASHER	SPEC SPECIFICATION
(E) EXISTING	SQ SQUARE
EA EACH	STD STANDARD
EQ EQUAL EQUIPMENT	S.T.S. SINGLE TRIM STUD
EXT EXTERIOR	T&G TONGUE & GROOVE
F.F.E. FINISH FLOOR ELEVATION	TEMP TEMPERED GLASS
FIN FINISH	THK THICK
FLR FLOOR	TYP TYPICAL
FTG FOOTING	U.N.O. UNLESS OTHERWISE NOTED
GA GAUGE	VERT VERTICAL
GALV GALVANIZED	W WIDTH
GLB GLUE LAMINATED BEAM	W.H. WATER HEATER
GWB GYPSUM WALLBOARD	
HDR HEADER	
HT HEIGHT	
INS INSULATION	
INT INTERIOR	
L LENGTH	




HARDIE PANEL HORIZONTAL SIDING:
 EVENIGN BLUE
 COLOR MATCH WINDOW/DOOR TRIM TO SIDING



STUCCO COLOR:
 OMEGA 242 MIST



RIVER ROCK VENEER

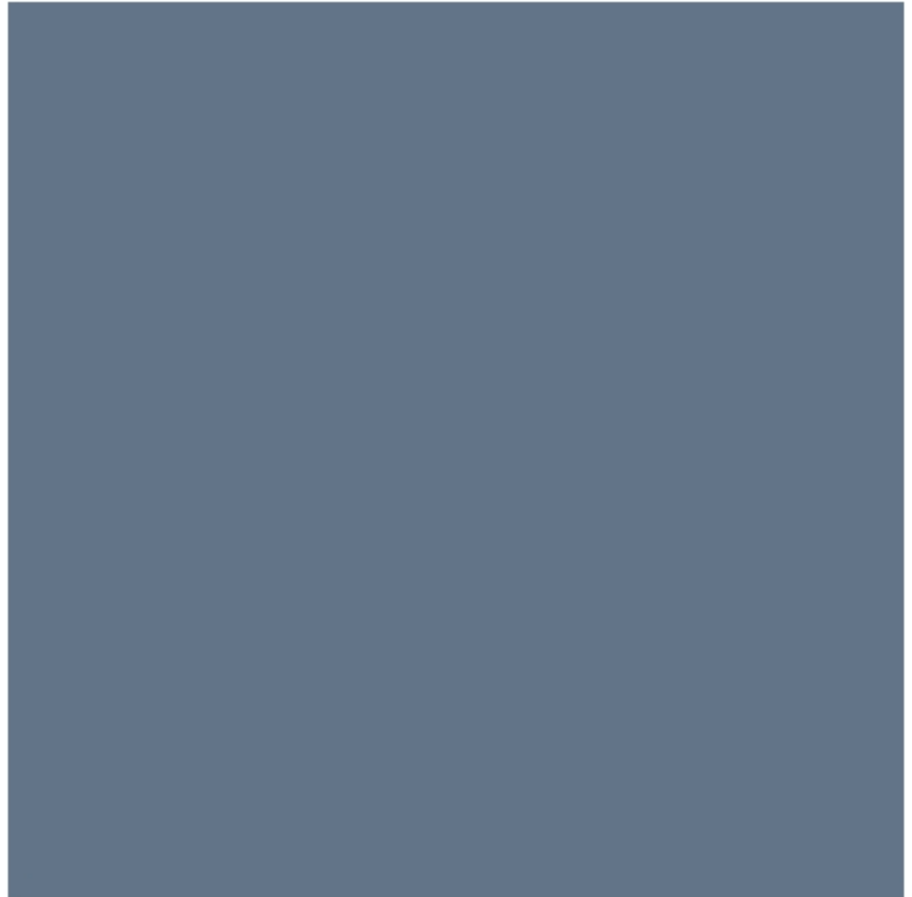

FIBERGLASS WINDOWS AND GARAGE DOORS
 NAVY BLUE



EXTERIOR LIGHTS:
 POSSANI EURO
 MODEL: RATNER 5-1/2" HIGH BLACK MODERN LED OUTDOOR WALL LIGHT
 DARK SKY COMPLIANT

PROJECT TEAM

AREA CALCULATIONS

AREA CALCULATIONS	
	AREA
DWELLING	2,818.45 SQFT
1 ST FLOOR	1,606.24 SQFT
2 ND FLOOR	1,164.30 SQFT
GARAGE	400 SQFT
FRONT PORCH	120.27 SQFT
SITE	6,254 SQFT

LOT COVERAGE	
ALLOWABLE COVERAGE (35%)	2,188.9 SQFT
PROPOSED	2,126.51 SQFT
	< 34.00%
	35%

FLOOR AREA RATIO	
ALLOWABLE FAR (53%)	3,314.62 SQFT
PROPOSED (51.46%)	3,290.81 SQFT
	< 52.62%
	53%

CODE ANALYSIS
 AS AMENDED BY STATE OF CALIFORNIA AND LOCAL JURISDICTION

CODE USED
 2022 CALIFORNIA BUILDING CODE
 2022 CALIFORNIA RESIDENTIAL CODE
 2022 CALIFORNIA MECHANICAL CODE
 2022 CALIFORNIA PLUMBING CODE
 2022 CALIFORNIA ELECTRICAL CODE
 2022 CALIFORNIA ENERGY CODE
 2022 CALIFORNIA FIRE CODE
 2022 CALIFORNIA GREEN BUILDING STANDARDS CODE (CAL GREEN) NFPA 13D

CONSTRUCTION
 TYPE V-B

OCCUPANCY GROUP
 R-3 SINGLE FAMILY HOME
 R-4 PRIVATE GARAGE

FIRE SPRINKLERS:
 RESIDENCE SHALL HAVE APPROVED FIRE SPRINKLER SYSTEM PER 2022 CRC § R313.2 & R313.3

SCOPE OF WORK
 NEW TWO STORY SINGLE FAMILY DWELLING WITH A DETACHED TWO CAR GARAGE.

GENERAL NOTES

- RADIANT BARRIER REQUIRED AT NEW ROOF SHEATHING AND ON ALL NEW VERTICAL SERFACES AND GABLE END WALLS IN THE ATTIC.

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OWNER/BUILDER
 MARINA FASTOVSKAYA
 700 GEORGE ST.
 MONTARA, CA 94037



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 415 756-7038
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DATE	BY

NEW SINGLE FAMILY DWELLING
 700 GEORGE ST.
 MONTARA, CA 94037

APN: 036-103-620
 OWNER: MARINA FASTOVSKAYA

SHEET TITLE: COVER SHEET

DESIGNER: ALEX MARTYNOVSKIY
 NAME: ALEX MARTYNOVSKIY
 SIGNATURE: _____ DATE: _____

PROJECT #: #Pin
 DATE: 5/3/2022
 DRAWN BY: #Contact Custom
 SCALE: AS SHOWN

A1.0



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NEW SINGLE FAMILY DWELLING
700 GEORGE ST.
MONTARA, CA 94037

APN: 036-103-620
OWNER: MARINA FASTOVSKAYA

SHEET TITLE: SITE PLAN

DESIGNER: ALEX MARTYNOVSKIY
NAME: ALEX MARTYNOVSKIY
SIGNATURE: _____ DATE: _____


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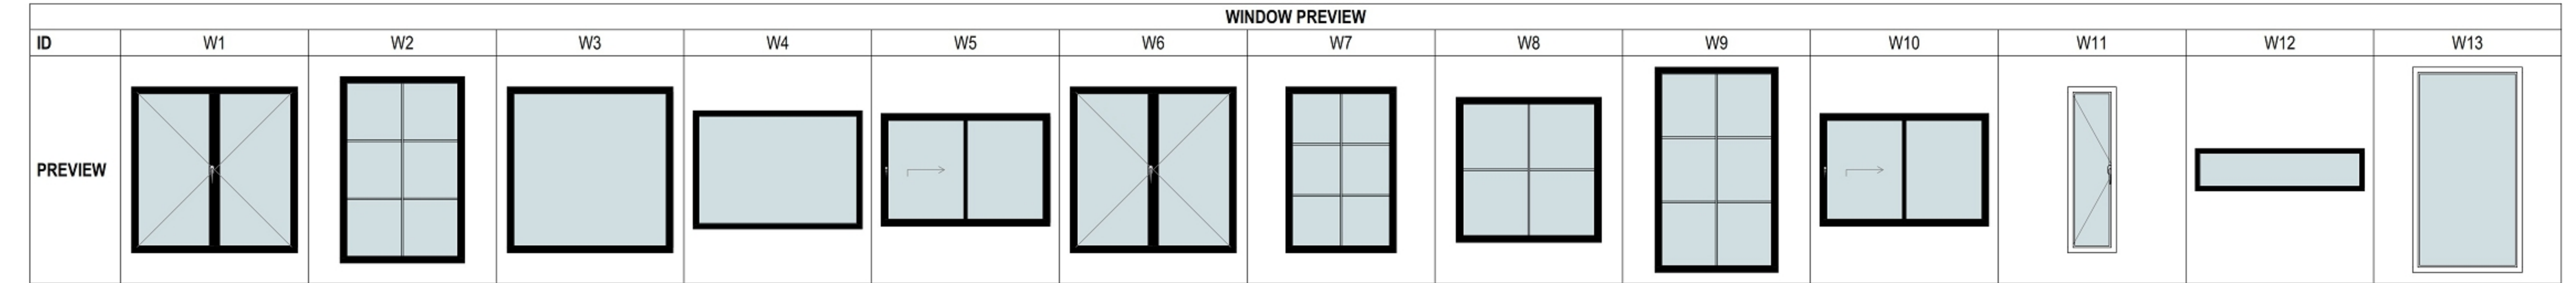
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A SITE PLAN
SCALE: 3/16" = 1'-0"




AREA (ROOM S)		
ID	Zone Name	Area
Z01.0	LIVING RM	439.54
Z02.0	DINING	106.98
Z03.0	KITCHEN	168.98
Z04.0	HALLWAY	126.83
Z05.0	OFFICE	126.50
Z06.0	LAUNDRY	88.98
Z07.0	BATHRM-1	56.54
Z08.0	M.BATH	92.19
Z09.0	M.BEDRM-1	180.47
Z09.1	M. WIC	43.94
Z10.0	PANTRY	56.25
Z20.0	FAMILY-RM	252.31
Z21.0	HALLWAY	79.00
Z21.1	STOR.	8.00
Z21.2	STOR.	15.33
Z22.0	BEDRM-2	107.81
Z22.1	BEDRM-3	28.33
Z23.0	BEDRM-3	121.23
Z23.1	WIC	47.92
Z24.0	BATHRM-2	56.54
Z26.0	GUEST BEDRM-4	232.74
Z26.1	GUEST WIC	43.94
Z26.2	GUEST BATH	92.19
ZN14	ROOM	146.34
		2,718.88 ft²



WINDOW SCHEDULE						
ID	QTY	Width	Height	Orientation	Type/Egress	Material
W1	1	3'	4'	BATHRM-1	SL	FIBERGLASS
W2	1	3'	4'-6"	M. WIC	SL	FIBERGLASS
W3	1	4'	4'	GARAGE	SL	FIBERGLASS
W4	1	5'	3'-6"	KITCHEN	SL	FIBERGLASS
W5	1	6'	4'	R BDRM 2	SL/Egress	FIBERGLASS
W6	1	6'	4'	GUEST BATH	SL	FIBERGLASS
W7	2	4'	4'	LAUNDRY	SL	FIBERGLASS
W8	3	3'-4"	3'-6"	FAMILY ROOM	FIXED	FIBERGLASS
W9	1	3'	5'	STAIR TEMP.	FIXED	FIBERGLASS
W10	1	6'	4'	LIVING ROOM	SL	FIBERGLASS
W11	1	6'	1'-6"	L BDRM 3	SL/Egress	FIBERGLASS
W12	1	2'-8"	2'-8"	GUEST BRM.	SL/Egress	FIBERGLASS
W13	3	2'-8"	5"	BATH 2 OBSC.	SL	FIBERGLASS
W13	3	2'-8"	5"	GUEST BRM.	SL/Egress	FIBERGLASS

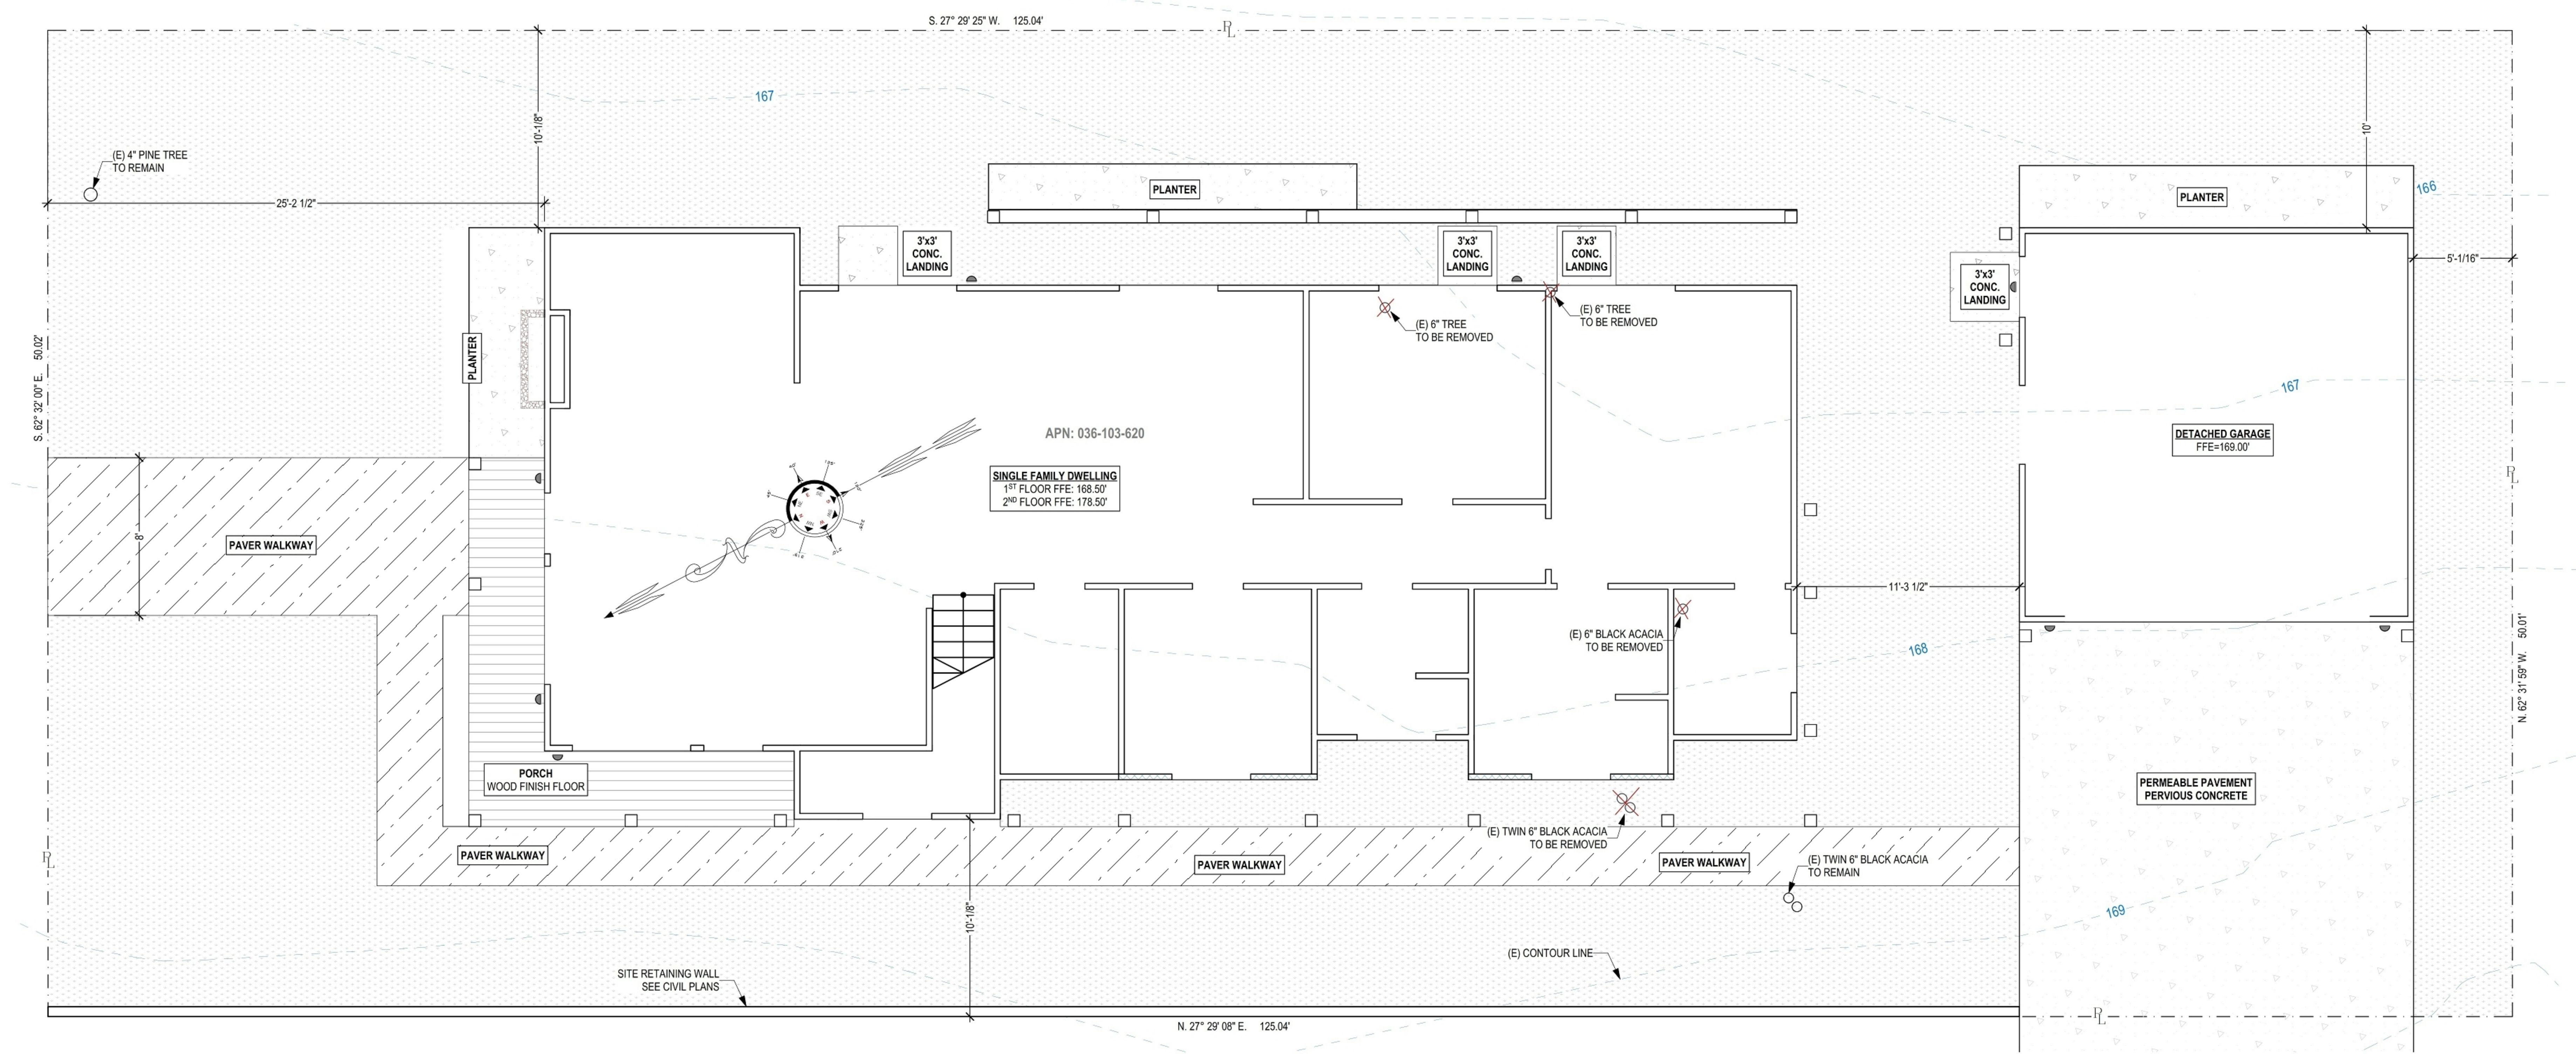DOOR SCHEDULE							
ID	QTY	W	H	SWING	Note	Material	Color
D1	1	2'-4"	6'-8"	L	INTERIOR	WOOD	WHITE
D2	5	2'-6"	6'-8"	L	INTERIOR	WOOD	WHITE
D3	9	2'-6"	6'-8"	R	INTERIOR	WOOD	WHITE
D4	1	3'	6'-8"	R	ENTRY DOOR	WOOD	NAVY BLUE
D5	1	3'	6'-8"	L	INTERIOR	WOOD	WHITE
D6	1	3'	6'-8"	R	INTERIOR	WOOD	WHITE
D7	1	3'	8'	R	INTERIOR	WOOD	WHITE
D8	3	6'	6'-8"	R	EXIT DOOR	FIBERGLASS	NAVY BLUE
D9	1	6'	6'-8"	L	EXIT DOOR	FIBERGLASS	NAVY BLUE
D10	1	6'	6'-8"	L	INTERIOR	WOOD	WHITE
D11	1	6'	6'-8"	R	EXIT DOOR	FIBERGLASS	NAVY BLUE
D12	1	15'-6"	7'	L	INTERIOR	WOOD	WHITE

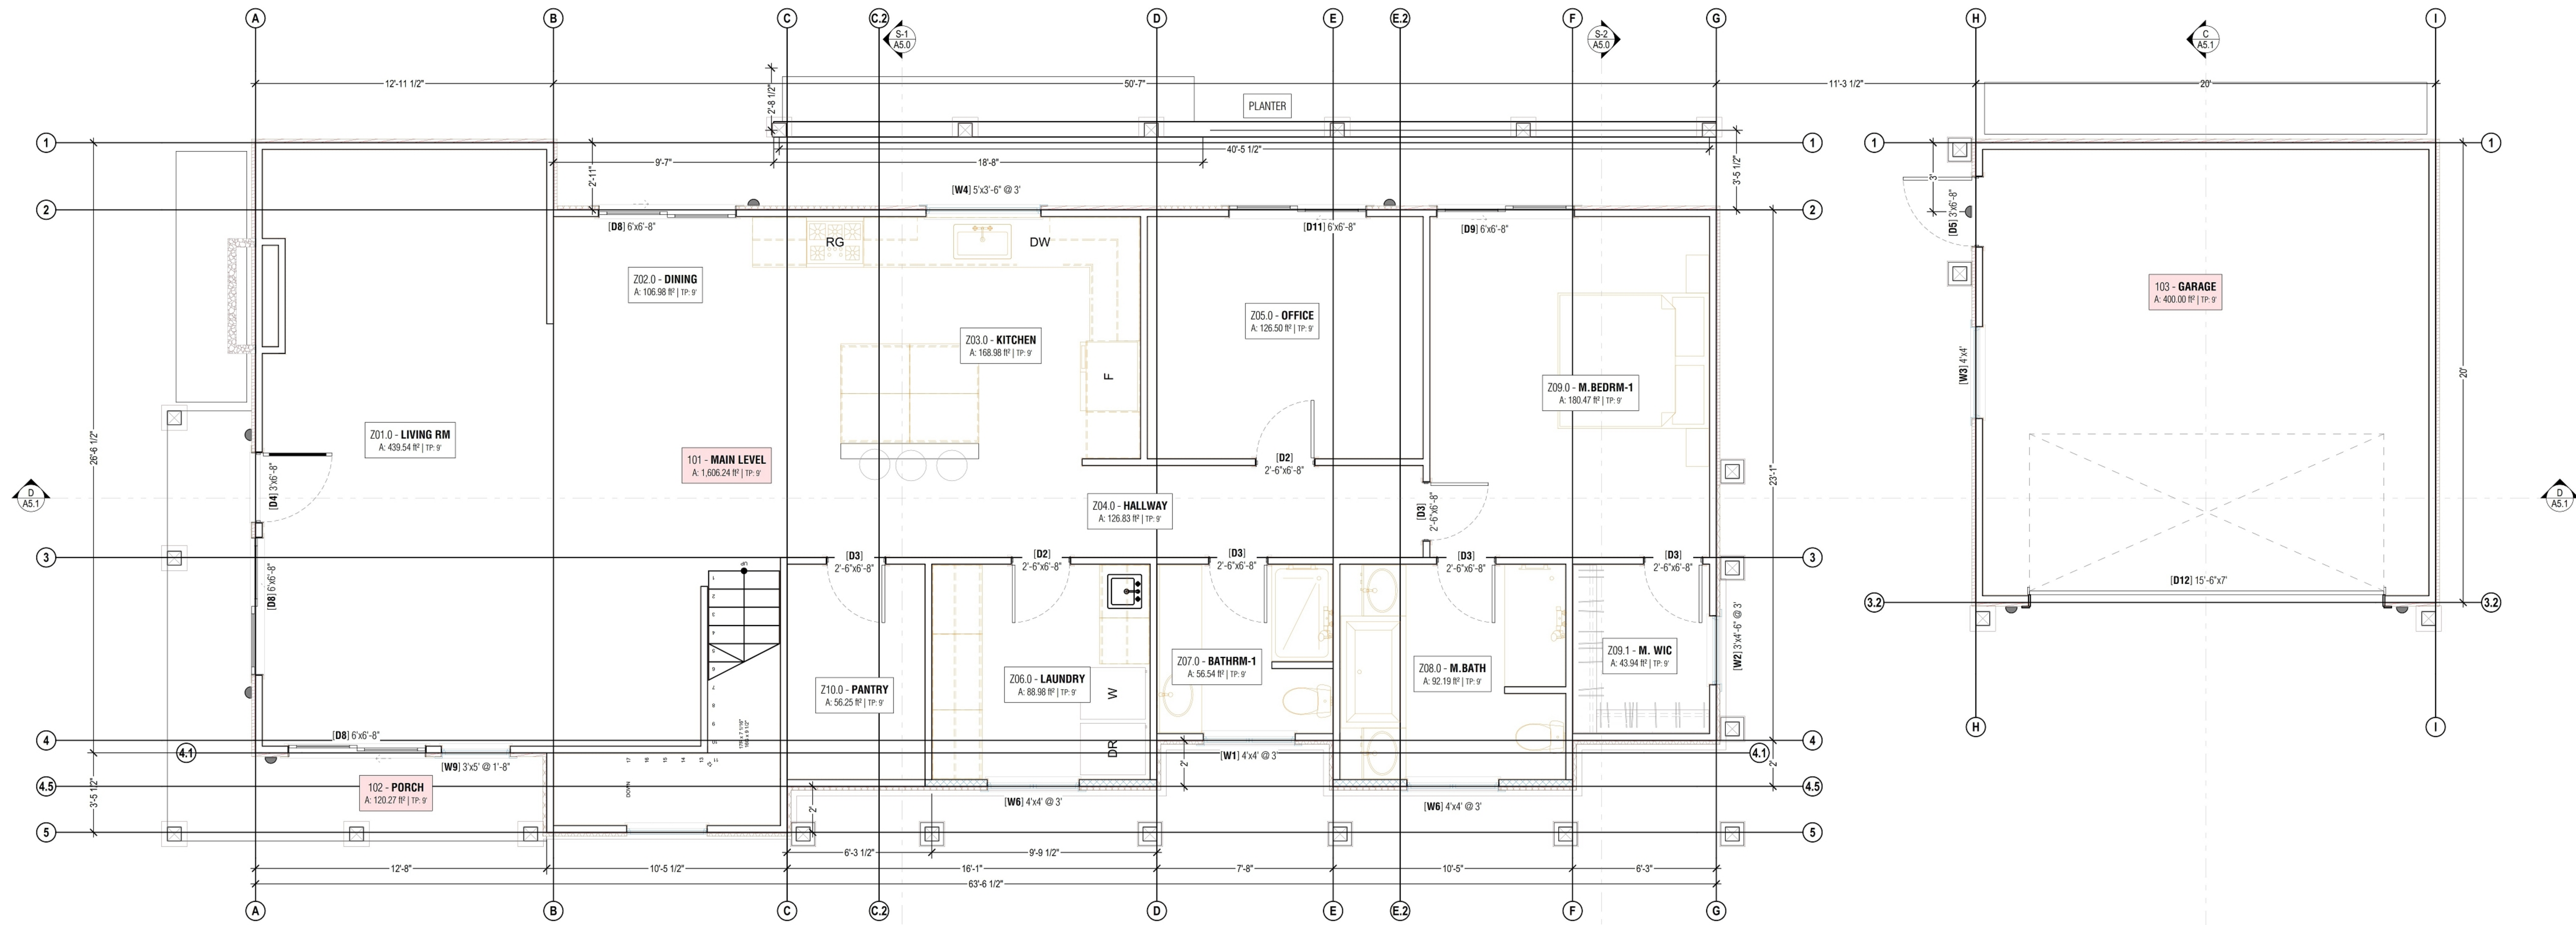

A PROPOSED 1st FLOOR PLAN
SCALE: 1/4" = 1'-0"



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DATE	BY

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700 GEORGE ST.
MONTARA, CA 94037

APN 036-103-620

OWNER MARINA FASSTOVSKAYA

SHEET TITLE PROPOSED FLOOR PLAN

DESIGNER ALEX MARTYNOVSKIY

NAME SIGNATURE DATE

PROJECT # #Pin


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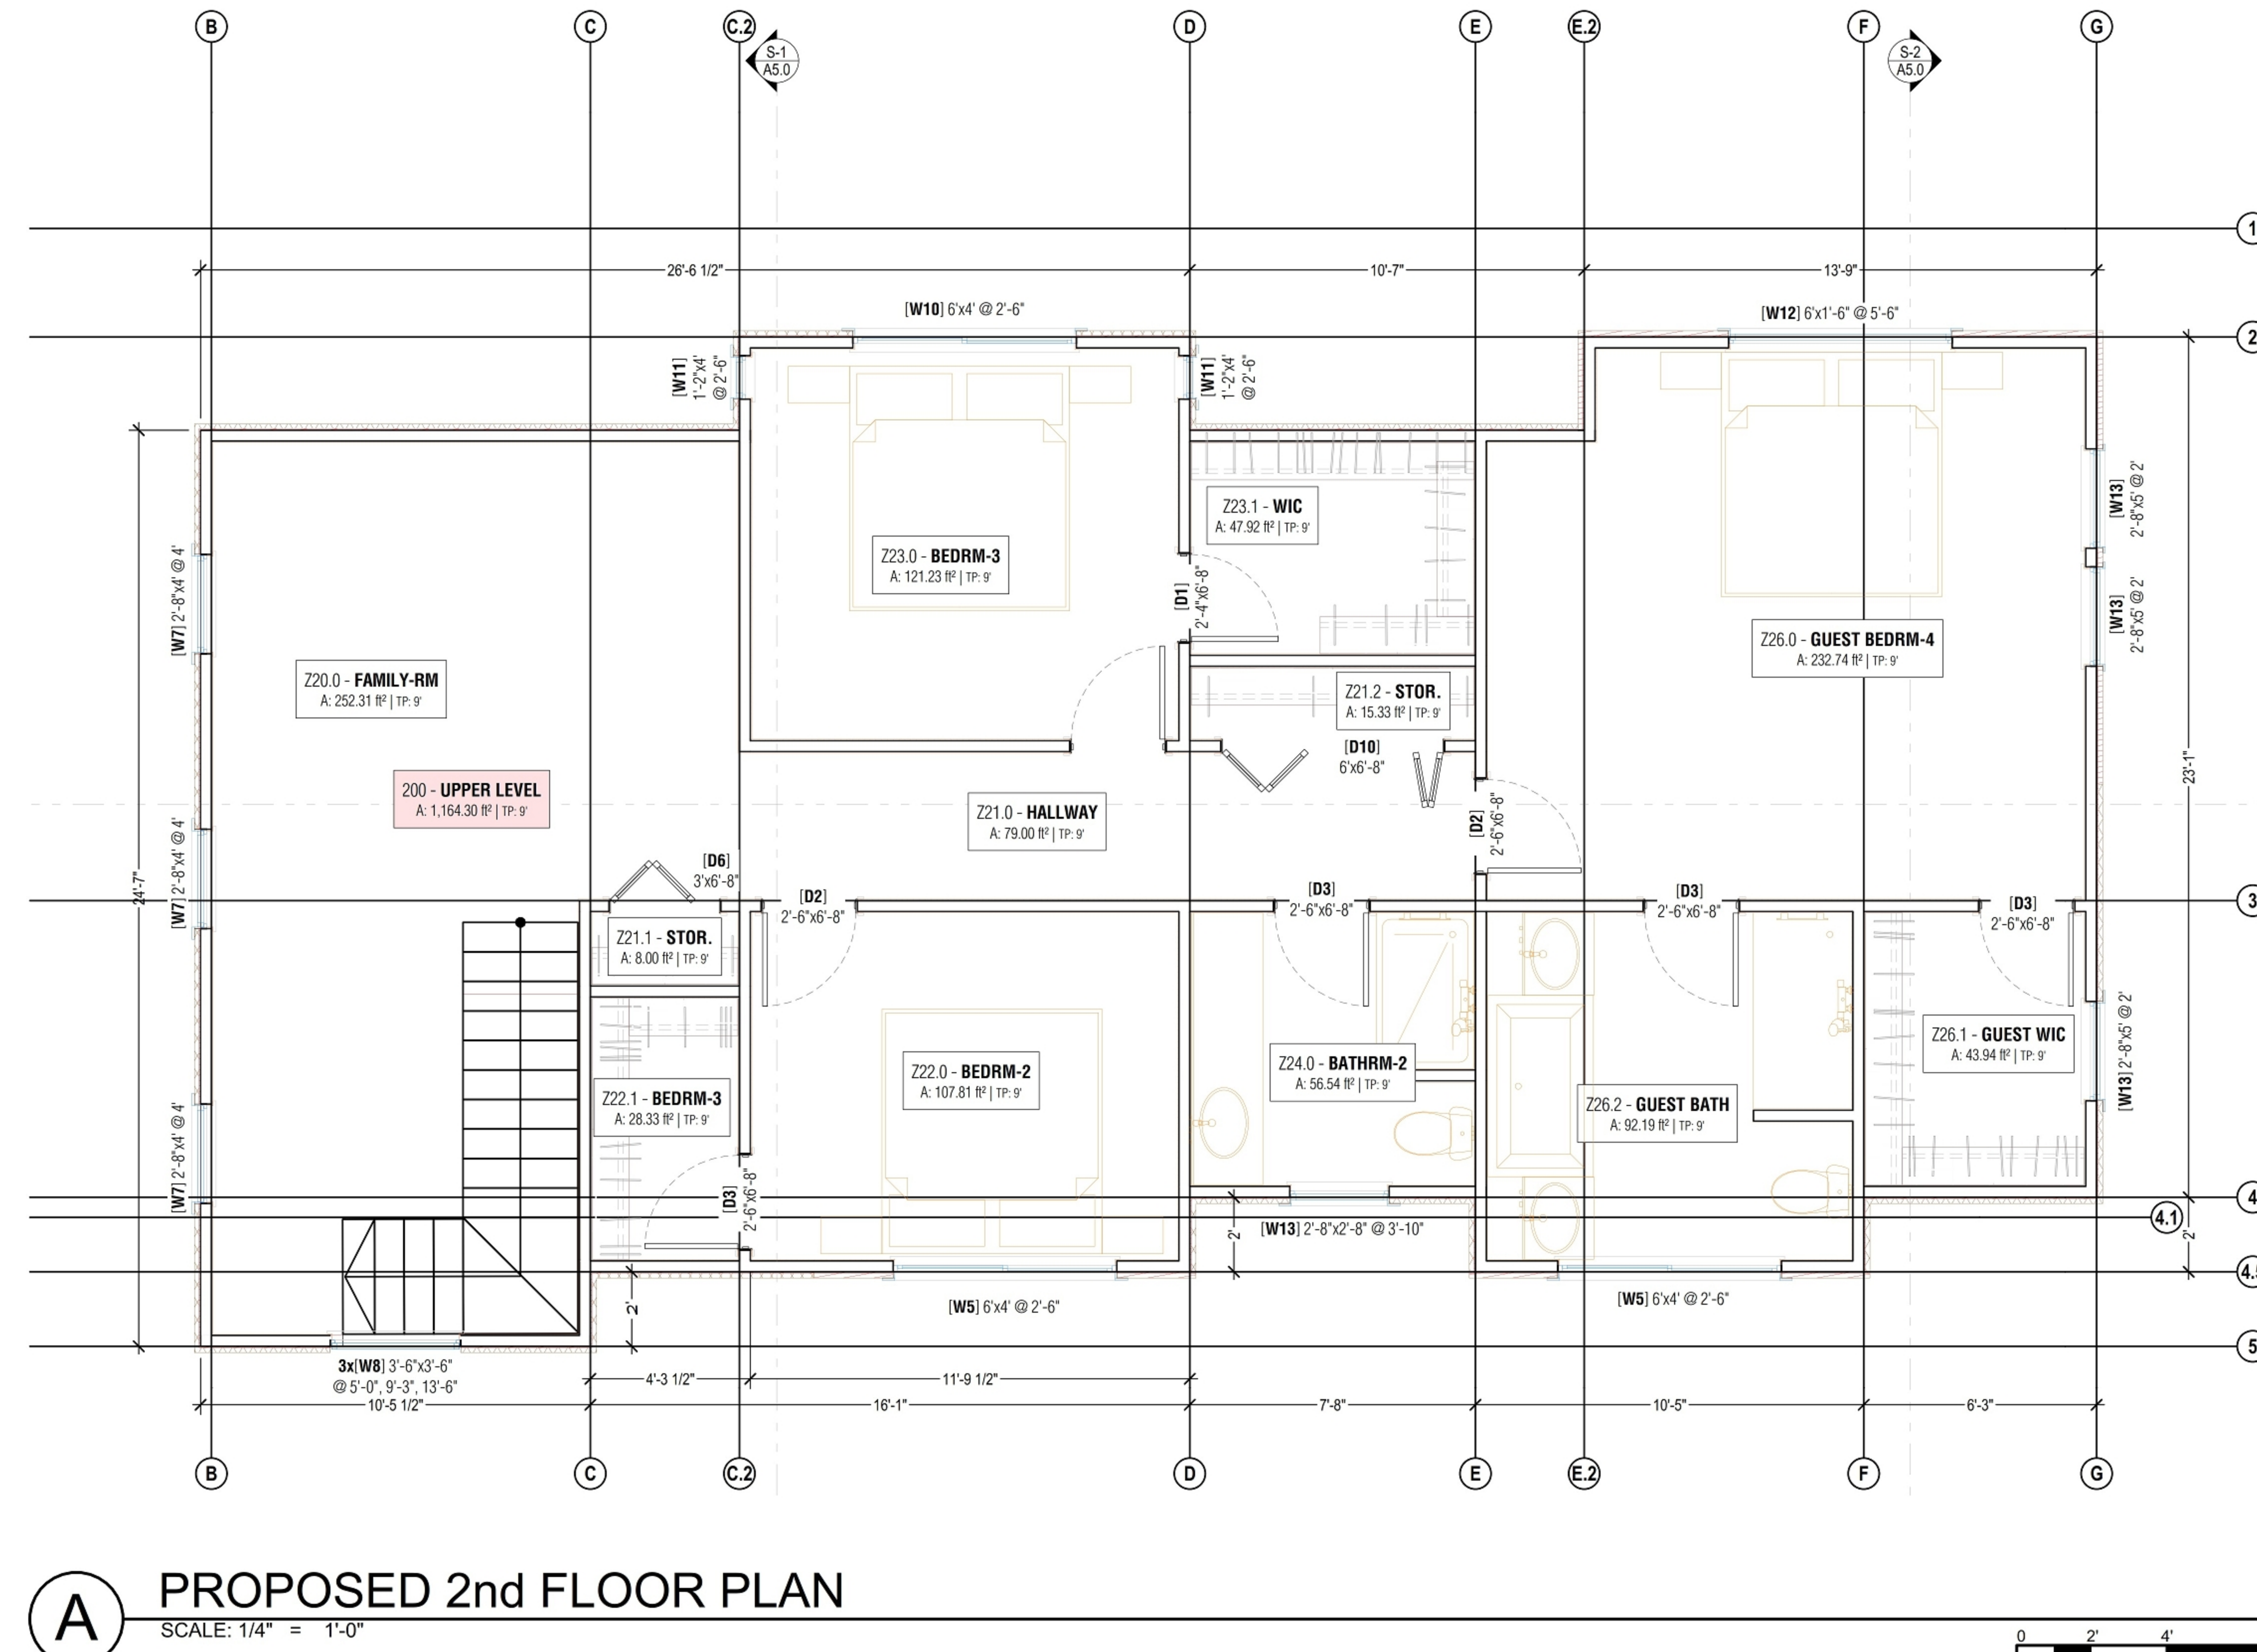
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W4	1	5'	3'-6"	KITCHEN	SL	FIBERGLASS
W5	1	6'	4'	R.BDRM 2	SL/Egress	FIBERGLASS
W5	1	6'	4'	GUEST BATH	SL	FIBERGLASS
W6	2	4'	4'	LAUNDRY	SL	FIBERGLASS
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W11	1	6'	1'-6"	GUEST BRM.	SL/Egress	FIBERGLASS
W12	1	2'-8"	2'-8"	BATH 3 ORSC.	SL	FIBERGLASS
W13	3	2'-8"	5'	GUEST BRM.	SL/Egress	FIBERGLASS

DOOR SCHEDULE								
ID	QTY	W	H	SWING	Note	Material	Color	
D1	1	2'-4"	6'-8"	L	INTERIOR	WOOD	WHITE	
D2	5	2'-6"	6'-8"	L	INTERIOR	WOOD	WHITE	
D3	9	2'-6"	6'-8"	R	INTERIOR	WOOD	WHITE	
D4	1	3'	6'-8"	R	ENTRY DOOR	WOOD	NAVY BLUE	
D5	1	3'	6'-8"	L	INTERIOR	WOOD	WHITE	
D6	1	3'	6'-8"	R	INTERIOR	WOOD	WHITE	
D7	1	3'	8'	R	INTERIOR	WOOD	WHITE	
D8	3	6'	6'-8"	R	EXIT DOOR	FIBERGLASS	NAVY BLUE	
D9	1	6'	6'-8"	L	EXIT DOOR	FIBERGLASS	NAVY BLUE	
D10	1	6'	6'-8"		INTERIOR	WOOD	WHITE	
D11	1	6'	6'-8"	R	EXIT DOOR	FIBERGLASS	NAVY BLUE	
D12	1	15'-6"	7'	L	INTERIOR	WOOD	WHITE	



A PROPOSED 2nd FLOOR PLAN
SCALE: 1/4" = 1'-0"

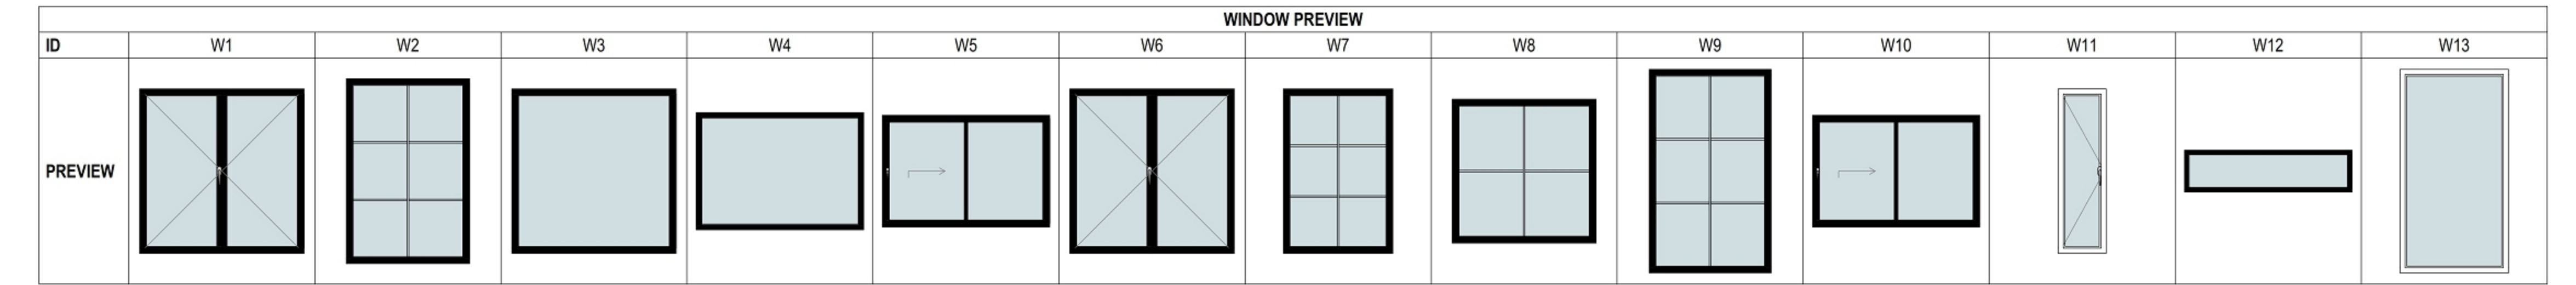

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DATE	BY


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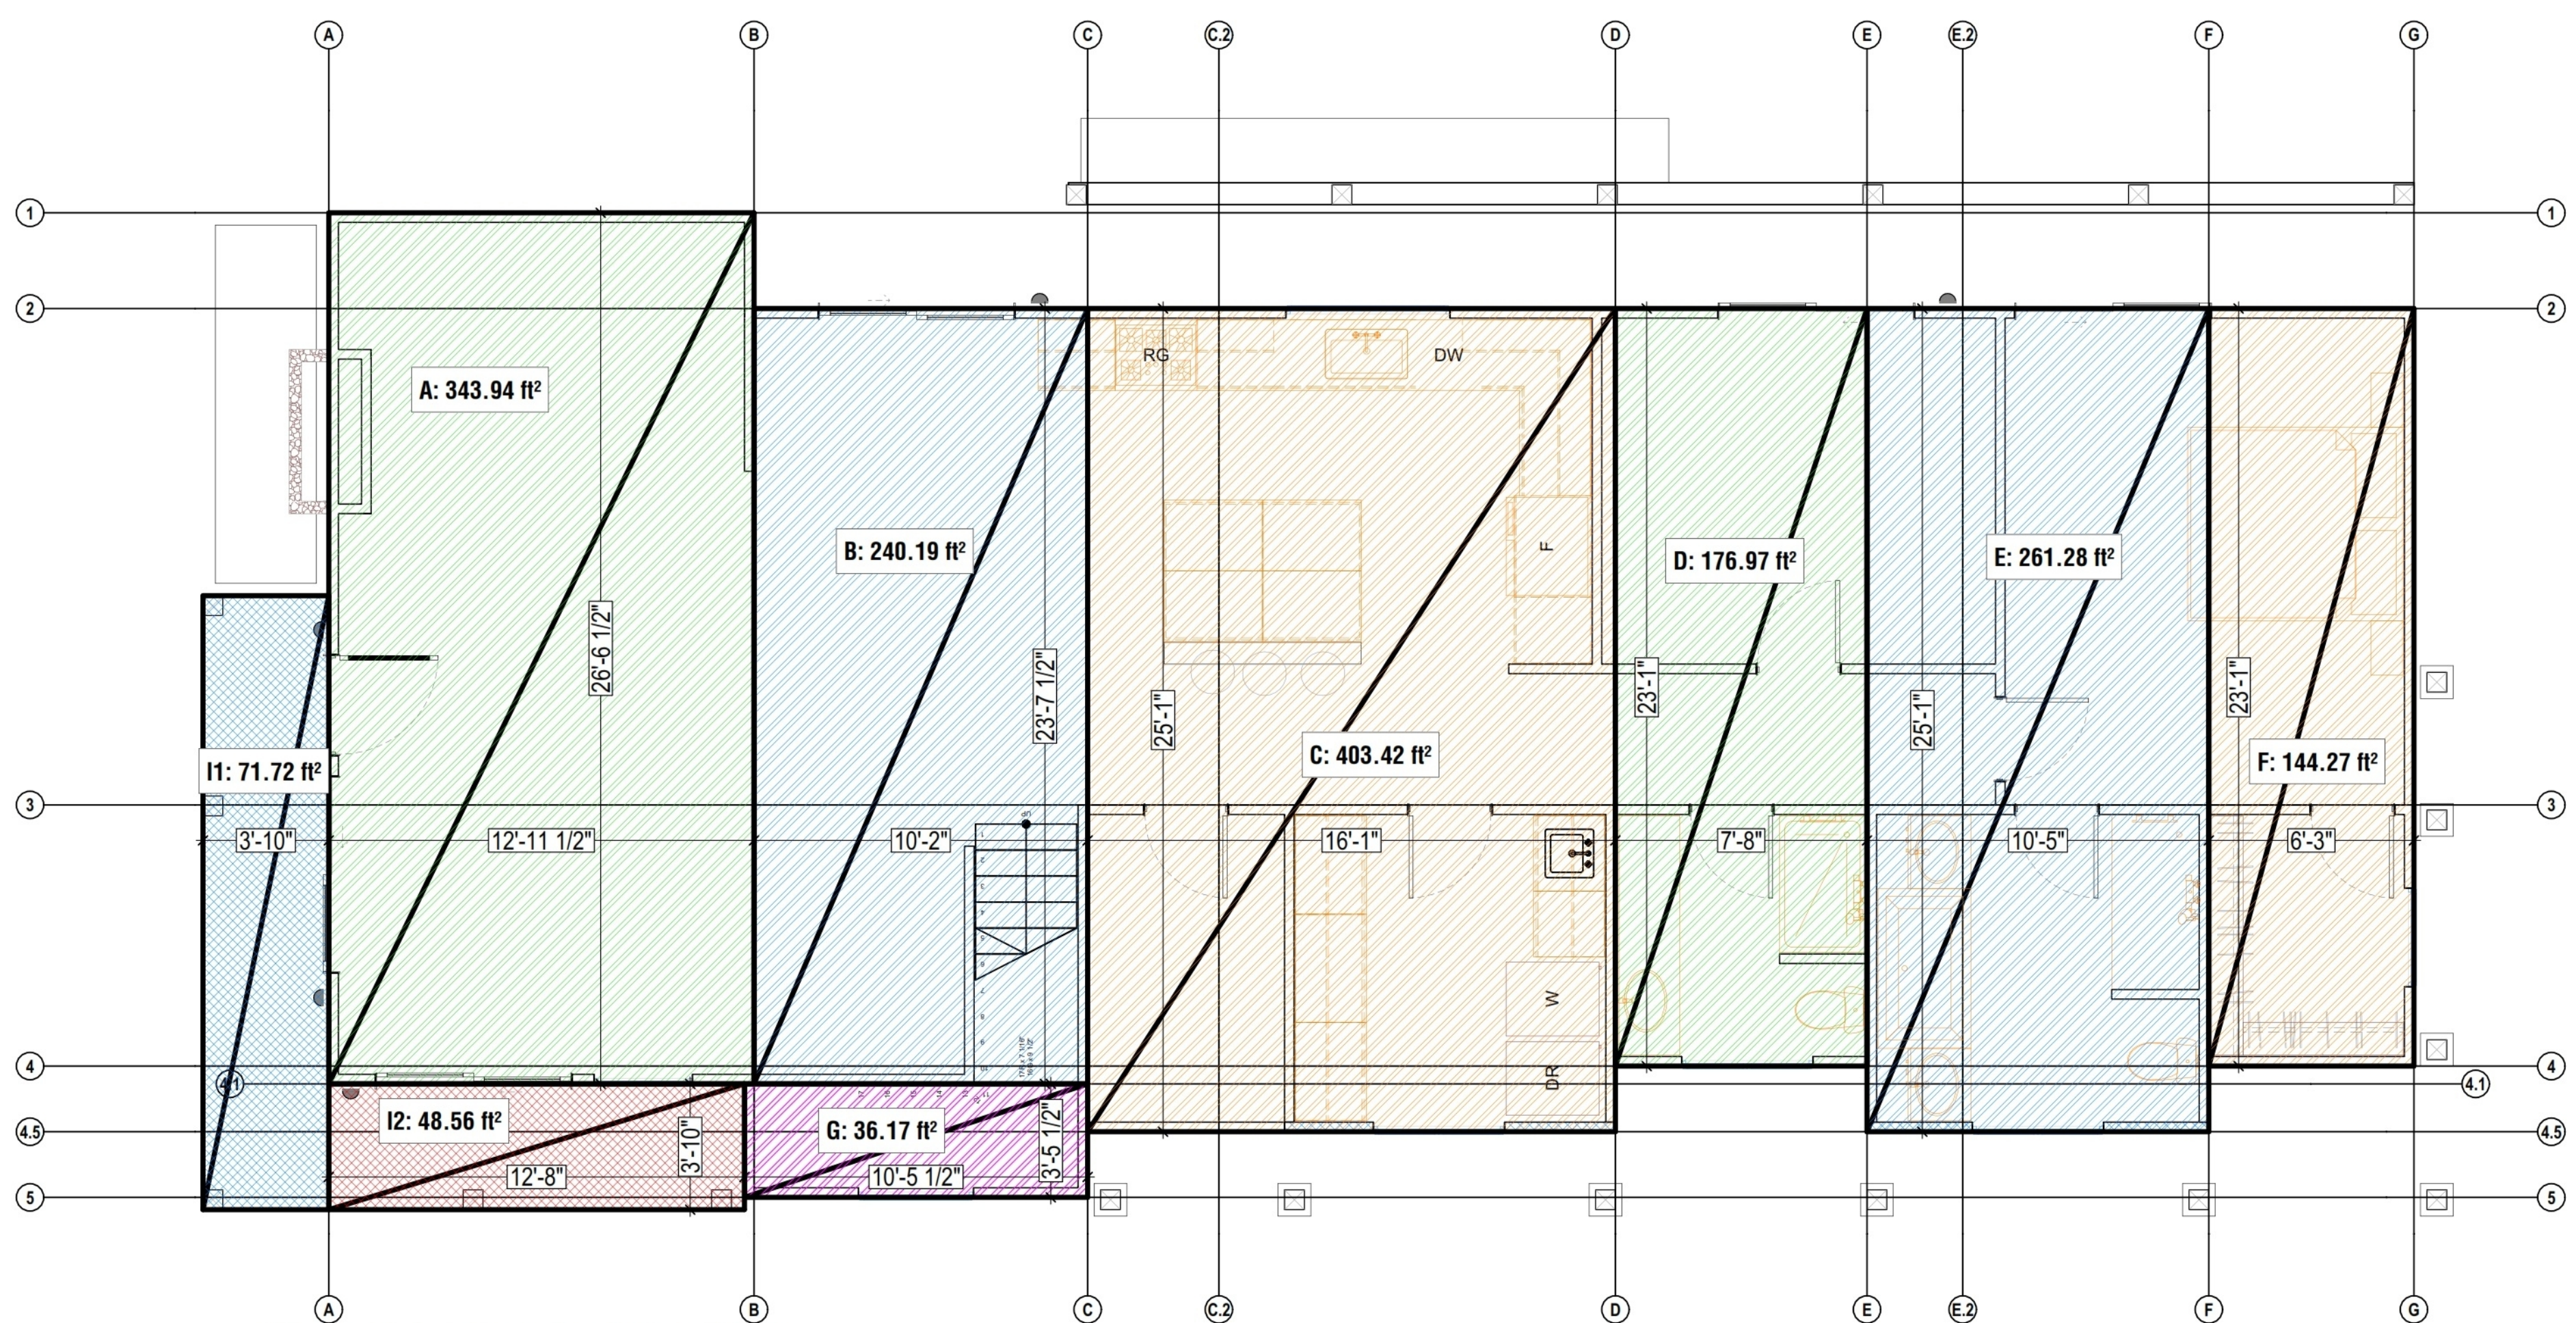
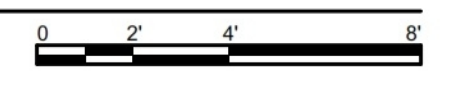
SHEET TITLE: PROPOSED UPPER FLOOR PLAN

DESIGNER: ALEX MARTYNOVSKIY
NAME: _____
SIGNATURE: _____ DATE: _____

PROJECT #: #Pin
DATE: 5/3/2022
DRAWN BY: #Contact Custom
SCALE: AS SHOWN



B SECONDED FLOOR AREA CALC
SCALE: 1/4" = 1'-0"

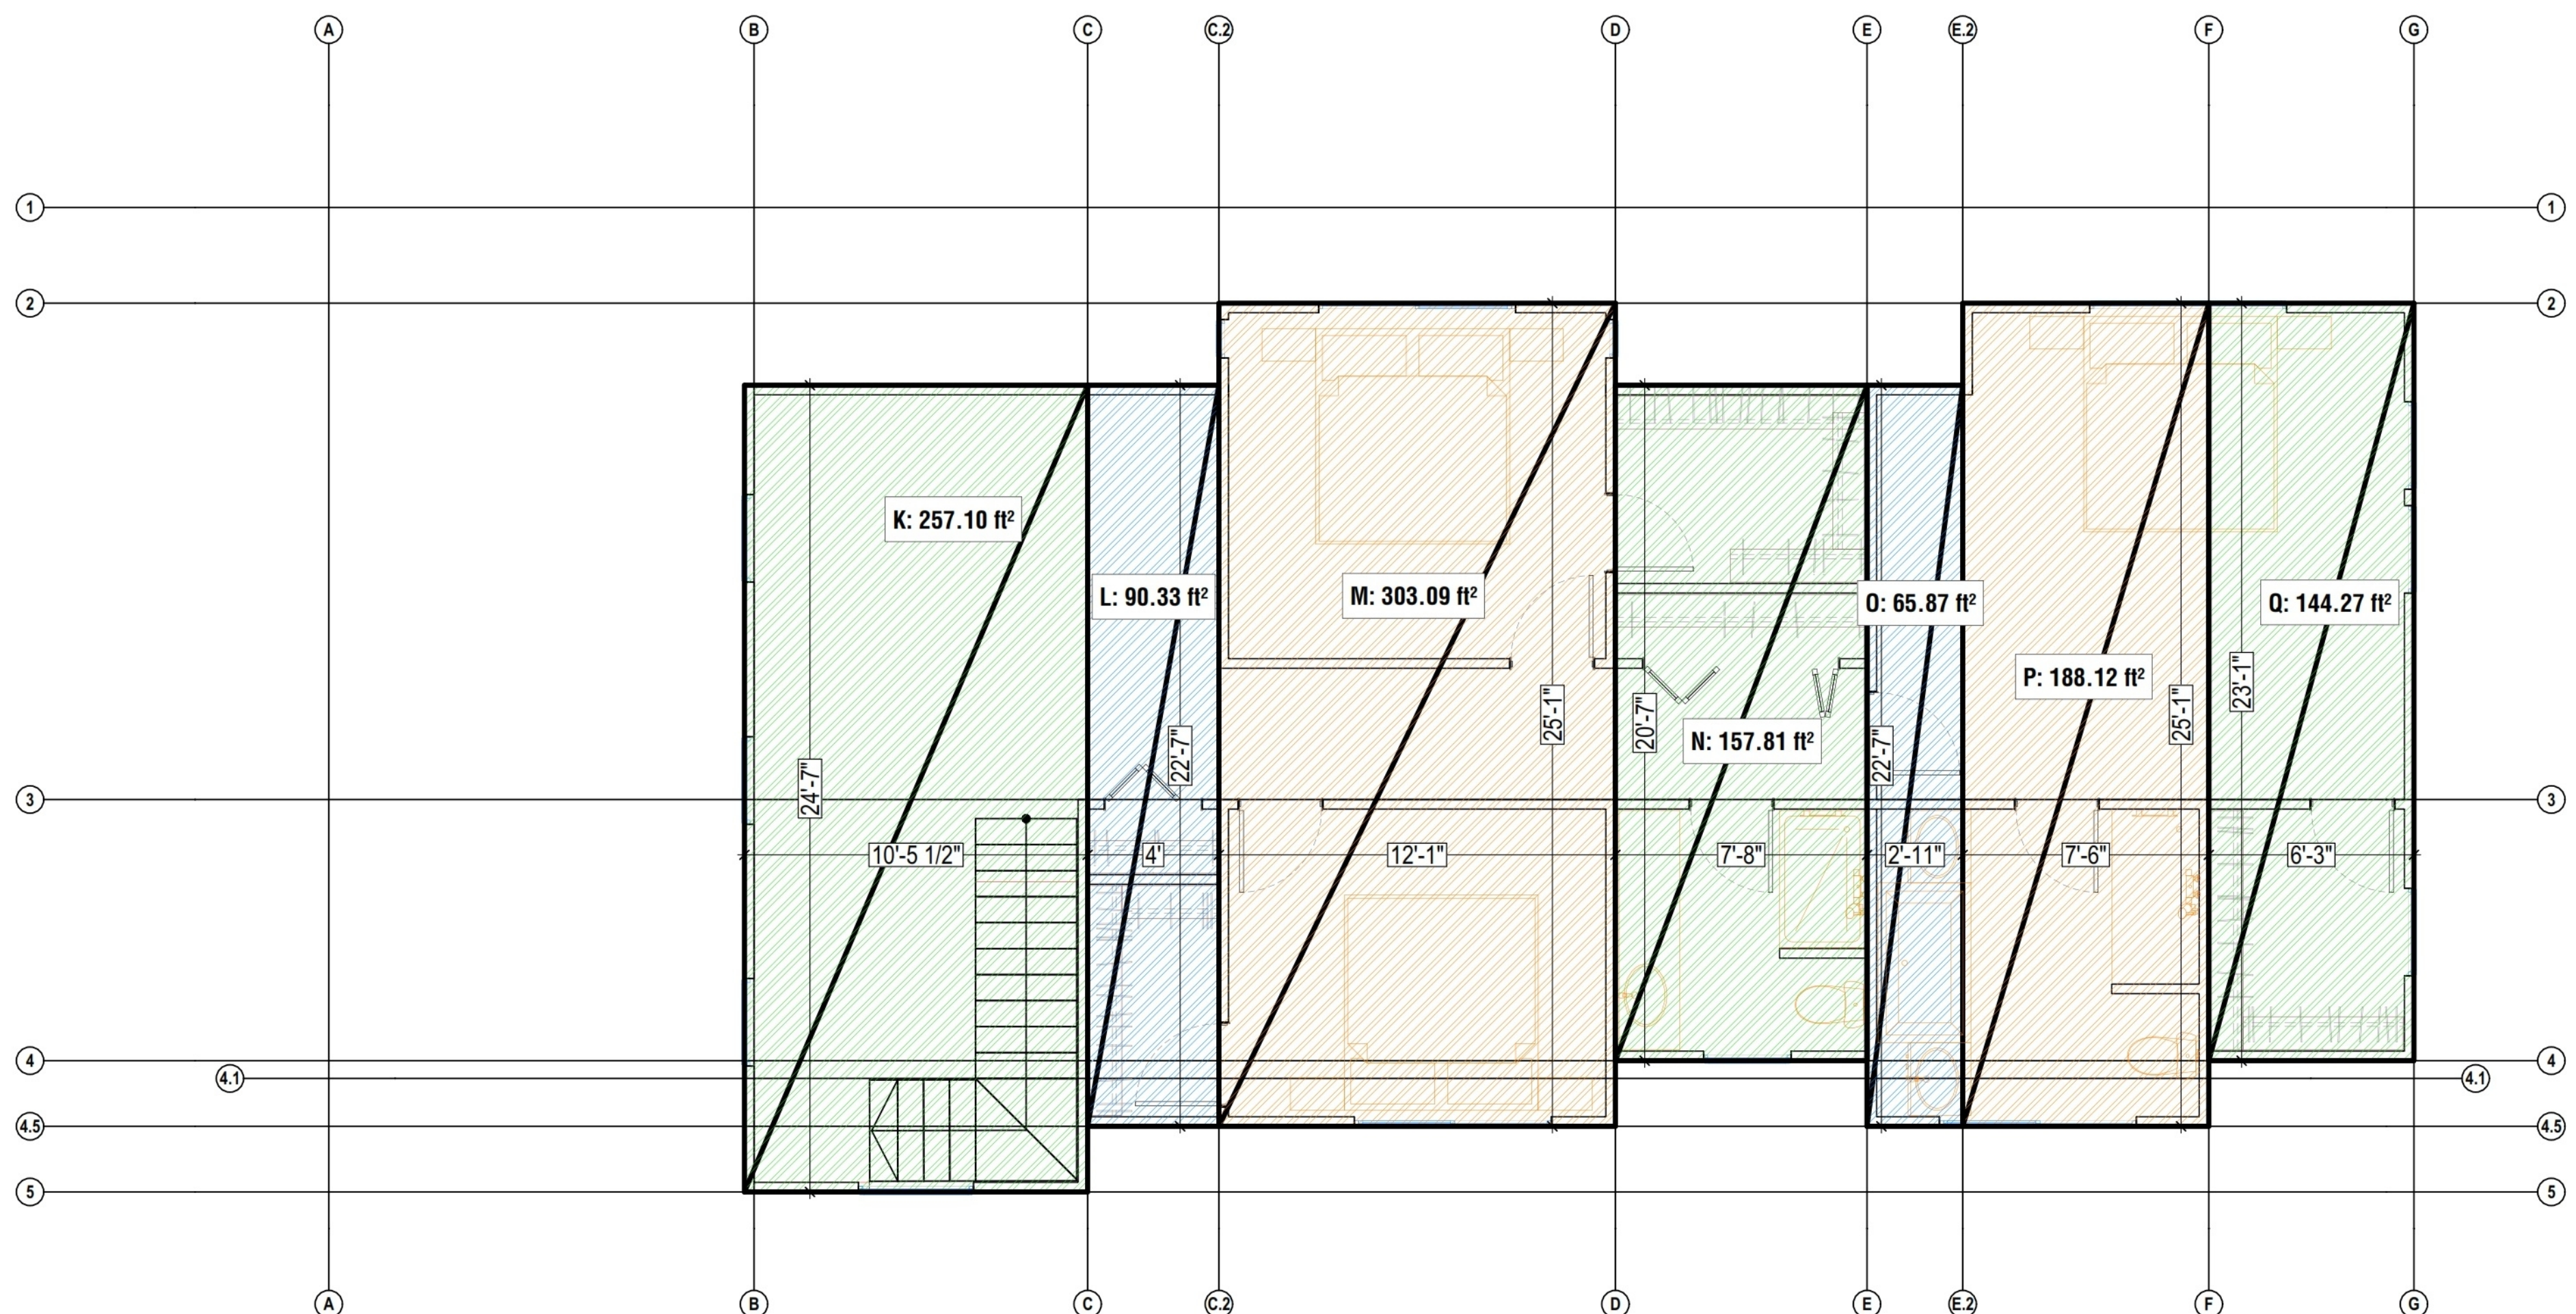




A FIRST FLOOR AREA CALC
SCALE: 1/4" = 1'-0"

AREA CALCULATIONS	
	AREA
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1 ST FLOOR	1,606.24 SQFT
2 ND FLOOR	1,164.30 SQFT
GARAGE	400 SQFT
FRONT PORCH	120.27 SQFT
SITE	6,254 SQFT

LOT COVERAGE	
ALLOWABLE COVERAGE (35%)	2,188.9 SQFT
PROPOSED	2,126.51 SQFT
PROPOSED	34.00%
ALLOWABLE	2,188.9 SQFT
ALLOWABLE	35%

FLOOR AREA RATIO	
ALLOWABLE FAR (53%)	3,314.62 SQFT
PROPOSED (51.46%)	3,290.81 SQFT
PROPOSED	3,290.81 ft ²
PROPOSED	52.62%
ALLOWABLE	3,314.62 ft ²
ALLOWABLE	53%

AREA CALC	
ID	AREA (ft ²)
A	343.94
B	240.19
C	403.42
D	176.97
E	261.28
F	144.27
G	36.17
G	36.17
I1	71.72
I2	48.56
K	257.10
L	90.33
M	303.09
N	157.81
O	65.87
P	188.12
Q	144.27

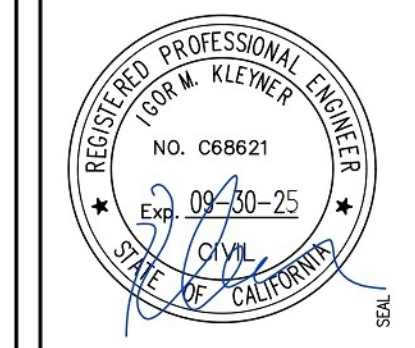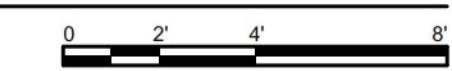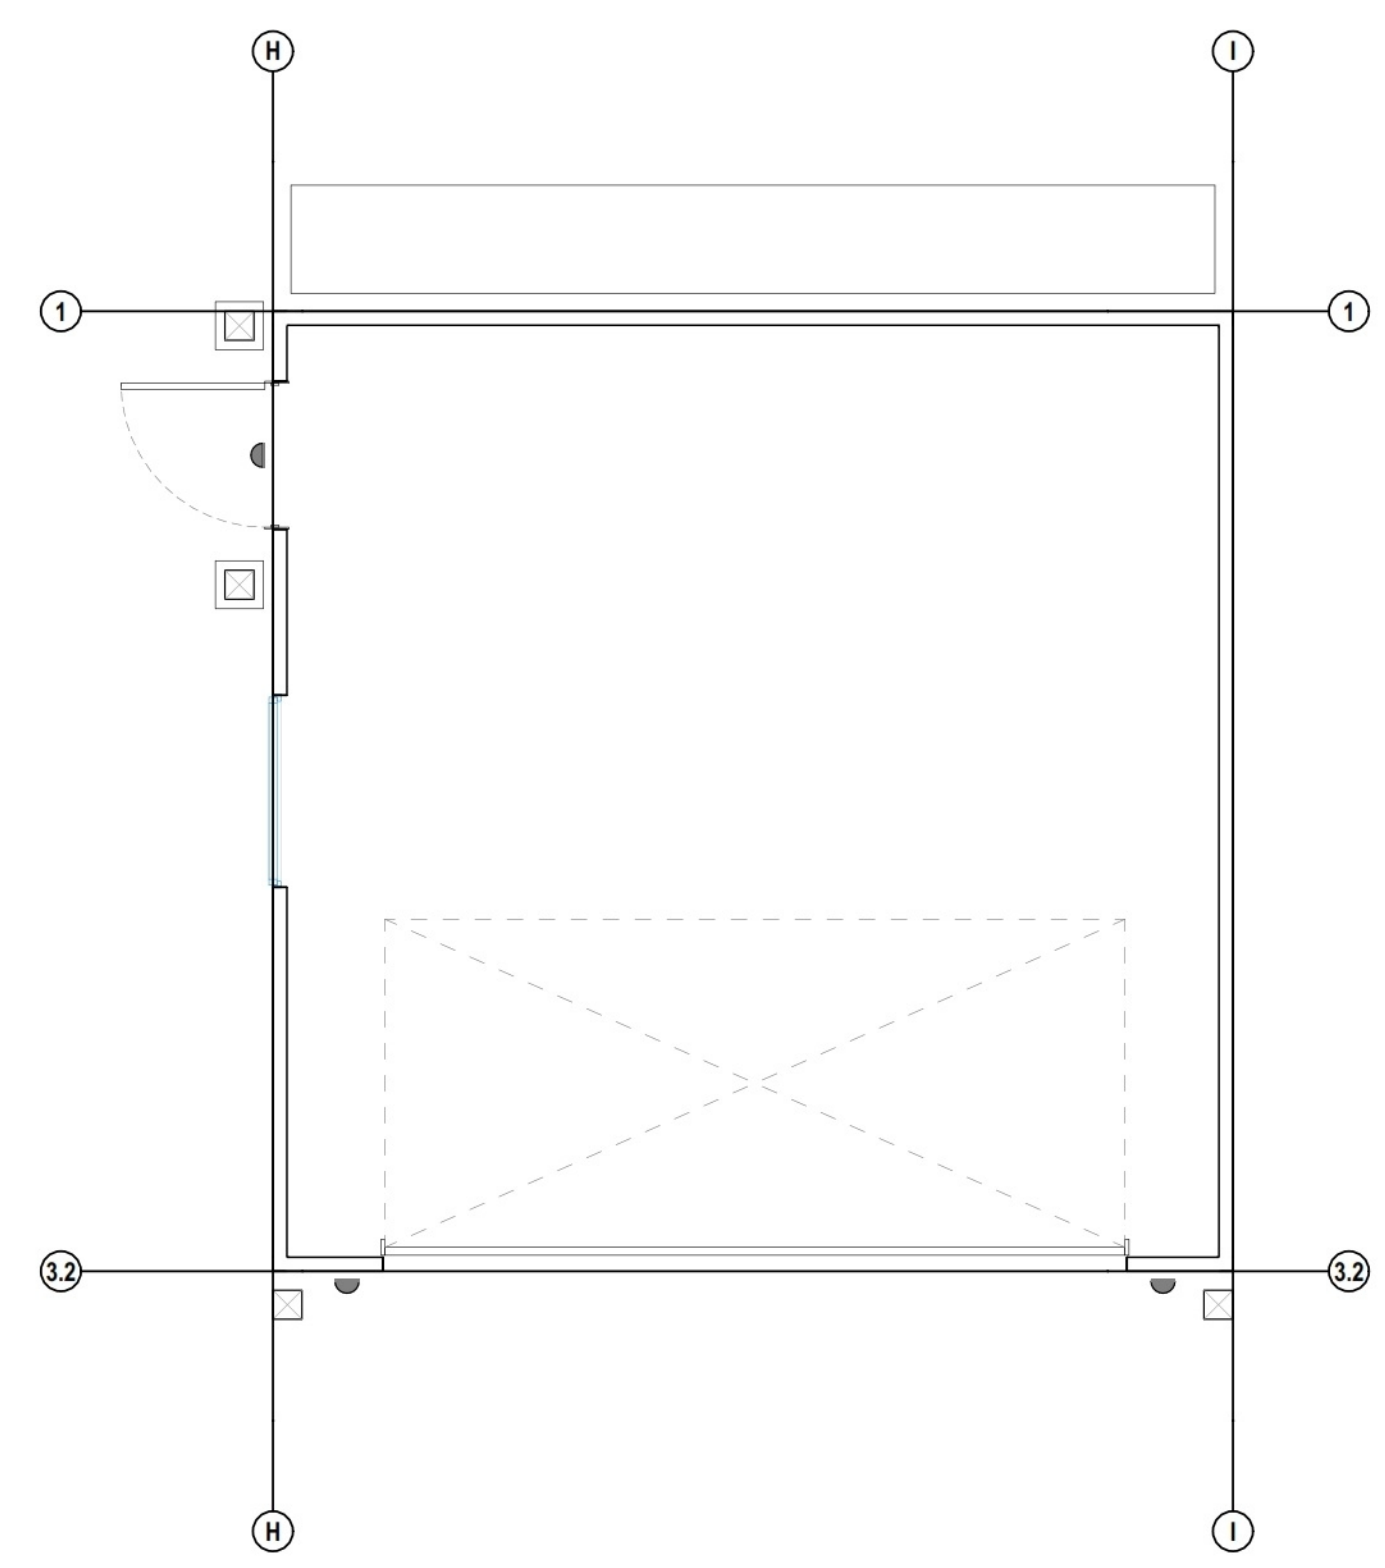

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PROJECT # : #Pin
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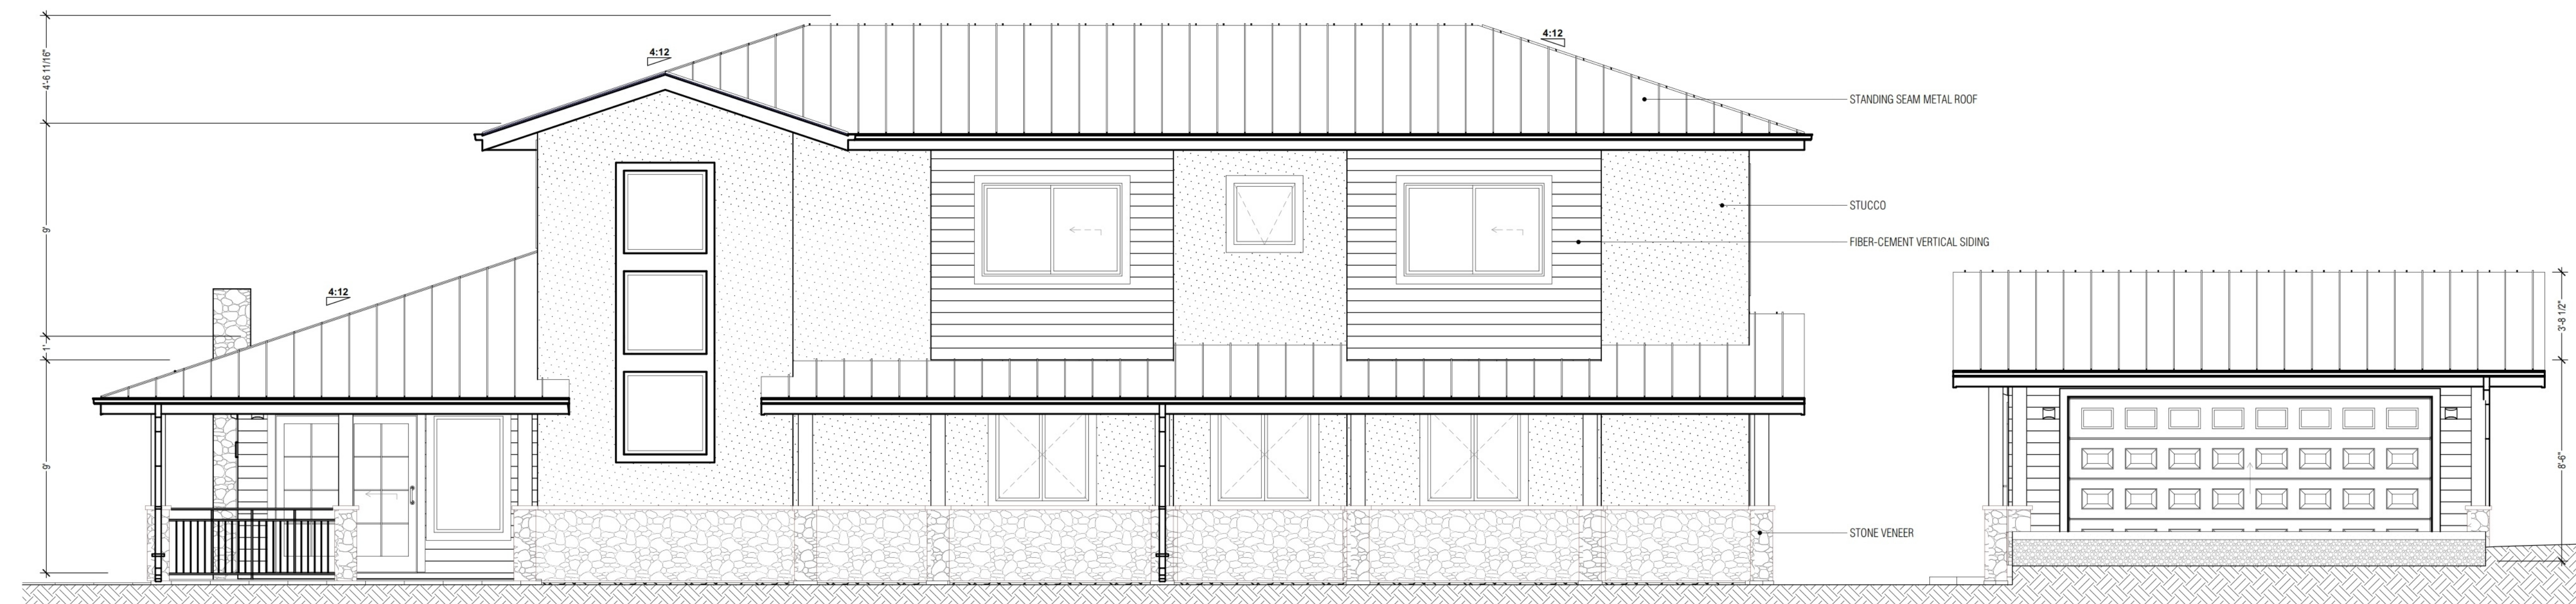
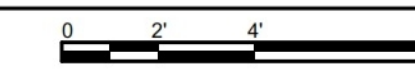
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DESIGNER : ALEX MARTYNOVSKIY
NAME :
SIGNATURE : DATE :



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SCALE : AS SHOWN



D PROPOSED SOUTH-EAST ELEVATION (LEFT)
SCALE: 1/4" = 1'-0"



E PROPOSED NORTH-WEST ELEVATION (RIGHT)
SCALE: 1/4" = 1'-0"

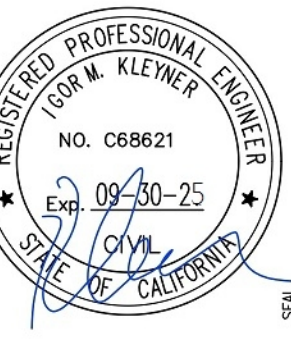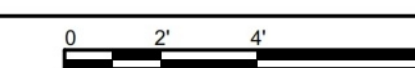

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MONTARA, CA 94037

ALPN 036-103-620

OWNER MARINA FASTOVSKAYA

SHEET TITLE PROPOSED EXTERIOR ELEVATIONS

DESIGNER ALEX MARTYNOVSKIY
NAME
SIGNATURE DATE


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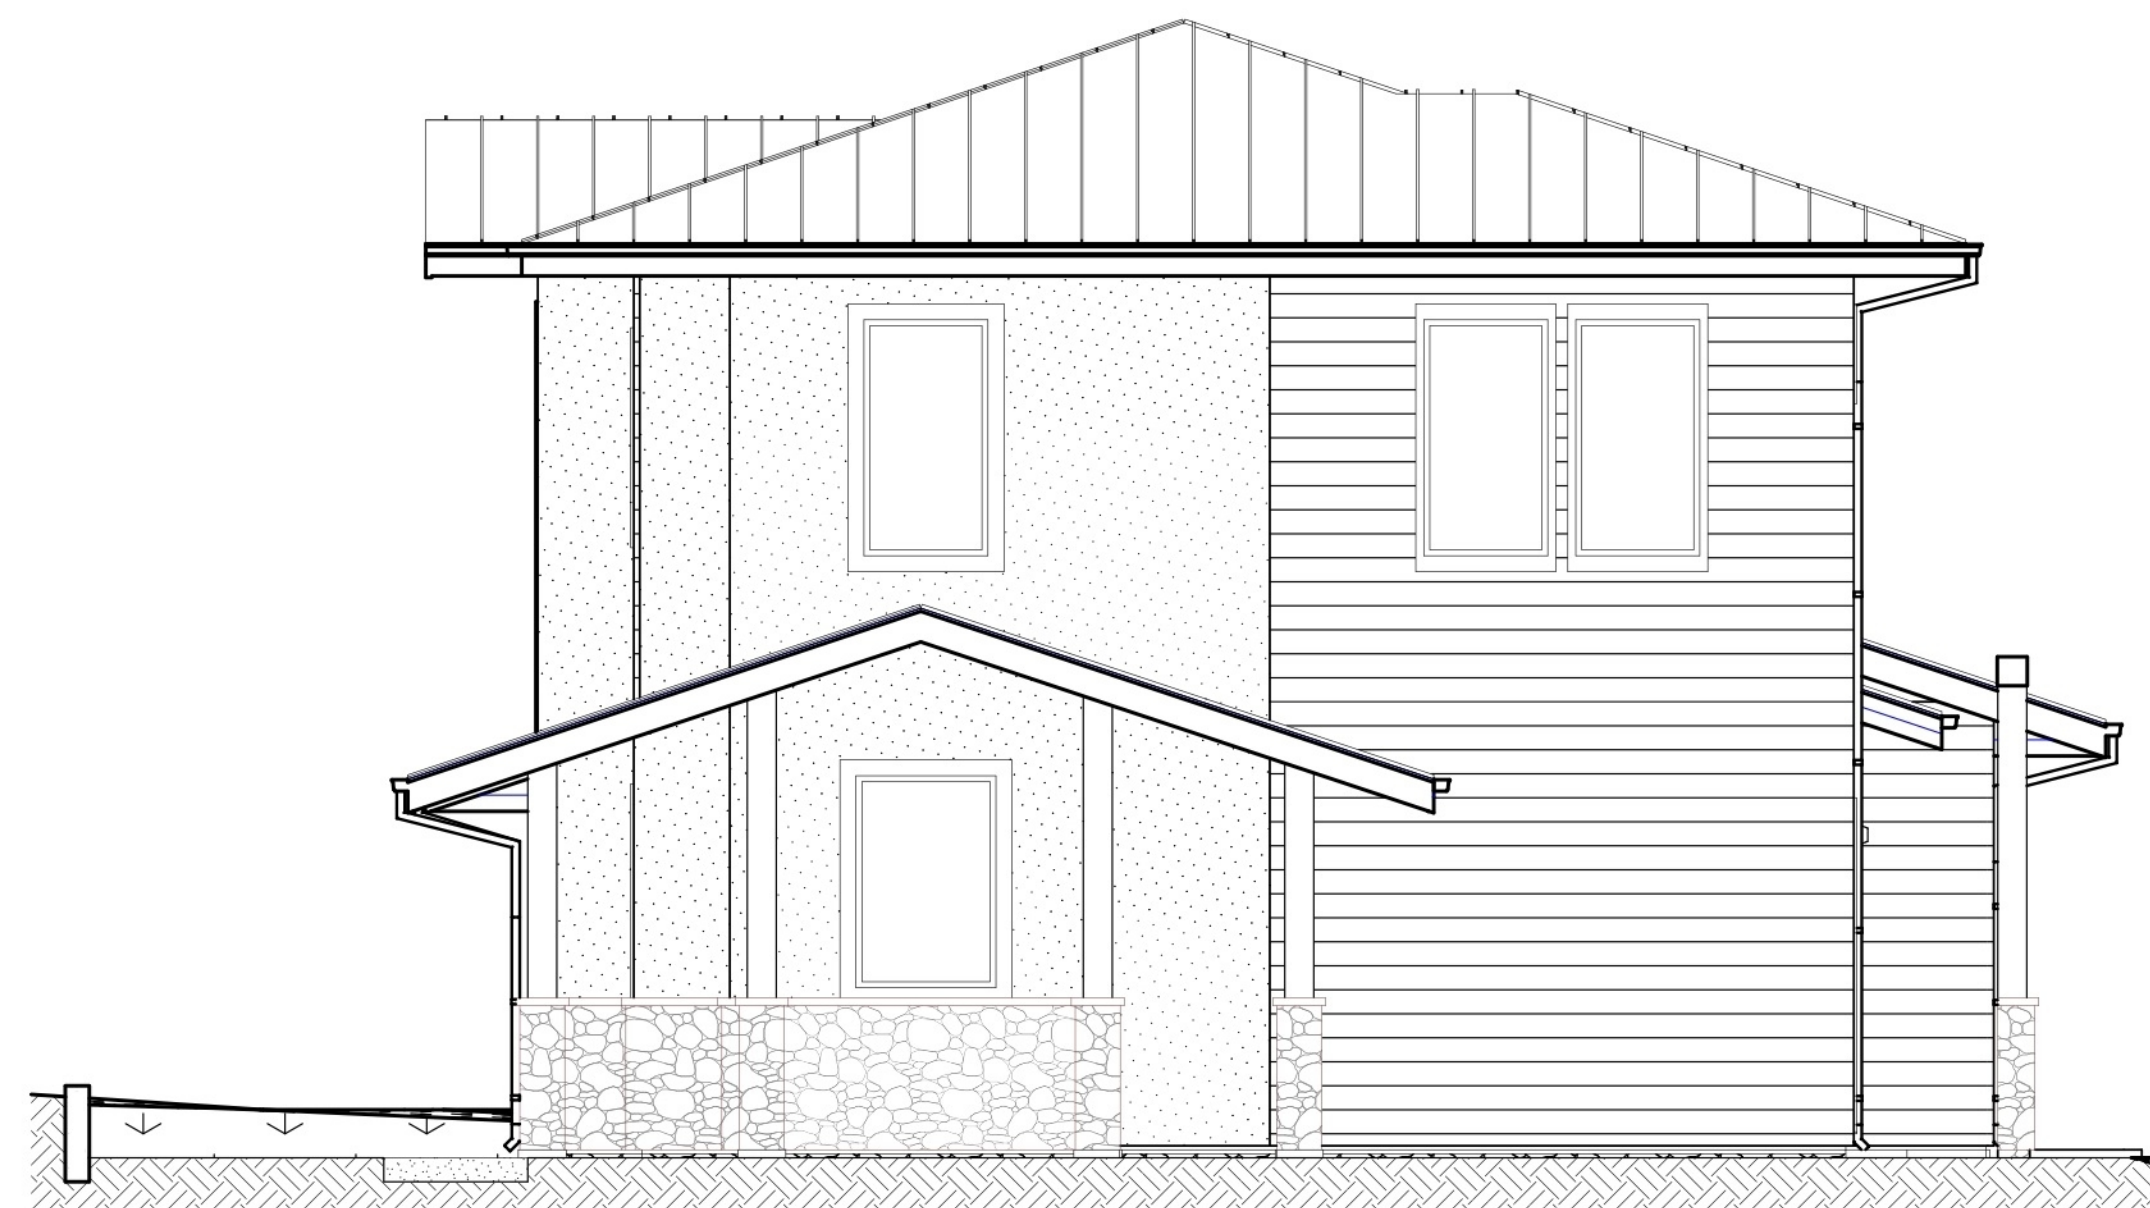
A3.0



B PROPOSED NORTH-EAST ELEVATION @ GARAGE (FRONT)
SCALE: 1/4" = 1'-0"



A PROPOSED NORTH-EAST ELEVATION (FRONT)
SCALE: 1/4" = 1'-0"

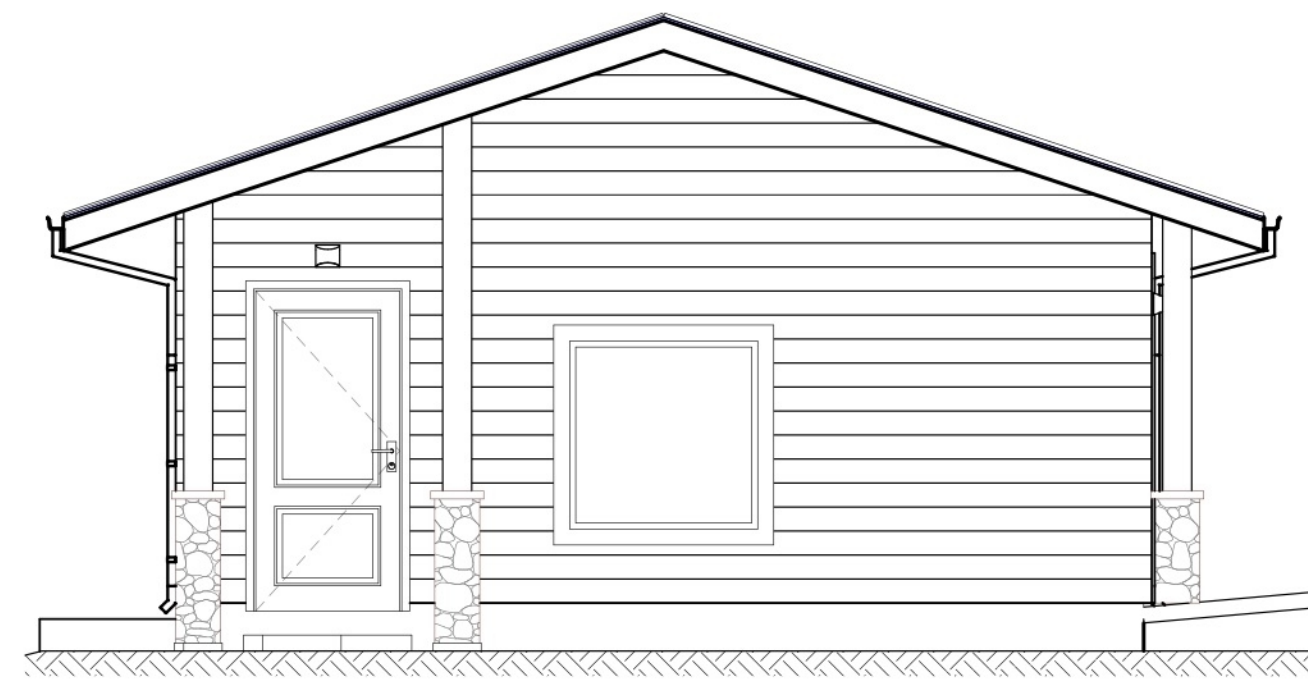

D PROPOSED SOUTH-WEST ELEVATION (BACK)
SCALE: 1/4" = 1'-0"



C PROPOSED SOUTH-WEST ELEVATION @ GARAGE (BACK)
SCALE: 1/4" = 1'-0"



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SHEET TITLE
PROPOSED EXTERIOR ELEVATIONS


DESIGNER
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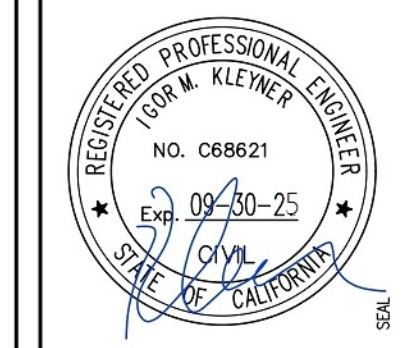
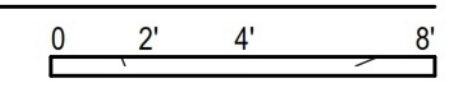
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A ROOF PLAN
SCALE: 1/4" = 1'-0"



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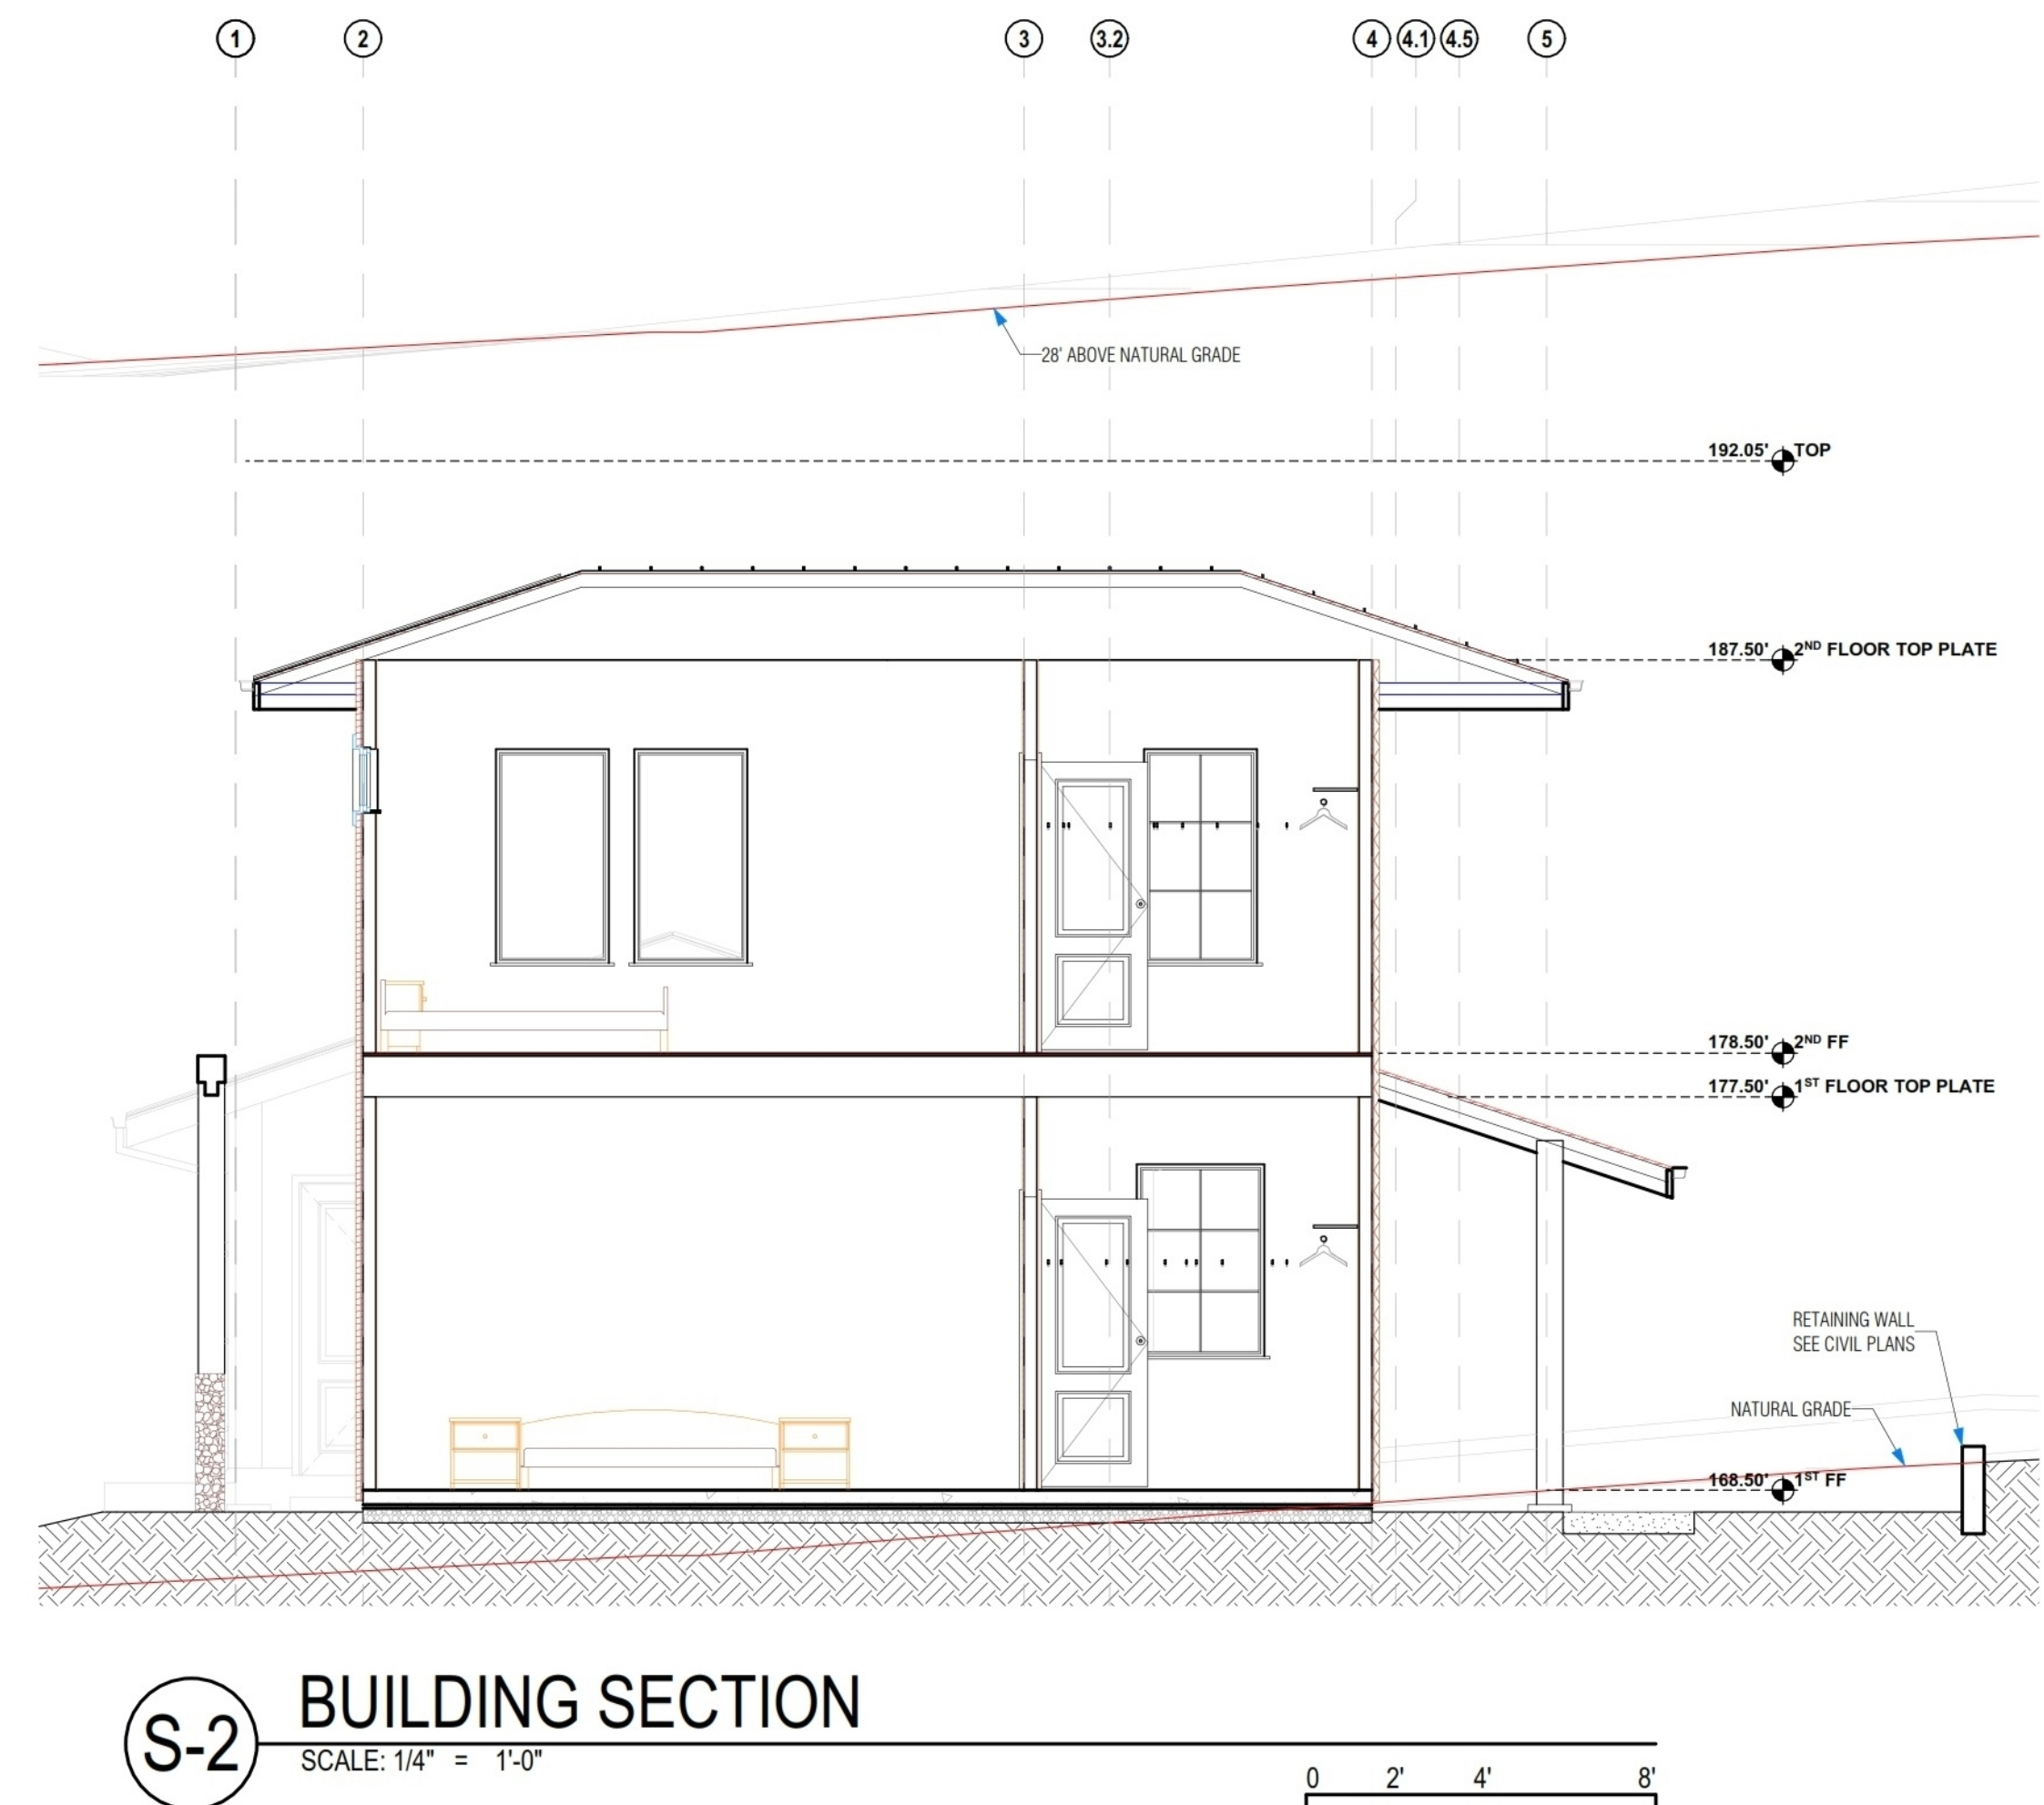
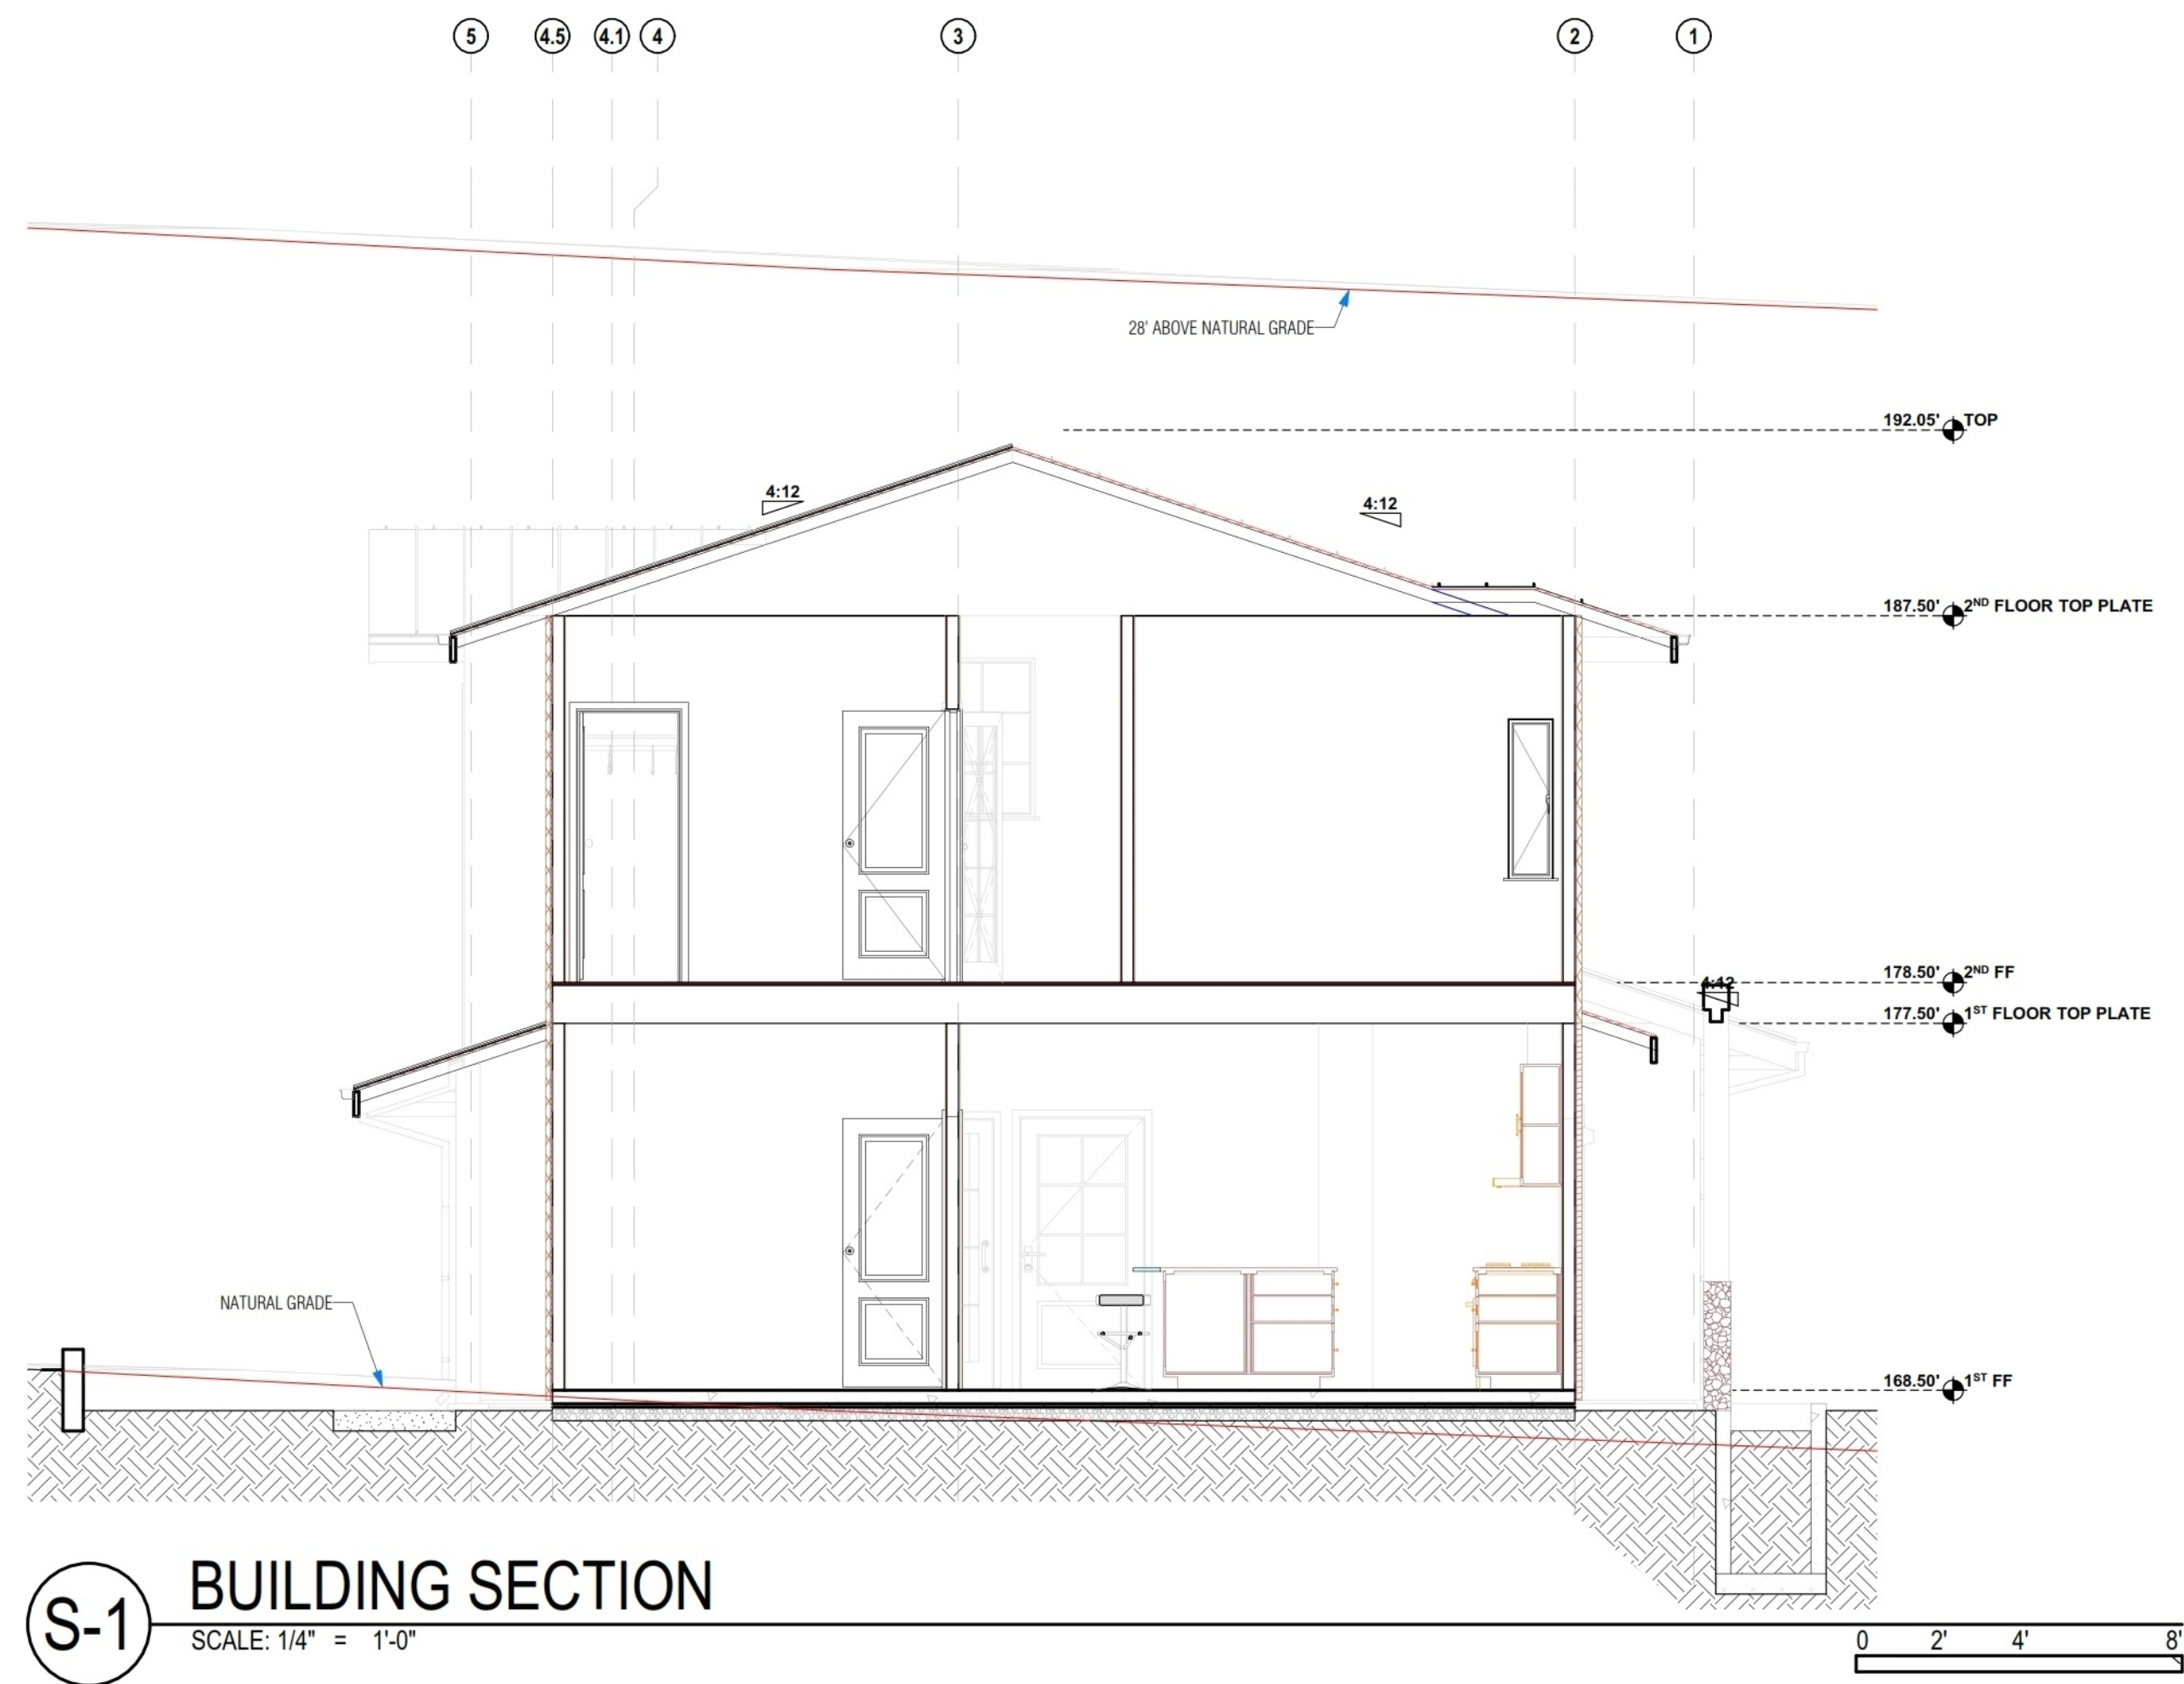
APN: 036-103-620
OWNER: MARINA FASTOVSKAYA

SHEET TITLE: ROOF PLAN

DESIGNER: ALEX MARTYNOVSKIY
NAME: _____
SIGNATURE: _____ DATE: _____

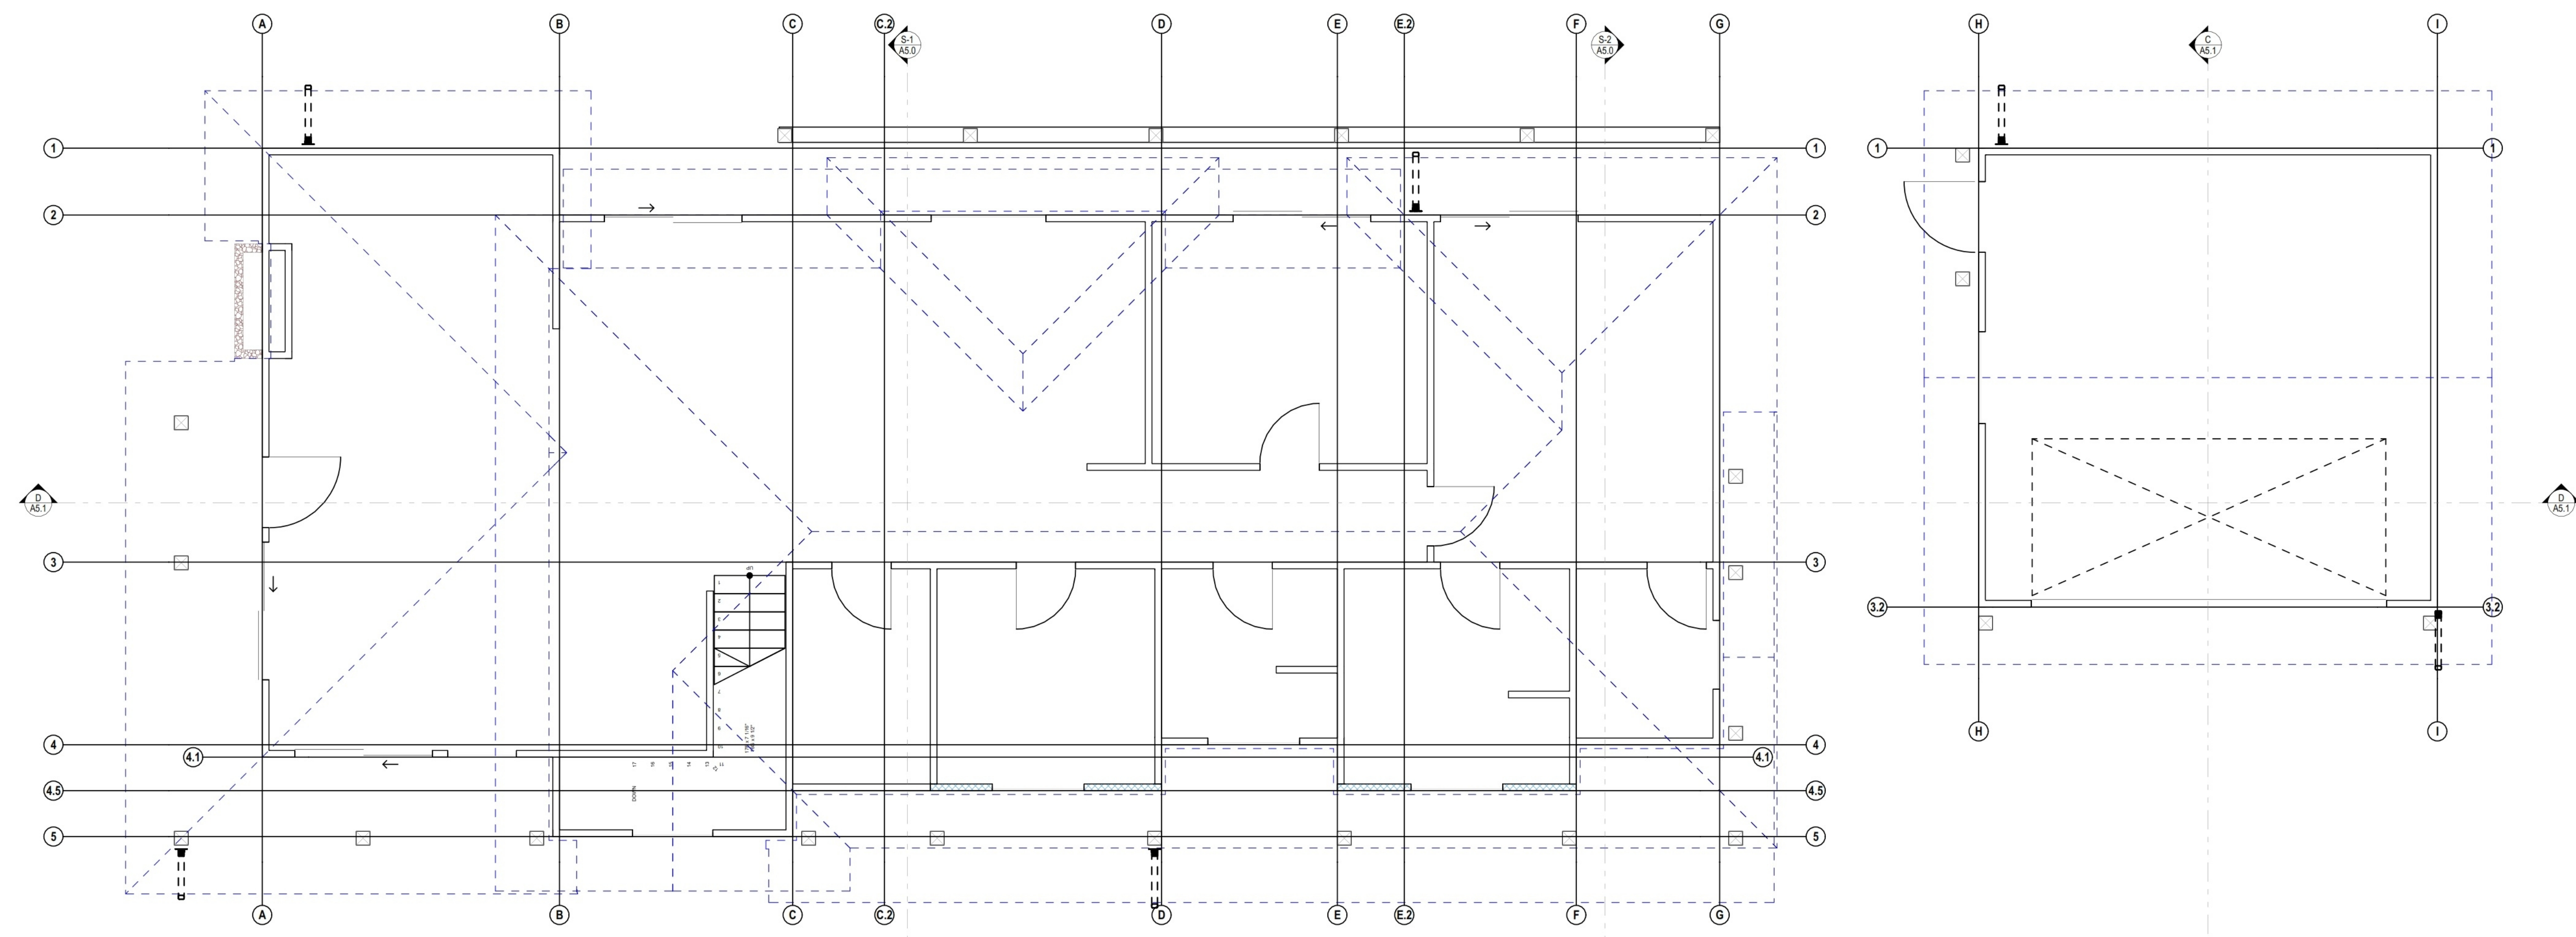PROJECT #: #Pin
DATE: 5/3/2022
DRAWN BY: #Contact Custom
SCALE: AS SHOWN

A4.0



ALEX MARTYNOVSKIY
ALEX.MARTYNOVSKIY@PROTONMAIL.COM

DATE	BY

NEW SINGLE FAMILY DWELLING
700 GEORGE ST.
MONTARA, CA 94037

APN: 036-103-620

OWNER: MARINA FASTOVSKAYA

SHEET TITLE: BUILDING SECTIONS

DESIGNER: ALEX MARTYNOVSKIY
NAME: _____
SIGNATURE: _____ DATE: _____


PROJECT #: #Pin

DATE: 5/3/2022

DRAWN BY: #Contact Custom

SCALE: AS SHOWN

A5.0

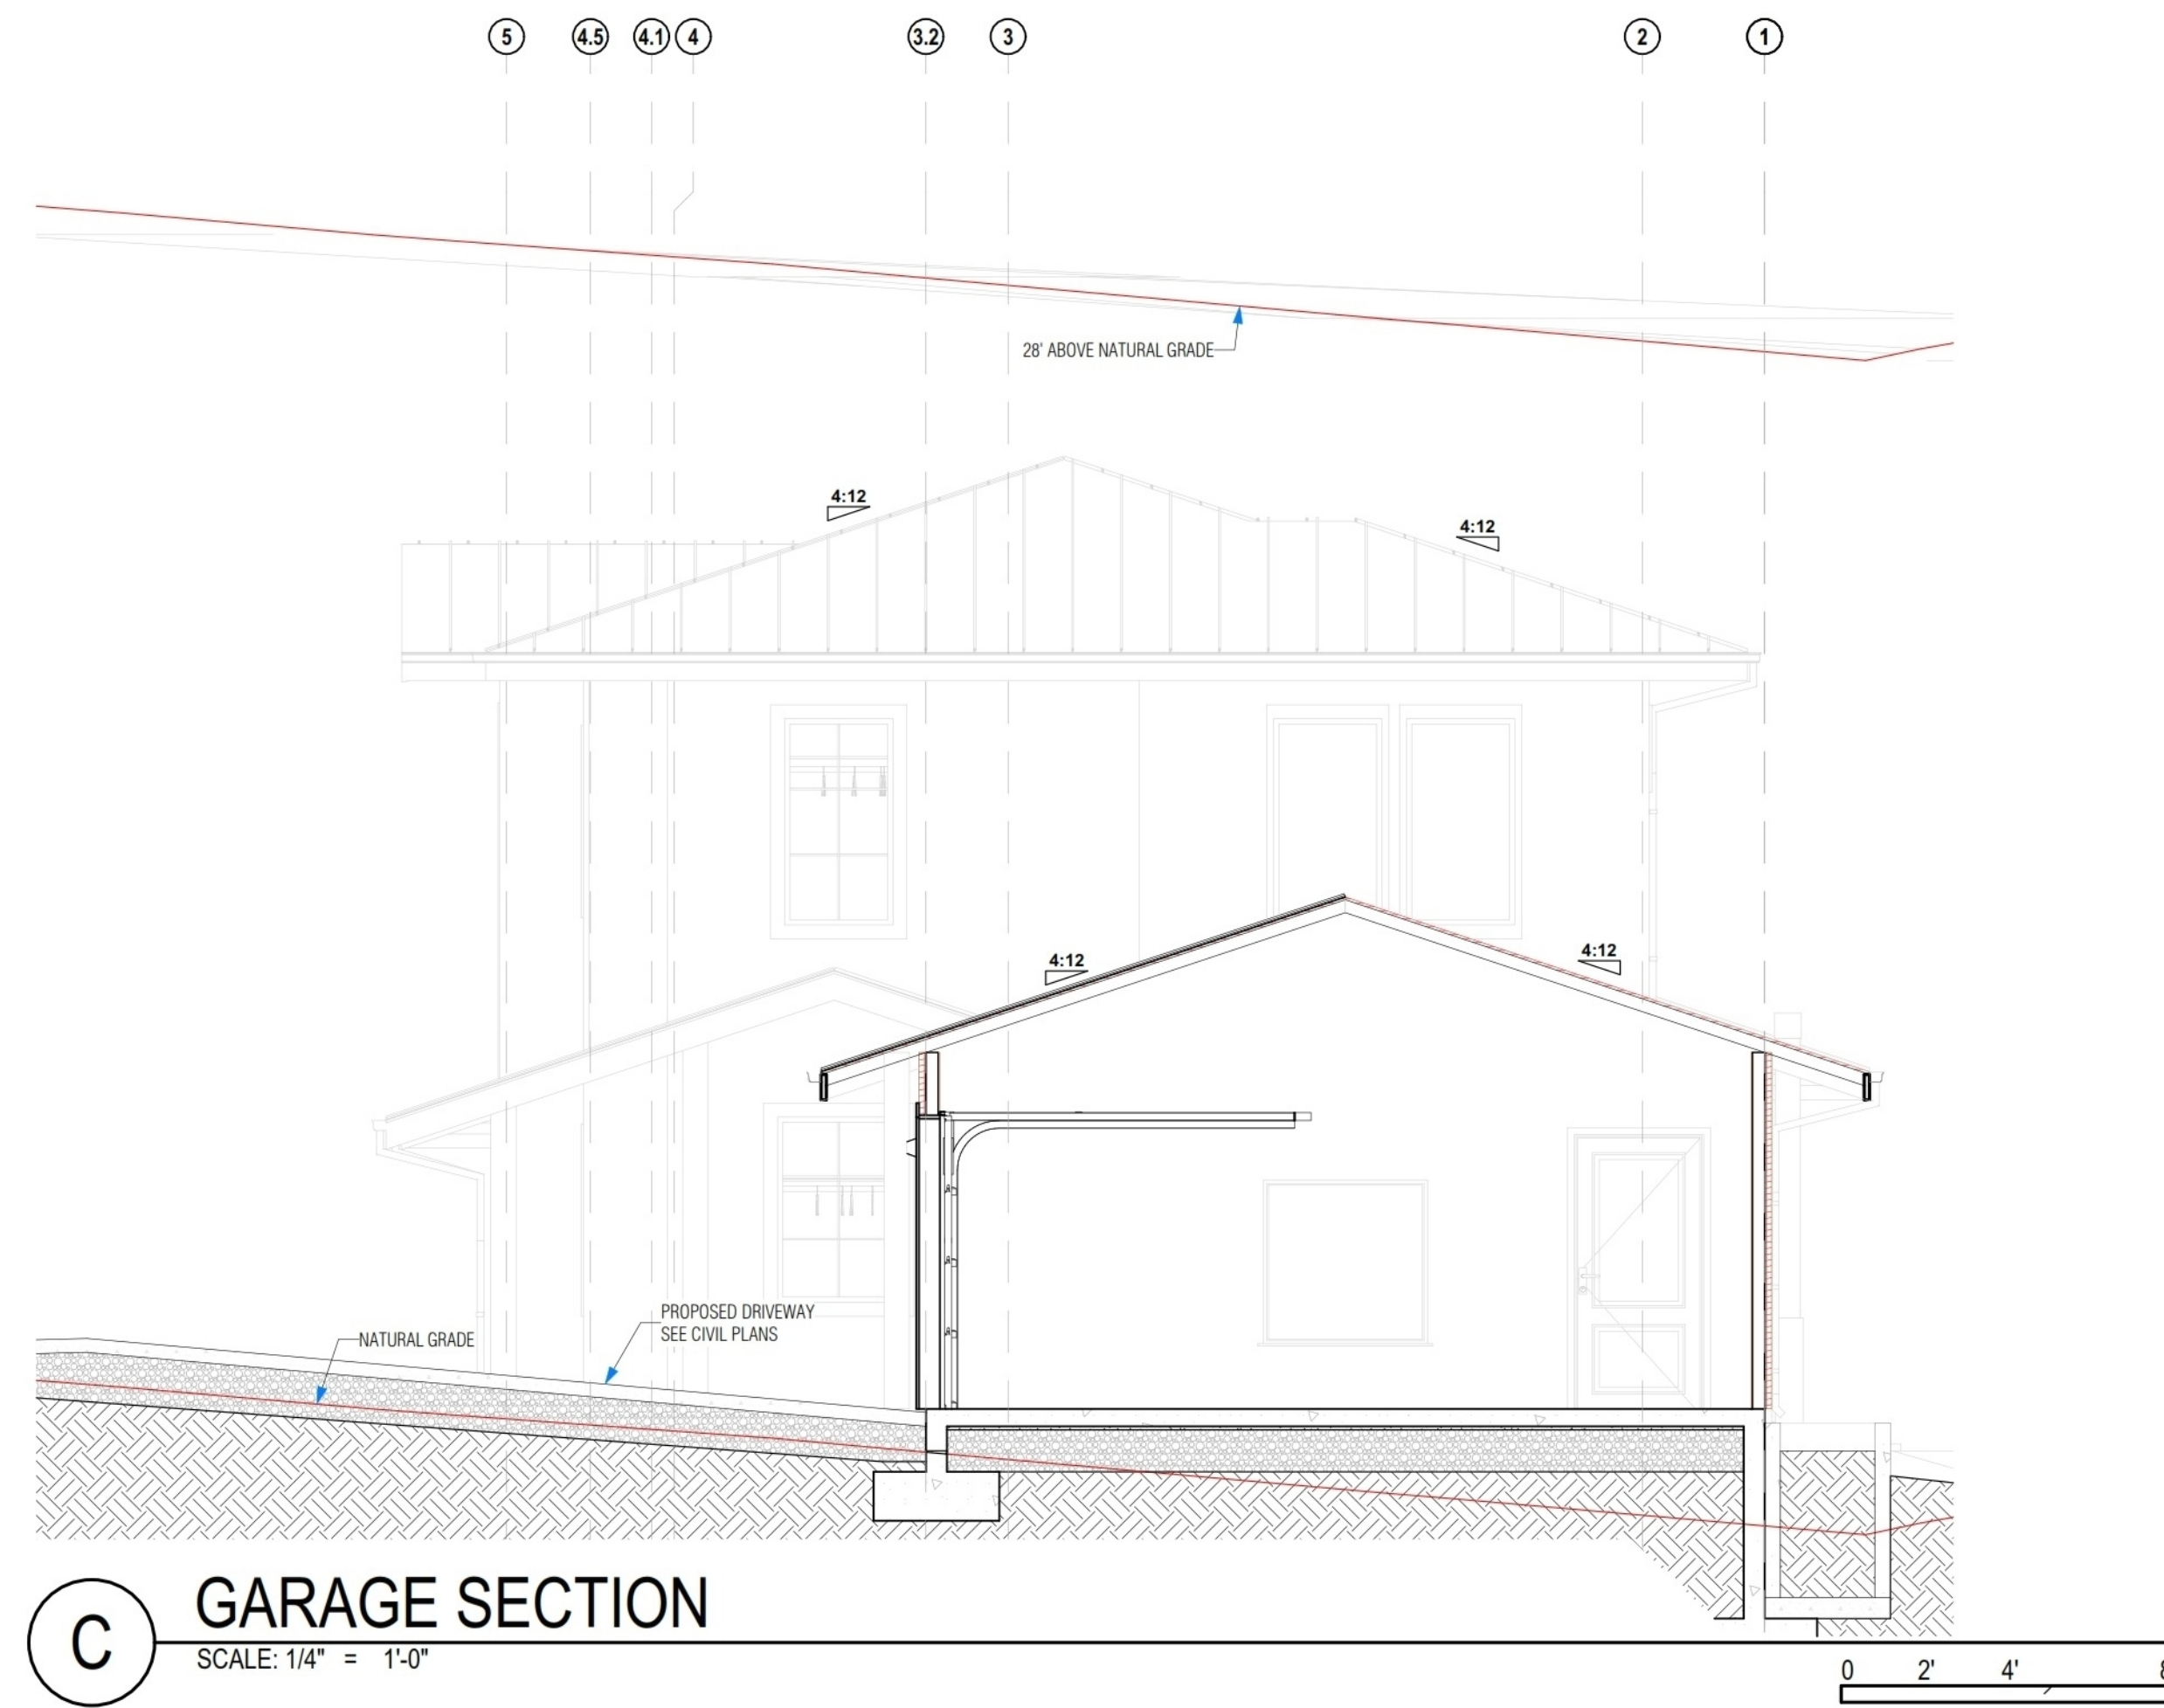



ALEX MARTYNOVSKIY
ALEX.MARTYNOVSKIY@PROTONMAIL.COM


	DATE	BY

NEW SINGLE FAMILY DWELLING
700 GEORGE ST.
MONTARA, CA 94037


ALPN 036-103-620	OWNER MARINA FASTOVSKAYA														
SHEET TITLE BUILDING SECTIONS															
<table border="1" style="width: 100%; border-collapse: collapse;"> <tr> <td style="width: 15%;">DESIGNER</td> <td style="width: 85%;">ALEX MARTYNOVSKIY</td> </tr> <tr> <td>NAME</td> <td> </td> </tr> <tr> <td>SIGNATURE</td> <td>DATE</td> </tr> <tr> <td>PROJECT #</td> <td>#Pin</td> </tr> <tr> <td>DATE</td> <td>5/3/2022</td> </tr> <tr> <td>DRAWN BY</td> <td>#Contact Custom</td> </tr> <tr> <td>SCALE</td> <td>AS SHOWN</td> </tr> </table>		DESIGNER	ALEX MARTYNOVSKIY	NAME		SIGNATURE	DATE	PROJECT #	#Pin	DATE	5/3/2022	DRAWN BY	#Contact Custom	SCALE	AS SHOWN
DESIGNER	ALEX MARTYNOVSKIY														
NAME															
SIGNATURE	DATE														
PROJECT #	#Pin														
DATE	5/3/2022														
DRAWN BY	#Contact Custom														
SCALE	AS SHOWN														

A5.1

PLANT SCHEDULE																							
TREES						SHRUBS						ORNAMENTAL GRASSES											
No	KEY	QTY	BOTANICAL NAME	COMMON NAME	SIZE/CONDITION	DESIGNATION	IMAGE	No	KEY	QTY	BOTANICAL NAME	COMMON NAME	SIZE/CONDITION	DESIGNATION	IMAGE	No	KEY	QTY	BOTANICAL NAME	COMMON NAME	SIZE/CONDITION	DESIGNATION	IMAGE
1	CRH	1	Ceanothus x 'Ray Hartman'	RAY HARTMAN CEANOTHUS	5-Gal			5	Cc	2	Carpenteria californica	BUSH ANEMONE	5-Gal			8	FjE	43	Festuca glauca 'Elijah Blue'	ELIJAH BLUE BLUE FESCUE	1-Gal		
2	FSG	4	Fremontodendron x 'San Gabriel'	CALIFORNIA FLANNEL BUSH	5-Gal			6	Cis	4	Cistus x purpureus	ORCHID ROCK ROSE	5-Gal			9	PJS	4	Phormium 'Jack Spratt'	JACK SPRATT FLAX	1-Gal		
3	PvC	9	Prunus caroliniana 'Compacta'	COMPACTA CAROLINA LAUREL CHERRY	15-Gal			7	RnC	5	Ribes sanguinum Claremont	PINK FLOWERING CURRANT	5-Gal			10	Ts	12	Thymus serpyllum	WILD THYME	1-Gal		
4	FP	3	Fern Pine	PODOCARPUS GRACILIOR	24"-Box			7	Ph	15	Pittosporum tenuifolium	SILVER SHEEN (PRIVACY HEDGE)	5-Gal			11	LTG	8	Lantana x 'Trailing Gold'	TRAILING GOLD LANTANA	1-Gal		

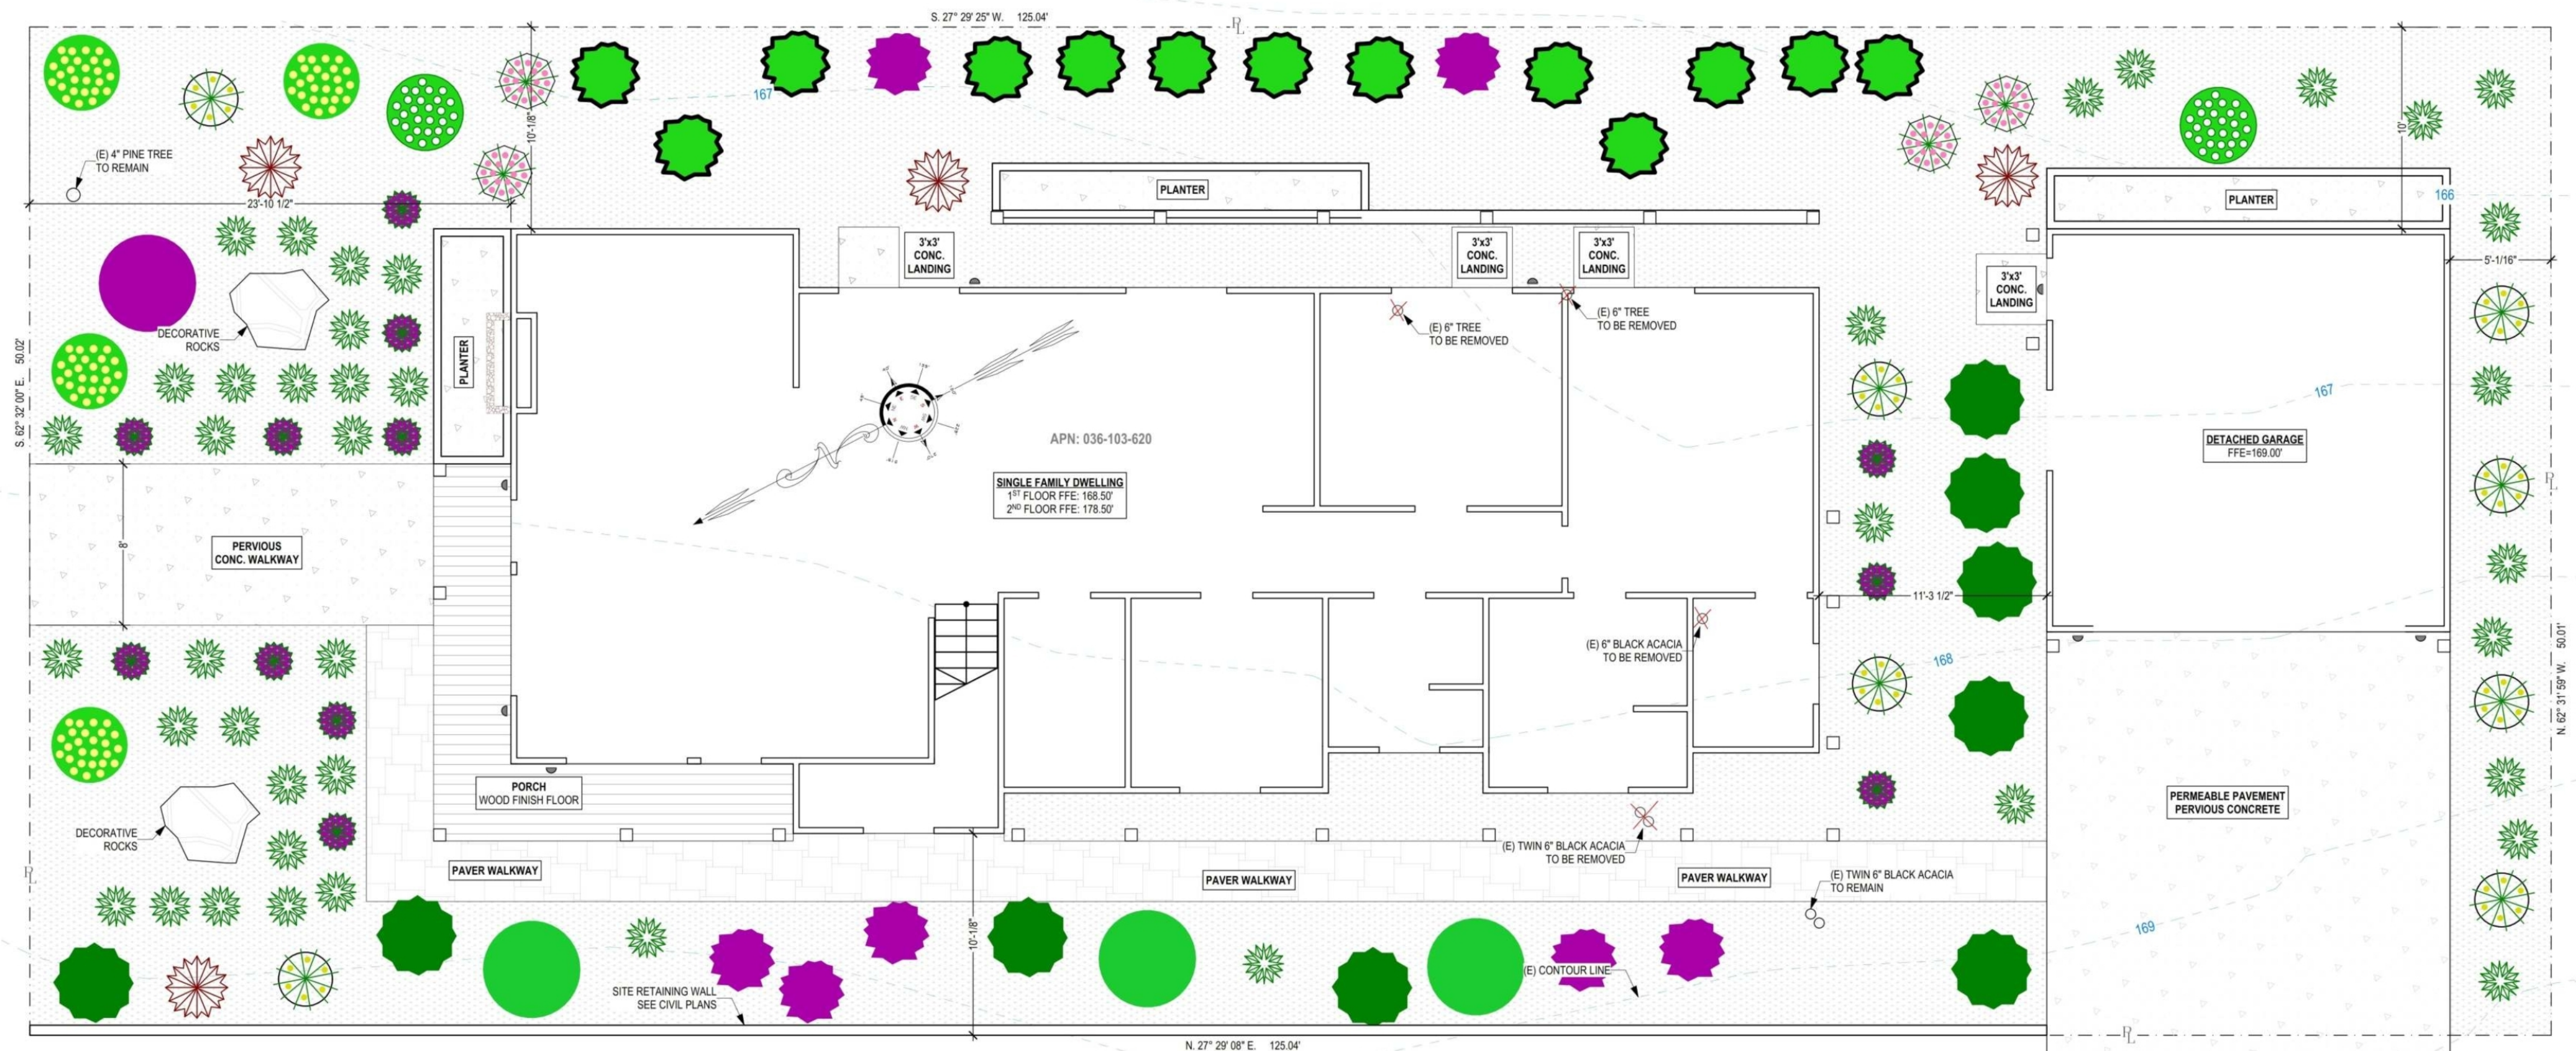

A LANDSCAPING
SCALE: 3/16" = 1'-0"

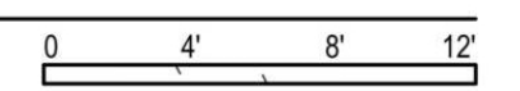

ALEX MARTYNOVSKIY
ALEX.MARTYNOVSKIY@PROTONMAIL.COM

DATE	BY

NEW SINGLE FAMILY DWELLING
700 GEORGE ST.
MONTARA, CA 94037

APN: 036-103-620
OWNER: MARINA FASTOVSKAYA

SHEET TITLE: LANDSCAPE PLAN

DESIGNER: ALEX MARTYNOVSKIY
NAME: _____
SIGNATURE: _____ DATE: _____



PROJECT #: #Pin
DATE: 5/3/2022
DRAWN BY: #Contact Custom
SCALE: AS SHOWN

L1.0

Job: Modern Tech Resources 1
 Units: Ft-CY
 Wed Jun 7, 2023 21:40:25 Page 1


Volume Report
Design vs Existing

Job Site	Total	Cut	Area		Volume		Comp/Ratio		Compact		Export -Import	Change Per 0.1 ft
			Fill	OnGrade	Cut	Fill	Cut	Fill	Cut	Fill		
	6,738	1,998	4,037	703	26	134	1.00	1.00	26	134	-108	25

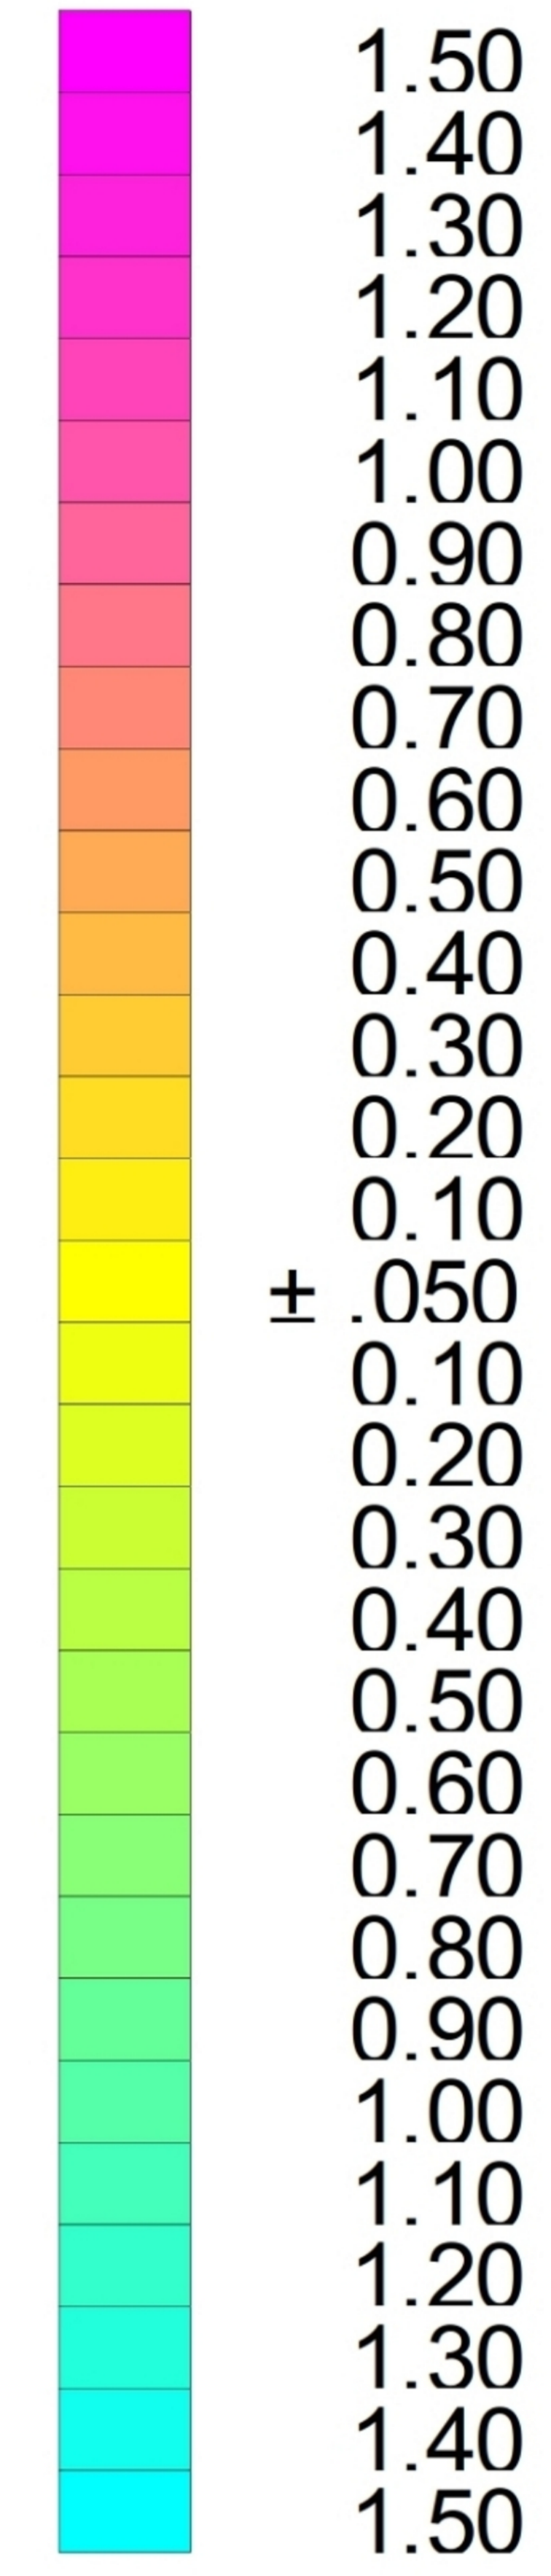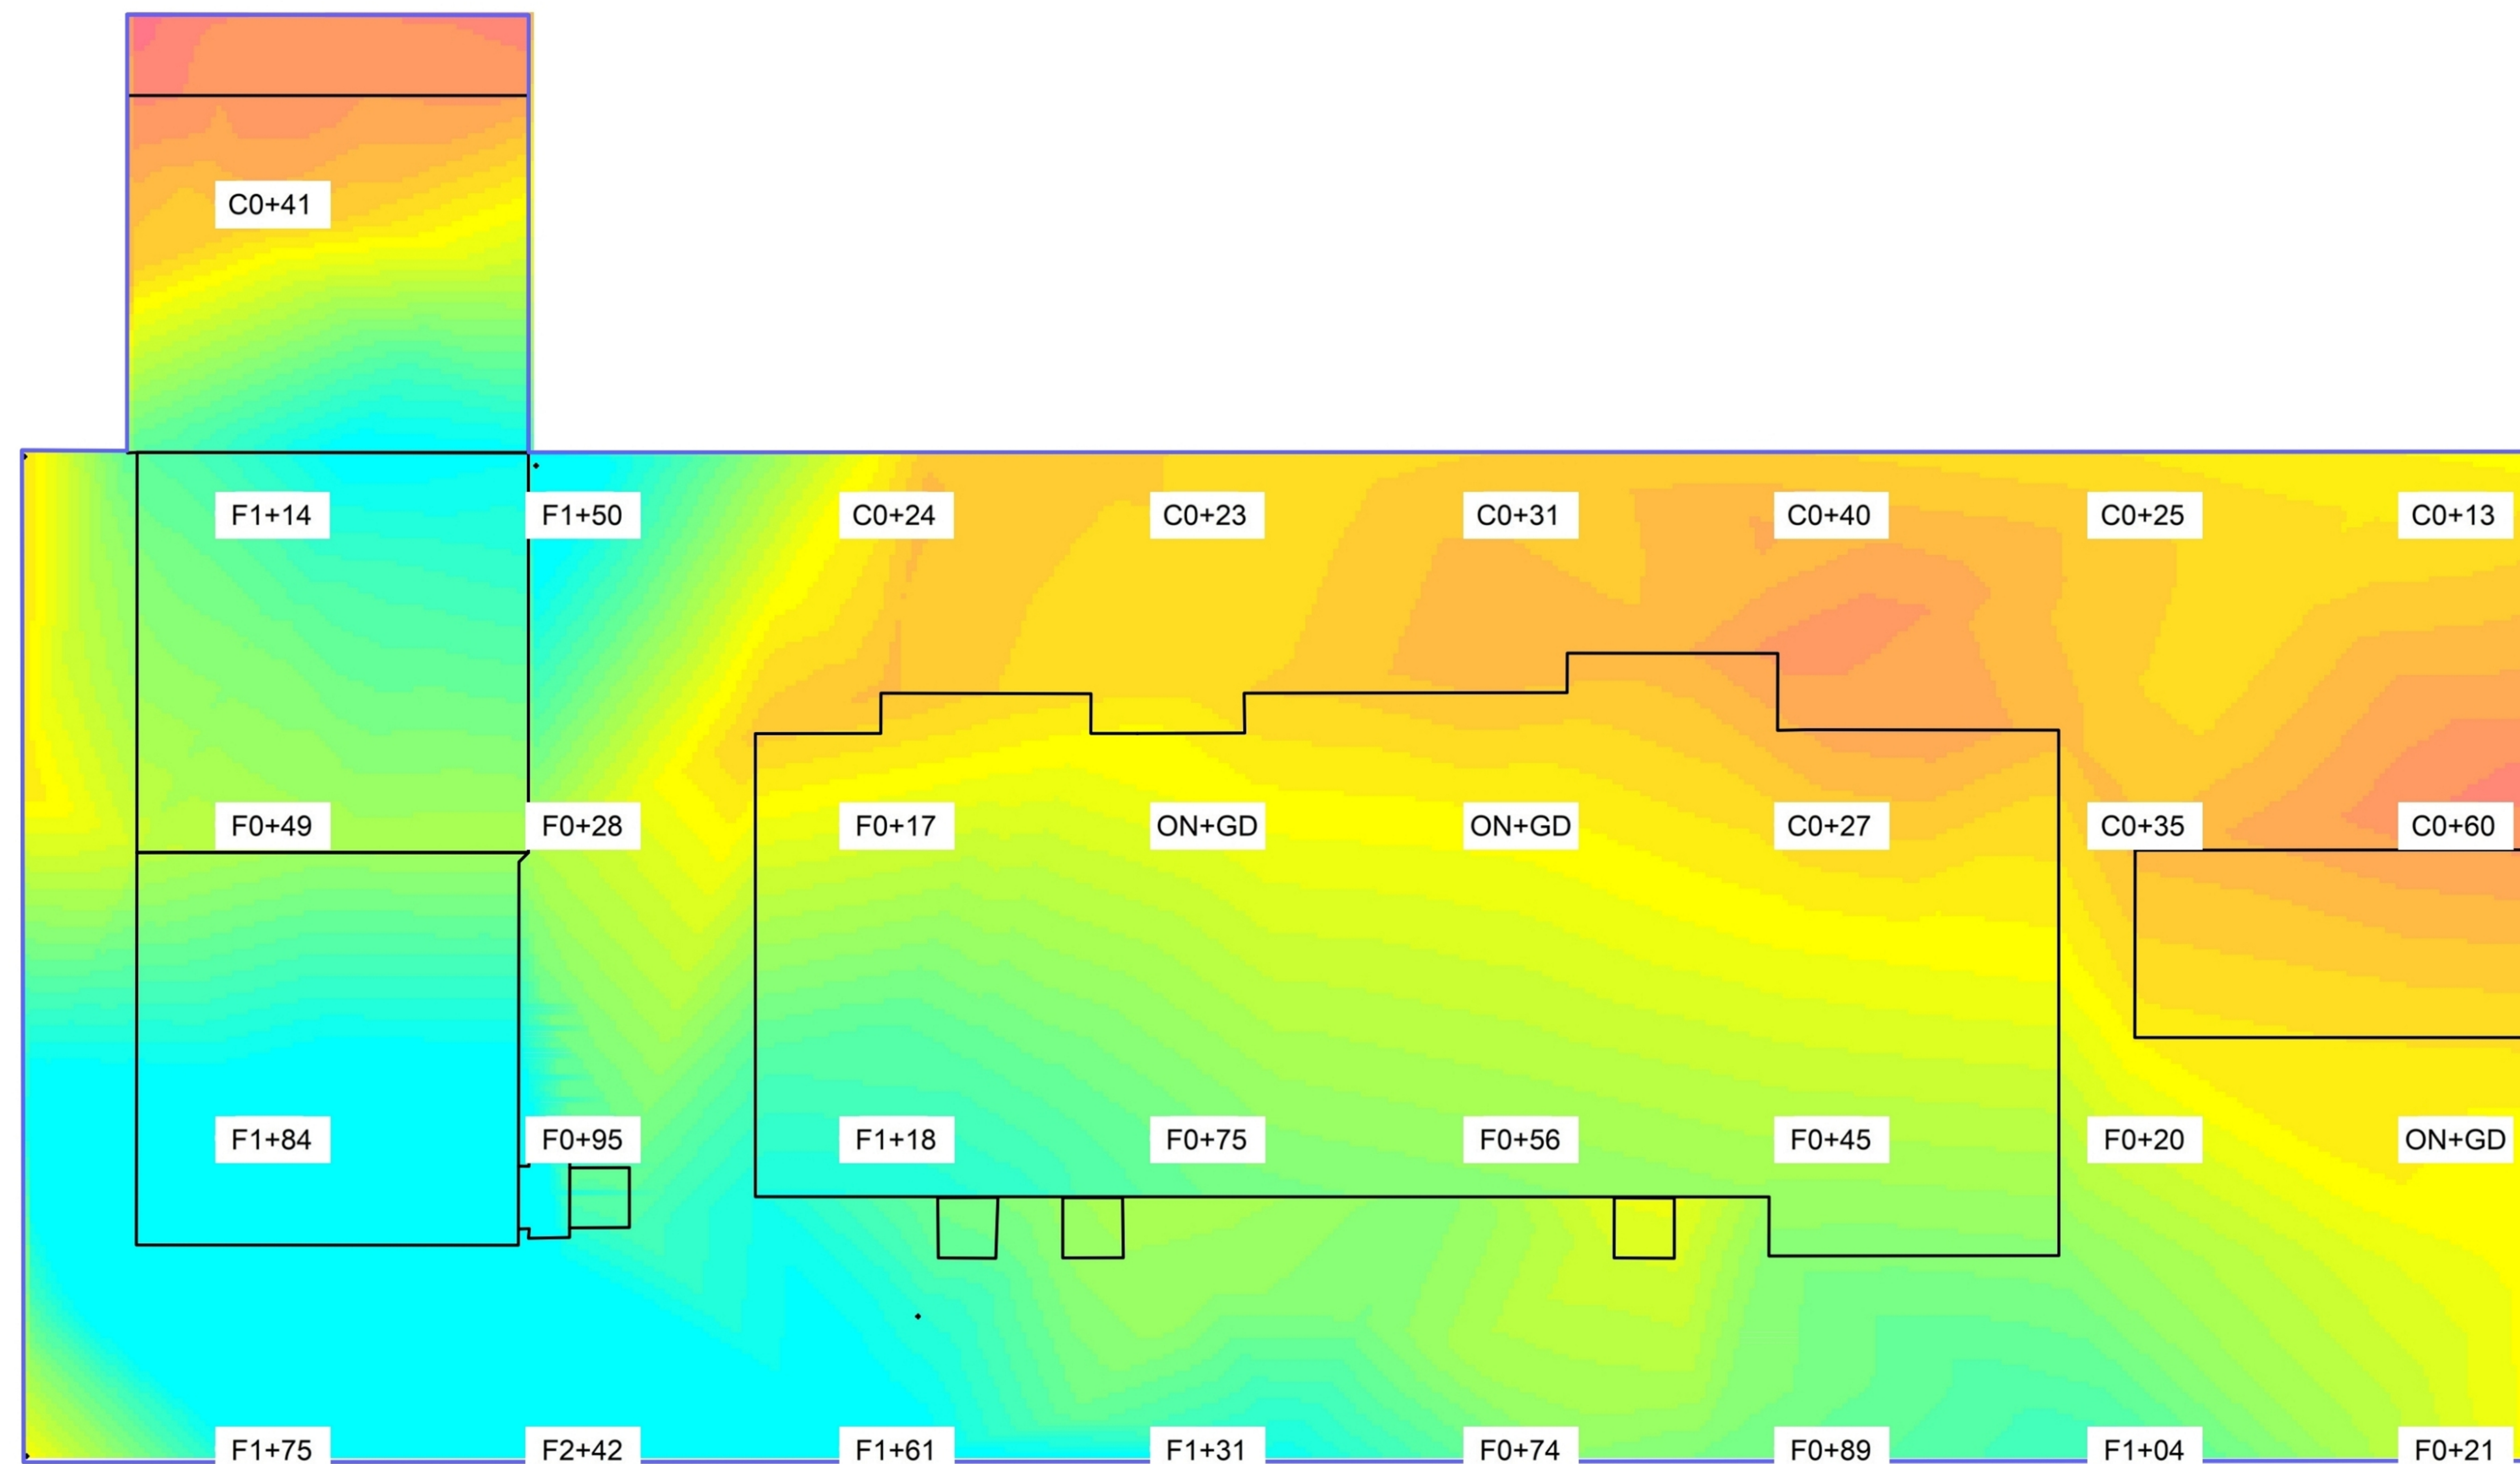

TYPE OF WORK	VOLUME, CUB YARD
1. Grading	- 108
2. Building & retaining wall foundation	+ 32.5
3. Planters & fence	+ 10
Total balance	65.5 cub yard import

NO.	DESCRIPTION	DATE	APPROVED
A	FOR REVIEW	02-21-24	IK

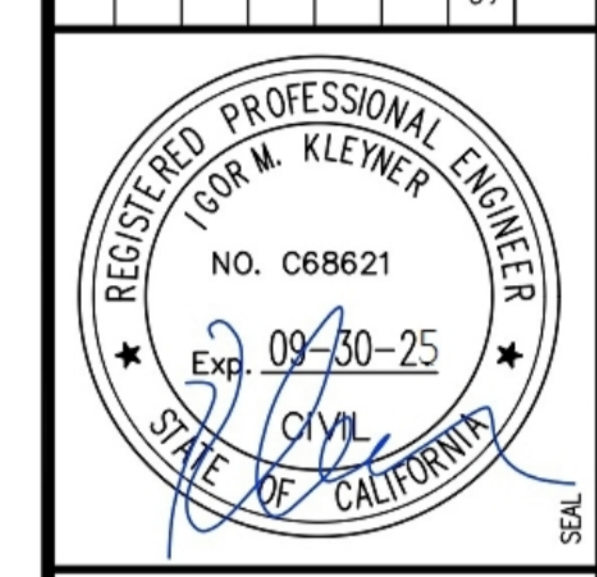

**MODERN TECHNOLOGY
 RESOURCES INC.**
 415.602.2290

**700 GEORGE ST @ BIRCH ST
 MONTARA, CA 94037
 APN: 036-103-620**

**EARTHWORK
 VOLUME
 CALCULATION**

DATE	FEBRUARY 2024
SCALE	AS SHOWN
DESIGN	IK
DRAWN	IK
PROJECT	23001
SHEET	OF

C1.4

GENERAL NOTES:

- 1. THESE PLANS REPRESENT THE OVERALL ON-SITE IMPROVEMENTS REQUIRED FOR PROJECT CONSTRUCTION. THE CONTRACTOR SHALL FURNISH, INSTALL, TEST AND COMPLETE ALL WORK TO THE SATISFACTION OF THE ENGINEER AND OWNER IN ACCORDANCE WITH THE CONTRACT DOCUMENTS. THE CONTRACTOR SHALL BE SOLELY RESPONSIBLE FOR MEANS AND METHODS OF CONSTRUCTION; AS SUCH, THESE PLANS DO NOT COMPLETELY REPRESENT, NOR ARE THEY INTENDED TO REPRESENT, ALL SPECIFIC INSTRUCTIONS REQUIRED FOR OFF-SITE CONSTRUCTION. THE CONTRACTOR SHALL BE RESPONSIBLE TO CONSTRUCT ALL IMPROVEMENTS DEPICTED ON THESE PLANS IN ACCORDANCE WITH ALL APPLICABLE RULES, REGULATIONS AND LAWS IN EFFECT AT THE TIME OF CONSTRUCTION.
- 2. THE CONTRACTOR SHALL ACCEPT THE SITE AS IS. THE CONTRACTOR SHALL ASSESS CONDITIONS, AND THE KIND, QUALITY AND QUANTITY OF WORK REQUIRED. THE OWNER MAKES NO GUARANTEE IN REGARD TO THE ACCURACY OF ANY AVAILABLE INFORMATION WHICH WAS OBTAINED DURING INVESTIGATIONS. THE CONTRACTOR SHALL MAKE A THOROUGH SITE INSPECTION IN ORDER TO FIELD CHECK EXISTING SITE CONDITIONS, CORRELATE CONDITIONS WITH THE DRAWINGS AND RESOLVE ANY POSSIBLE CONSTRUCTION CONFLICTS WITH THE OWNER AND ENGINEER PRIOR TO COMMENCEMENT OF WORK. THE CONTRACTOR SHALL MAKE ADDITIONAL TOPOGRAPHIC SURVEYS HE DEEMS NECESSARY, PROVIDED THEY ARE COORDINATED WITH THE OWNER. ANY CONDITIONS DETERMINED BY THE CONTRACTOR THAT DIFFER FROM THE INFORMATION SHOWN ON THE DRAWINGS THAT ARE NOT BROUGHT TO THE ATTENTION OF THE OWNER AND ENGINEER PRIOR TO THE START OF WORK SHALL NOT BE CONSIDERED GROUNDS FOR ADDITIONAL PAYMENT OR CHANGES TO THE CONTRACT DURATION, OR ANY OTHER CLAIMS AGAINST THE OWNER OR OWNER'S ENGINEER.
- 3. THE CONTRACTOR SHALL, WHEN THEY DEEM NECESSARY, PROVIDE WRITTEN REQUESTS FOR INFORMATION (RFI) TO THE OWNER AND ENGINEER PRIOR TO THE CONSTRUCTION OF ANY SPECIFIC SITEWORK ITEM. THE (RFI) SHALL BE IN A FORM ACCEPTABLE TO OWNER AND ENGINEER AND SHALL ALLOW FOR A MINIMUM OF TWO WORK DAYS OR ADDITIONAL REASONABLE TIME FOR A WRITTEN REPLY. RFIS SHALL BE NUMBERED CONSECUTIVELY BY DATE SUBMITTED. THE CONTRACTOR SHALL BE SOLELY RESPONSIBLE FOR SITEWORK ITEMS CONSTRUCTED DIFFERENTLY THAN INTENDED OR AS DEPICTED ON THE PLANS.
- 4. INFORMATION RELATED TO ELEVATIONS AND PROPOSED UTILITIES (SUCH AS GRADES, INVERT ELEVATIONS, RIM ELEVATIONS, GRATE ELEVATIONS, BUILDING FINISHED FLOOR ELEVATIONS, ETC.) MAY BE FOUND IN MORE THAN ONE LOCATION IN THE CONTRACT DOCUMENTS. THE CONTRACTOR SHALL SUFFICIENTLY REVIEW ALL PLANS, PROFILES AND ANY OTHER INFORMATION IN THE CONTRACT DOCUMENTS FOR CONSISTENCY PRIOR TO CONSTRUCTION. ANY INCONSISTENCIES OR DISCREPANCIES THAT ARE FOUND BY THE CONTRACTOR OR HIS ASSIGNS SHALL BE IMMEDIATELY BROUGHT TO THE ATTENTION OF THE OWNER AND ENGINEER IN WRITING, IN THE FORMAT OF AN RFI PRIOR TO CONSTRUCTION.
- 5. ALL WORK SHALL BE PERFORMED IN ACCORDANCE WITH THE PROJECT DOCUMENTS, JURISDICTION STANDARDS AND SPECIFICATIONS, AND ALL OTHER APPLICABLE LOCAL AND STATE CODES AND ORDINANCES. THERE ARE ADDITIONAL NOTES, SPECIFICATIONS AND REQUIREMENTS CONTAINED THROUGHOUT THE PLAN SET AS WELL AS REFERENCES TO SPECIFICATIONS FROM APPLICABLE GOVERNING AUTHORITIES AND INDUSTRY STANDARDS. IT IS THE CONTRACTOR'S RESPONSIBILITY TO OBTAIN, REVIEW AND ADHERE TO ALL THESE DOCUMENTS.
- 6. STANDARD CONSTRUCTION ACTIVITIES SHALL BE LIMITED TO THE DAYS AND HOURS REGULATED BY THE JURISDICTION.
- 7. THE CONTRACTOR SHALL NOTIFY UNDERGROUND SERVICE ALERT AT (800) 642-2444 AND A PRIVATE UTILITY LOCATOR PRIOR TO THE START OF WORK TO VERIFY THE LOCATION OF EXISTING UNDERGROUND UTILITIES. THE UTILITIES SHOWN ON THESE PLANS ARE BASED UPON RECORD INFORMATION. HOWEVER, THE CIVIL DESIGN ENGINEER ASSUMES NO RESPONSIBILITY FOR THEIR SIZE, ACCURACY OR ACTUAL LOCATIONS.
- 8. THE CONTRACTOR SHALL RESTORE TO THEIR PREVIOUS CONDITION OR REPLACE STRUCTURES TO REMAIN WHICH ARE DAMAGED DUE TO THE CONTRACTOR'S WORK AT THEIR OWN EXPENSE.
- 9. THE CONTRACTOR SHALL ABIDE BY THE RULES AND REGULATIONS OF THE STATE OF CALIFORNIA CONSTRUCTION SAFETY ORDERS PERTAINING TO EXCAVATIONS AND TRENCHES. EXCAVATIONS SHALL BE ADEQUATELY SHORED, BRACED, AND SHEATHED SO THAT THE EARTH WILL NOT SLIDE OR SETTLE AND SO THAT THE EXISTING IMPROVEMENTS WILL BE FULLY PROTECTED FROM DAMAGE. DAMAGE RESULTING FROM A LACK OF ADEQUATE SHORING, BRACING, AND SHEATHING SHALL BE THE RESPONSIBILITY OF THE CONTRACTOR AND SHALL BE REPAIRED OR RECONSTRUCTED AT THE CONTRACTORS EXPENSE.
- 10. TRENCHES SHALL NOT BE LEFT OPEN OVERNIGHT. CONTRACTOR SHALL BACKFILL TRENCHES, OR PLACE STEEL PLATING OR HOT-MIX ASPHALT AS REQUIRED TO PROTECT OPEN TRENCHES AT THE END OF EACH WORK DAY.
- 11. UPON SATISFACTORY COMPLETION OF THE WORK, THE WORK SITE SHALL BE CLEANED UP AND LEFT WITH A SMOOTH AND NEATLY GRADED SURFACE FREE OF CONSTRUCTION DEBRIS OF ANY NATURE BY THE CONTRACTOR TO THE SATISFACTION OF THE OWNER.
- 12. THE CONTRACTOR SHALL POST ON SITE EMERGENCY TELEPHONE NUMBERS FOR JURISDICTION ENGINEER, AMBULANCE, POLICE, FIRE DEPARTMENTS, AND THOSE AGENCIES RESPONSIBLE FOR MAINTENANCE OF UTILITIES IN THE VICINITY OF THE JOB SITE.

DRAINAGE:

- 1. POLYVINYL CHLORIDE PIPE SHALL CONFORM WITH ASTM D 3034, SDR 35 OR EQUIVALENT.
- 2. ALL STORM AND FOUNDATION DRAINAGE PIPE SYSTEM SHALL BE PRIMED AND TESTED ACCORDING TO CALIFORNIA PLUMBING CODE.
- 3. UPON PROJECT COMPLETION, THE CLIENT SHALL BE SOLELY RESPONSIBLE TO ROUTINELY INSPECT AND MAINTAIN ALL ON-SITE STORM DRAIN FACILITIES. STORM DRAIN SYSTEM SHALL BE CLEANED AND/OR FLUSHED ON A BIANNUAL BASIS OR AS FOUND NECESSARY.
- 4. ALL SOLID STORM AND FOUNDATION DRAINAGE PIPES ARE 4 INCH WITH 2.0 PERCENT SLOPE OR BETTER. ALL PERFORATED PIPES ARE SPECIFIED IN DETAILS UNLESS STATES OTHERWISE IN THE PLAN.
- 5. SLOPE LANDSCAPE SURFACES AWAY FROM PERIMETER OF THE RESIDENCE AND OTHER STRUCTURES AT 5% FOR A DISTANCE OF 8 TO 10 FEET WHERE POSSIBLE.
- 6. ALL PIPE FITTINGS INCLUDING CONNECTORS SHALL COMPLY TO CALIFORNIA PLUMBING CODE.
- 7. GRATE FINISHES AND DESIGN TO BE APPROVED BY ARCHITECT.
- 8. PLANTER GRATES SHALL BE 4" ATRIUM GRATES
- 9. CONTRACTOR SHALL VERIFY EXISTING SEWER INVERT PRIOR TO CONSTRUCTION OF NEW BUILDING.
- 10. ALL CLEANOUTS ARE TWO WAY CLEANOUTS.

EXISTING SURFACE CONDITIONS:

- 1. EXISTING INFORMATION SHOWN ON THESE PLANS IS BASED ON SITE SURVEY AND RECORD DOCUMENTS.
- 2. ALL ELEVATIONS SHOWN REFER TO THE PROJECT TEMPORARY BENCHMARK.
- 3. EXISTING INFORMATION MAY VARY FROM THOSE SHOWN ON PLANS.
- 4. CONTRACTOR SHALL REVIEW PLANS AND CONDUCT FIELD INVESTIGATIONS TO VERIFY EXISTING CONDITIONS.
- 5. THIS SURVEY IS NOT BOUNDARY LINE SURVEYING, PROPERTY LINES SHOWN APPROXIMATELY.
- 6. ELEVATIONS ARE ACCURATE TO ± 1'-0"

GRADING:

- 1. THE CONTRACTOR SHALL EXERCISE EXTREME CARE TO CONFORM TO THE LINES, GRADES, SECTIONS, AND DIMENSIONS AS SET FORTH ON THE PLANS. GRADED AREAS SHALL CONFORM TO THE VERTICAL ELEVATIONS SHOWN WITHIN A TOLERANCE OF ONE-TENTH OF A FOOT. WHERE GRADED AREAS DO NOT CONFORM TO THESE TOLERANCES THE CONTRACTOR SHALL BE REQUIRED TO DO CORRECTIVE GRADING, AT THE CONTRACTORS EXPENSE.
- 2. ALL WORK SHALL CONFORM TO RECOMMENDATIONS SPECIFIED IN THE GEOTECHNICAL REPORT.
- 3. ALL GRADING SHALL CONFORM TO THE JURISDICTION ORDINANCE CODE REGULATIONS FOR EXCAVATING, GRADING, FILLING AND CLEARING ON LANDS.
- 4. THE CONTRACTOR OR ANY SUBCONTRACTOR SHALL NOTIFY UNDERGROUND SERVICE ALERT ONE CALL PROGRAM 48 HOURS IN ADVANCE OF PERFORMING EXCAVATION WORK BY CALLING THE TOLL-FREE NUMBER 800-227-2600. EXCAVATION IS DEFINED AS BEING 18 OR MORE INCHES IN DEPTH BELOW THE EXISTING GROUND.
- 5. ACTUAL GRADING SHALL BEGIN WITHIN 30 DAYS OF VEGETATION REMOVAL OR THE AREA SHALL BE PLANTED TO CONTROL EROSION. SURFACE PLANT GROWTH ONLY AND WHICH DOES NOT EXCEED 4 INCHES IN DEPTH.
- 6. EROSION CONTROL MEASURES SHALL BE IN PLACE AT THE END OF EACH WORKING DAY, BETWEEN OCTOBER 15 AND APRIL 15.
- 7. CONTRACTOR SHALL NOTIFY THE DIRECTOR OR PUBLIC WORKS AT LEAST 48 HOURS PRIOR TO THE FOLLOWING INSPECTIONS: INITIAL INSPECTION OF GRADE STAKING, ROUGH GRADING INSPECTION, STORM/SUB DRAINAGE INSPECTION, FINAL INSPECTION AND APPROVAL.
- 8. A COPY OF ALL COMPACTION TESTS AND FINAL GRADING REPORT SHALL BE SUBMITTED TO THE JURISDICTION PRIOR TO SCHEDULING ANY INSPECTIONS.
- 9. DRAINAGE WILL BE A MINIMUM OF 5% AWAY FROM THE HOUSE FOR A MINIMUM OF 10 FEET OR AS SHOWN ON PLAN.
- 10. POLYVINYL CHLORIDE PIPE SHALL CONFORM WITH ASTM D 3034, SDR 35 OR EQUIVALENT.
- 11. CONTRACTOR SHALL SUPPLY ALL EQUIPMENT, LABOR AND MATERIALS NECESSARY TO PERFORM THE WORK SHOWN ON THIS PLAN.
- 12. CONTRACTOR SHALL VERIFY ALL DIMENSIONS AND CONDITIONS ON THE JOB, AND SHALL NOTIFY THE ENGINEER OF ANY VARIATION FROM THE DIMENSIONS AND CONDITIONS SHOWN. WRITTEN DIMENSIONS SHALL TAKE PRECEDENCE OVER SCALED DIMENSIONS.
- 13. ANY DISCREPANCIES OR OMISSIONS FOUND IN THE CONTRACT DOCUMENTS SHALL BE REPORTED TO THE DESIGN ENGINEER IMMEDIATELY. THE DESIGN ENGINEER WILL CLARIFY DISCREPANCIES OR OMISSIONS, IN WRITING, WITHIN A REASONABLE TIME.
- 14. CONTRACTOR SHALL MINIMIZE THE VOLUME OF RECYCLABLE MATERIALS SENT TO AREA LANDFILLS.
- 15. THE EXPORTED SOILS FROM THIS SITE SHALL BE REMOVED AND DISPOSED OF IN A MANNER AND LOCATION ACCEPTABLE TO THE JURISDICTION FOLLOWING THE REQUIREMENTS OF ALL APPLICABLE COUNTY, STATE, AND FEDERAL LAWS OR ORDINANCES.
- 16. SOIL COMPACTION SHALL BE A MINIMUM OF 90% RELATIVE COMPACTION FOR HARDSCAPE SURFACES.

EXISTING CONDITIONS:

- 1. EXISTING INFORMATION SHOWN ON THESE PLANS IS BASED ON SITE SURVEY.
- 2. ALL ELEVATIONS SHOWN REFER TO THE PROJECT VERTICAL DATUM.

CONSTRUCTION SCHEDULE:

CONSTRUCTION BEGINS: JUNE 2024
CONSTRUCTION ENDS: JULY 2025

BENCHMARK:

IS A MAG NAIL SET IN THE PAVEMENT OF LARCHMONT DRIVE IN FRONT OF THE SITE HAVING AN ELEVATION OF 284.27

GEOTECHNICAL NOTE:

ALL WORK TO COMPLY WITH THE RECOMMENDATIONS IN THE GEOTECHNICAL INVESTIGATION PREPARED FOR THE PROJECT SITE.

THE GEOTECHNICAL REPORT, NAMED: GEOTECHNICAL STUDY CONTRERAS PROPERTY CORNER OF BIRCH, GEORGE STREET, DATED DECEMBER 6, 2019, BY SIGMA PRIME GEOSCIENCES, INC., SHALL BE RETAINED ON THE CONSTRUCTION SITE.

THE GEOTECHNICAL ENGINEER OF RECORD IS IGOR KLEYNER, WITH THE CONTACT NUMBER 415-602-2290 AND THE EMAIL ADDRESS IS TESR@EARTHLINK.NET. THE CONTRACTOR MUST SHALL NOTIFY THE GEOTECHNICAL ENGINEER OF RECORD AT LEAST 72 HOURS BEFORE CONSTRUCTION OF GEOTECHNICAL RELATED WORK. THE GEOTECHNICAL PART OF CONSTRUCTION WORK, INCLUDING BUT NOT LIMITED TO, ALL THE EARTHWORK AND FOUNDATION CONSTRUCTIONS, MUST SHALL BE APPROVED BY THE GEOTECHNICAL ENGINEER OF RECORD. THE GEOTECHNICAL ENGINEER OF RECORD SHALL FOLLOW CBC2019 FOR ALL CONSTRUCTION OBSERVATION REQUIREMENTS.

EXISTING UNDERGROUND UTILITIES:

- 1. THE CONTRACTOR IS SPECIFICALLY CAUTIONED THAT THE LOCATION AND/OR ELEVATION OF EXISTING UTILITIES AS SHOWN ON THESE PLANS IS BASED ON RECORDS OF THE VARIOUS UTILITY COMPANIES. THE INFORMATION IS NOT TO BE RELIED ON AS BEING EXACT OR COMPLETE. THE CONTRACTOR MUST CALL THE APPROPRIATE UTILITY COMPANY AT LEAST 72 HOURS PRIOR TO ANY EXCAVATION TO REQUEST EXACT FIELD LOCATION OF UTILITIES. IT SHALL BE THE RESPONSIBILITY OF THE CONTRACTOR TO RELOCATE ALL EXISTING UTILITIES WHICH CONFLICT WITH THE PROPOSED IMPROVEMENTS SHOWN ON THE PLANS IN A MANNER WHICH WILL NOT NEGATIVELY AFFECT ANY EXISTING USERS OF THESE UTILITIES.
- 2. THE CONTRACTOR SHALL LOCATE ALL EXISTING UTILITY, INCLUDING BUT NOT LIMITED TO: WATER, SEWER, GAS, ELECTRIC & TELECOMMUNICATIONS, LOCATIONS, INVERTS AND CONDITIONS PRIOR TO CONSTRUCTION. ANY CONDITIONS FOUND TO DIFFER FROM THOSE SHOWN ON THE PLANS AND REQUIRING MODIFICATIONS TO THE DESIGN SHALL BE IMMEDIATELY BROUGHT TO THE ATTENTION OF THE ENGINEER PRIOR TO CONSTRUCTION. DIFFERING UTILITY CONDITIONS THAT ARE ENCOUNTERED BY THE CONTRACTOR, THAT REQUIRE MODIFICATION OF DESIGN THAT ARE NOT BROUGHT TO THE ATTENTION OF THE ENGINEER PRIOR TO CONSTRUCTION SHALL BE THE RESPONSIBILITY OF THE CONTRACTOR TO CORRECT AT NO ADDITIONAL COST.
- 3. CONTRACTOR SHALL REFER TO ARCHITECTURAL PLANS AND SPECIFICATIONS FOR ACTUAL LOCATIONS OF ALL UTILITY ENTRANCES INCLUDING, BUT NOT LIMITED TO SANITARY SEWER, STORM SEWER, DOMESTIC WATER, FIRE WATER, IRRIGATION WATER, GAS SERVICE, ELECTRICAL SERVICE, AND TELECOMMUNICATIONS. CONTRACTOR SHALL COORDINATE INSTALLATION OF UTILITIES IN SUCH A MANNER AS TO AVOID CONFLICTS AND ASSURE PROPER DEPTHS AND LOCATIONS ARE ACHIEVED AS WELL AS COORDINATING WITH THE GOVERNING UTILITY COMPANIES FOR APPROVAL OF UTILITY LOCATIONS AND SCHEDULING OF CONNECTIONS TO THEIR FACILITIES.
- 4. THE LOCATION OF EXISTING ELECTRICAL MAINS ARE APPROXIMATE. THE CONTRACTOR MUST CONSULT WITH PG&E FOR ADDITIONAL INFORMATION. ALL PROPOSED ELECTRICAL WORK SHALL BE IN CONFORMANCE WITH APPLICABLE LOCAL AND STATE CODES AND ORDINANCES AND PG&E REQUIREMENTS. MINIMUM DEPTH OF COVER OVER ELECTRICAL, GAS AND TELECOMMUNICATIONS SHALL BE TWO FEET. CONTRACTOR SHALL COORDINATE WITH PG&E FOR NEW ELECTRIC SERVICE. CONTRACTOR SHALL COORDINATE WITH TELECOM PROVIDER FOR NEW TELECOM SERVICE.
- 5. THE CONTRACTOR SHALL COORDINATE THE INSTALLATION OF THE NEW WATER SERVICE.
- 6. THE CONTRACTOR SHALL COORDINATE FOR TELECOM SERVICES FOR NEW SERVICE.

PROJECT INFORMATION:

PROJECT NAME: 700 GEORGE STREET
PROJECT ADDRESS: 700 GEORGE STREET MONTARA, CA 94037
APN: 036-103-620
PURPOSE OF GRADING: NEW RESIDENTIAL DWELLING
ARCHITECT/APPLICANT: ALEX MARTYNOVSKIY 10100 COUNTRYSIDE WAY SACRAMENTO, CA 95827
CIVIL ENGINEER: MTR, INC. EMAIL: TESR@EARTHLINK.NET PHONE: 415.602.2290
STRUCTURAL ENGINEER: MTR, INC. EMAIL: TESR@EARTHLINK.NET PHONE: 415.602.2290
SURVEYOR: BGT LAND SURVEYING 871 WOODSIDE WAY SAN MATEO, CA 94401 EMAIL: BGTINFO@BGTSURVEYING.COM PHONE: 650.212.1030

SCOPE OF WORK:

THIS PROJECT INVOLVES CONSTRUCTION OF THE NEW RESIDENTIAL DWELLING ON SITE.

QUANTITIES:

LOT AREA:	6,250± SF
PRE-PROJECT IMPERVIOUS SURFACE	0 SF
POST-PROJECT IMPERVIOUS SURFACE	2,800 SF
AREA OF DISTURBANCE	6,250 SF
CUT	26 CY
FILL	81.5 CY

SHEET INDEX:

SHT NO.	DESCRIPTION
CO.1	GENERAL NOTES
C1.0	SITE PLAN
C1.1	GRADING PLAN
C1.2	DRAINAGE PLAN
C1.3	UTILITY PLAN
C2.0	DETAILS
C2.1	DETAILS
C2.2	SECTIONS
C2.3	DETAILS
C3.0	EROSION CONTROL PLAN
C3.1	EROSION CONTROL DETAILS
C3.2	BEST PRACTICE MANAGEMENT
C4.0	WATER SERVICE DETAILS
C4.1	WATER SERVICE DETAILS
C5.0	SEWER LATERAL DETAILS


LEGEND & ABBREVIATIONS:

	PROPERTY LINE
	EXISTING SPOT ELEVATION
	EXISTING BUILDING FOOTPRINT
	NEW BUILDING FOOTPRINT
	TREE
	(E) CONCRETE
	(E) LAWN
	PERMEABLE PAVERS
	(N) CONCRETE
	PERMEABLE PAVEMENT
	ASPHALTIC CONCRETE
	BIORETENTION PLANTER
	WALL
	STORM DRAIN LINE
	PERFORATED DRAIN LINE
(N)	NEW
(E)	EXISTING
SD	STORM DRAIN
FFE	FINISHED FLOOR ELEVATION
o	ROOF DOWNSPOUT
	SURFACE FLOW
	DIRECTION FLOW
DS	DOWNSPOUT
CO	CLEANOUT
AD	AREA DRAIN
INV	INVERT
OF	OVERFLOW
DG	DECOMPOSED GRANITE

LEGEND AND ABBREVIATIONS:

	PROPERTY LINE	(E)	EXISTING
	SOLID PIPE	TYP	TYPICAL
	PERF PIPE	VIF	VERIFY IN FIELD
	FOUNDATION PERF PIPE	SD	STORM DRAIN
	EASEMENT	AD	AREA DRAIN
	SWALE	RL	ROOF LEADER
	STORM DRAIN	PL	PROPERTY LINE
	WATER	FG	FINISH GRADE
	GAS	CO	CLEAN OUT
	SEWER	DS	DOWNSPOUTS
	TELECOM	TC	TOP OF CURB
	FOUNDATION DRAIN	FL	FLOW LINE
	FLOW DIRECTION		
	SURFACE FLOW		
	SLOPE		
	SPOT ELEVATION		
	CLEAN OUT		
	AREA DRAIN		
	DOWNSPOUTS		

SYMBOL	DESCRIPTION	DATE	APPROVED
		03-03-24	IK
		02-21-23	IK
B	NEW SITE PLAN		
A	FOR REVIEW		

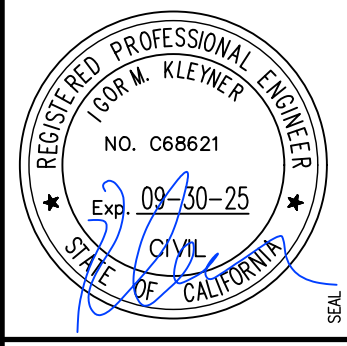


MODERN TECHNOLOGY RESOURCES INC.
415.602.2290

700 GEORGE ST @ BIRCH ST MONTARA, CA 94037 APN: 036-103-620


GENERAL NOTES

DATE	FEBRUARY 2023
SCALE	AS SHOWN
DESIGN	IK
DRAWN	IK
PROJECT#	23001
SHEET	1 of 15

C0.1

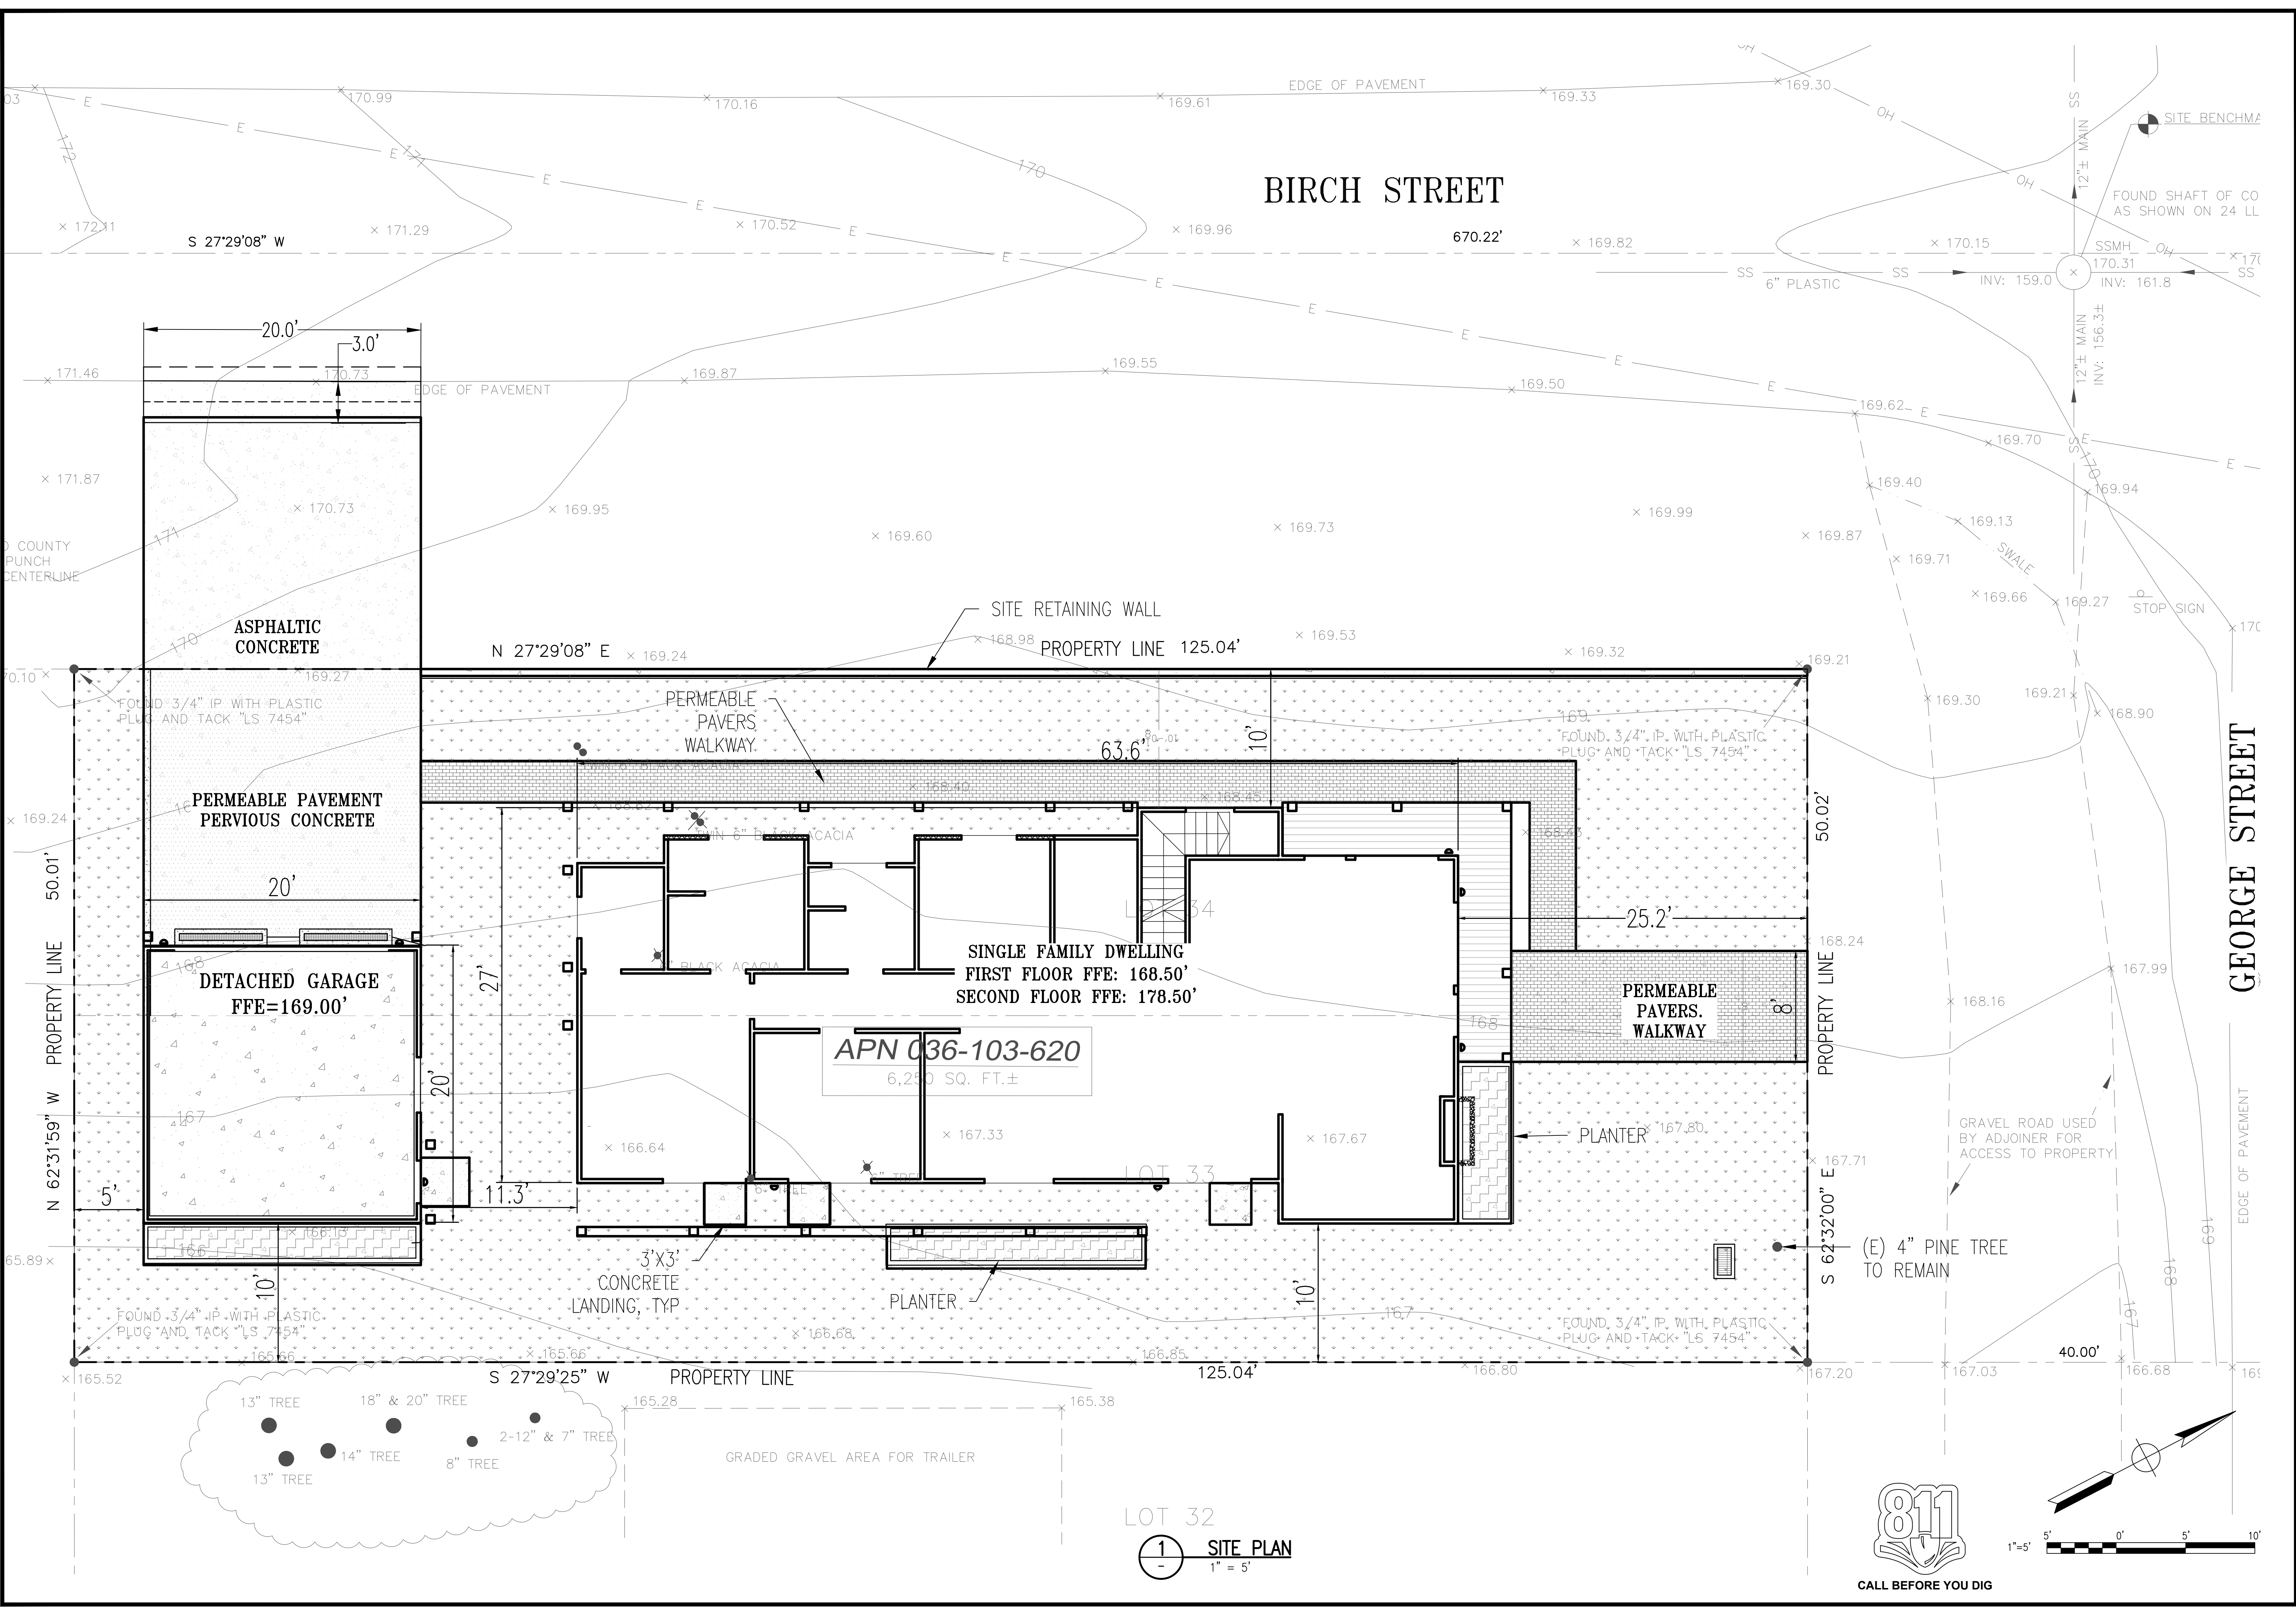

SYMBOL	DESCRIPTION	DATE	APPROVED
B	NEW SITE PLAN	03-03-24	IK
A	FOR REVIEW	02-21-23	IK

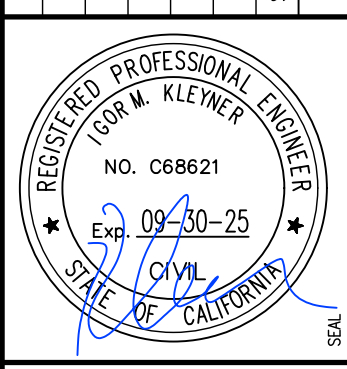


**MODERN TECHNOLOGY
RESOURCES INC.**
415.602.2290

**700 GEORGE ST @ BIRCH ST
MONTARA, CA 94037
APN: 036-103-620**


SITE PLAN

DATE	FEBRUARY 2023
SCALE	AS SHOWN
DESIGN	IK
DRAWN	IK
PROJECT	23001
SHEET	2 OF 15

C1.0

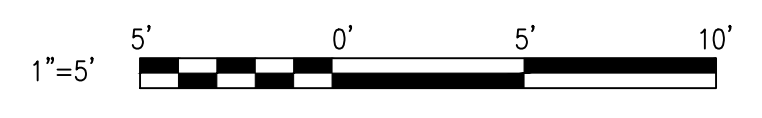

LOT 32
1 SITE PLAN
1" = 5'

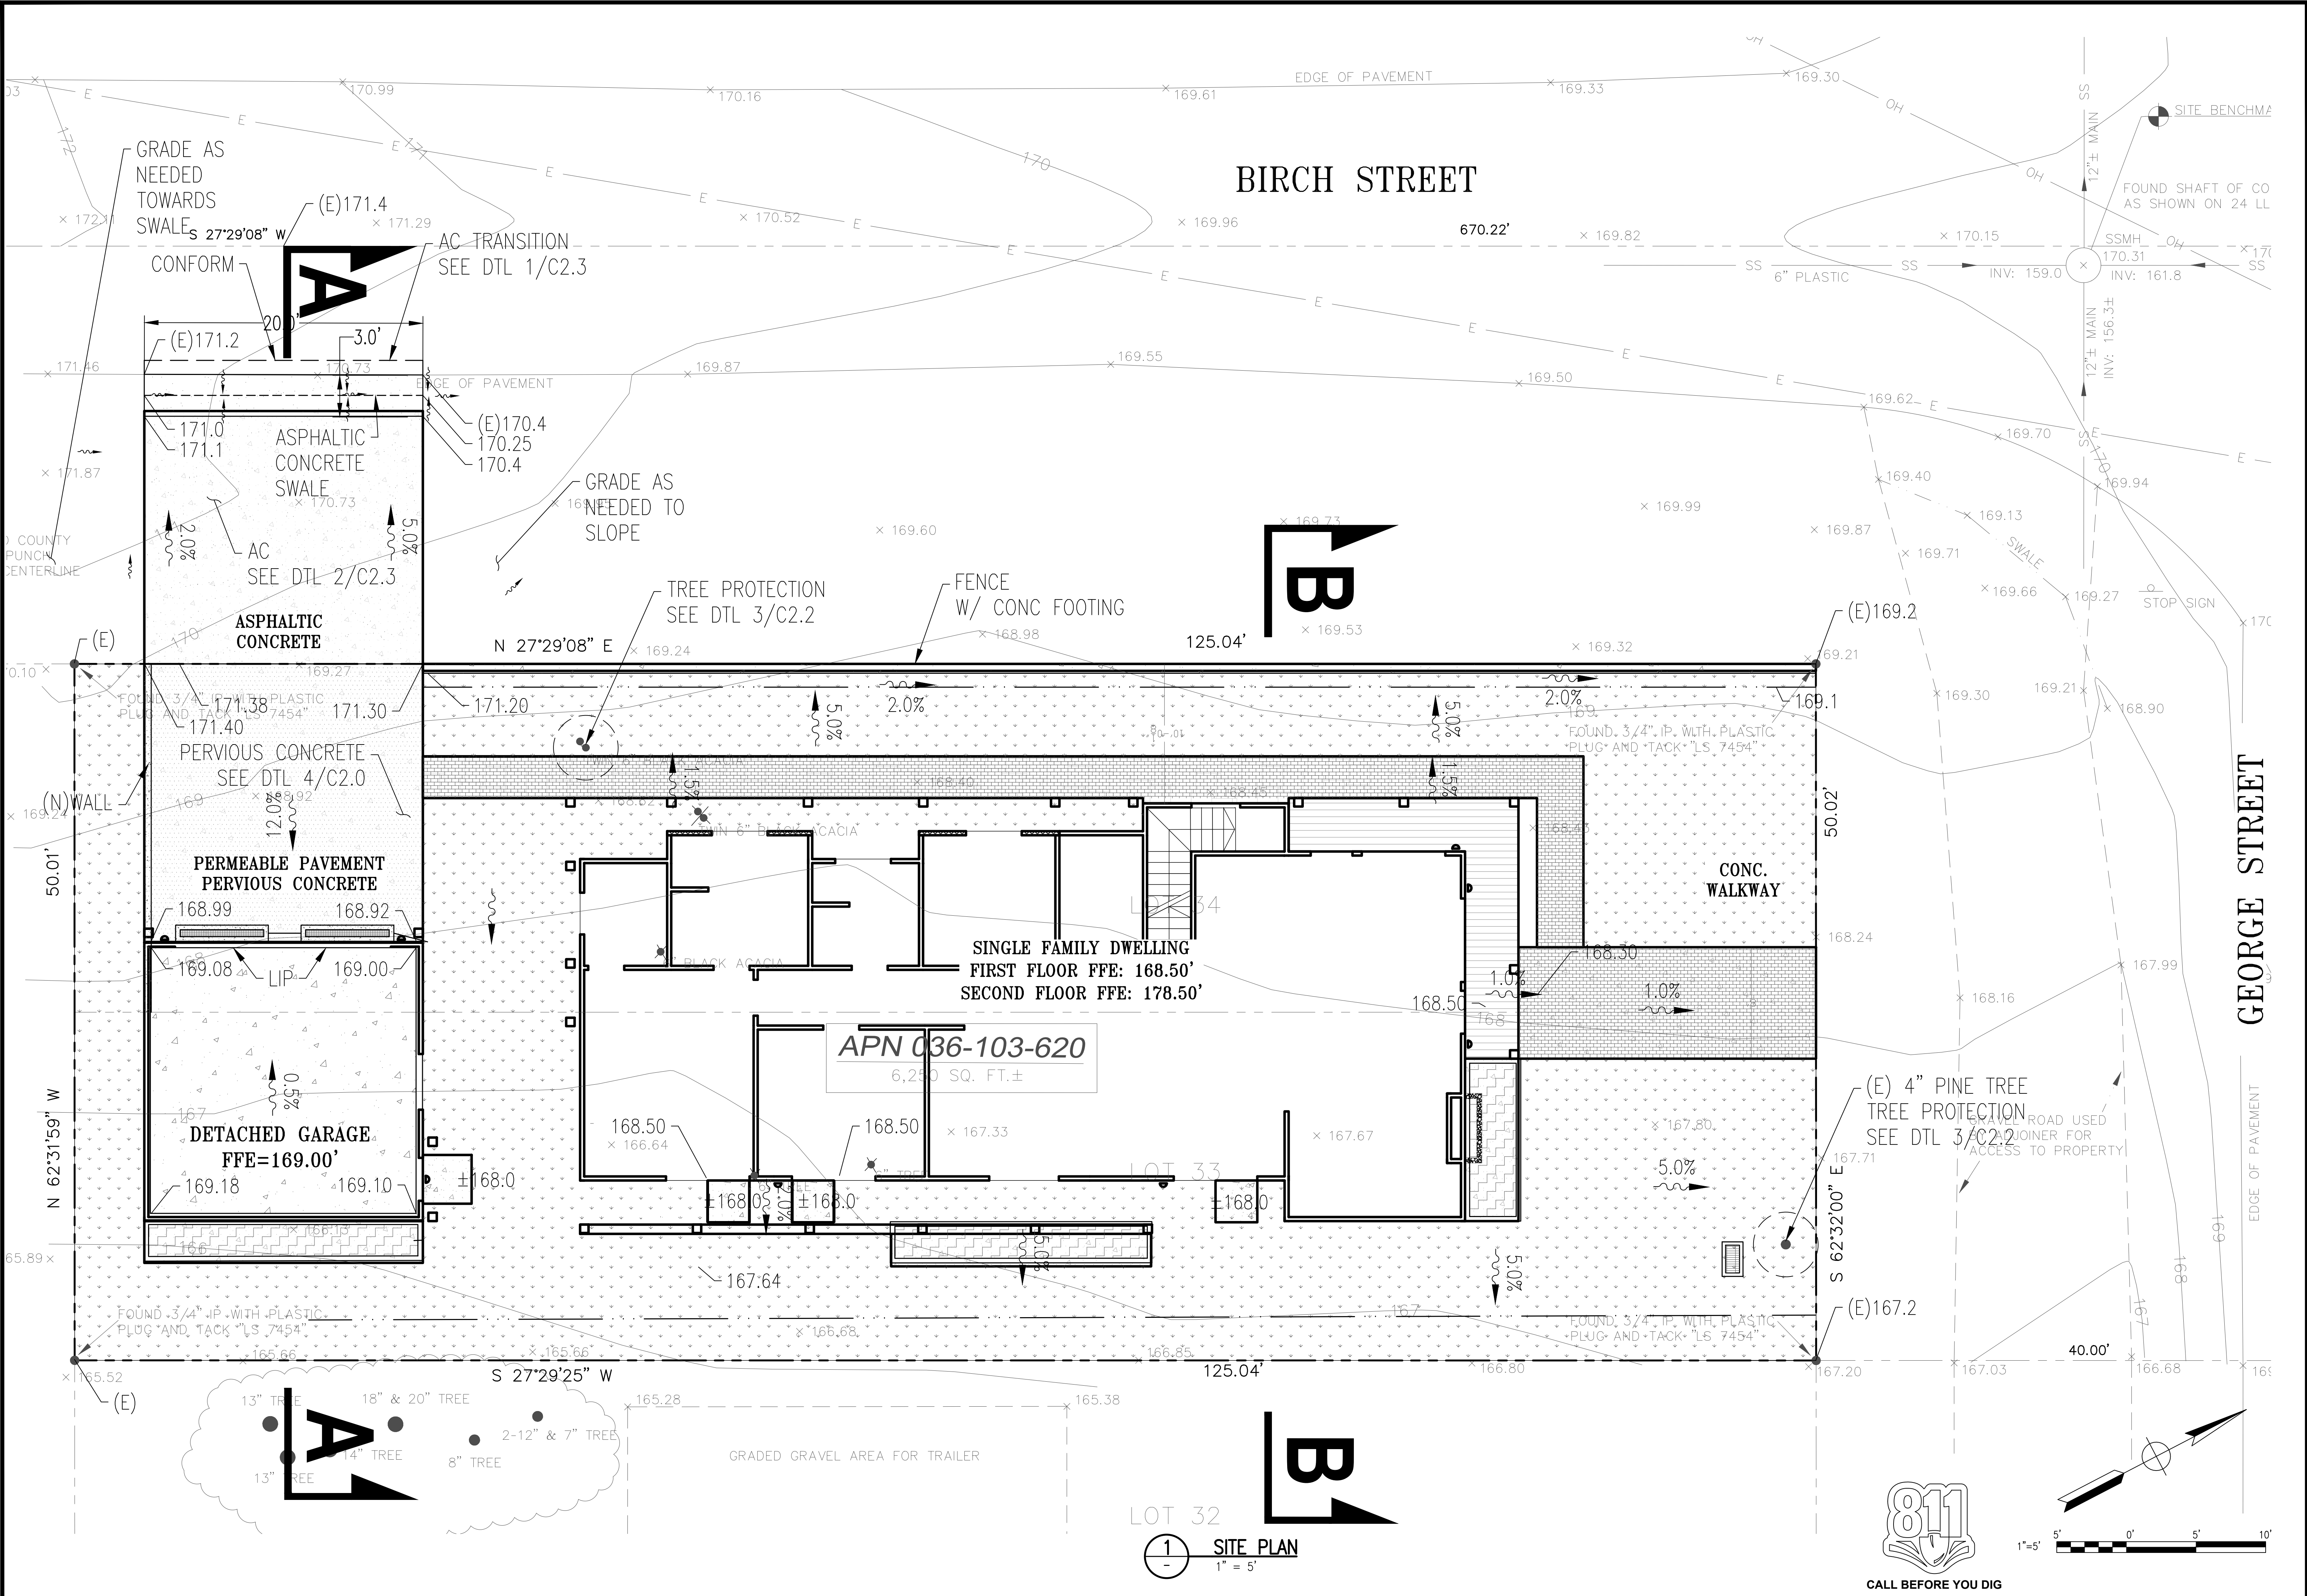

SYMBOL	DESCRIPTION	DATE	APPROVED
B	NEW SITE PLAN	03-03-24	IK
A	FOR REVIEW	02-21-23	IK



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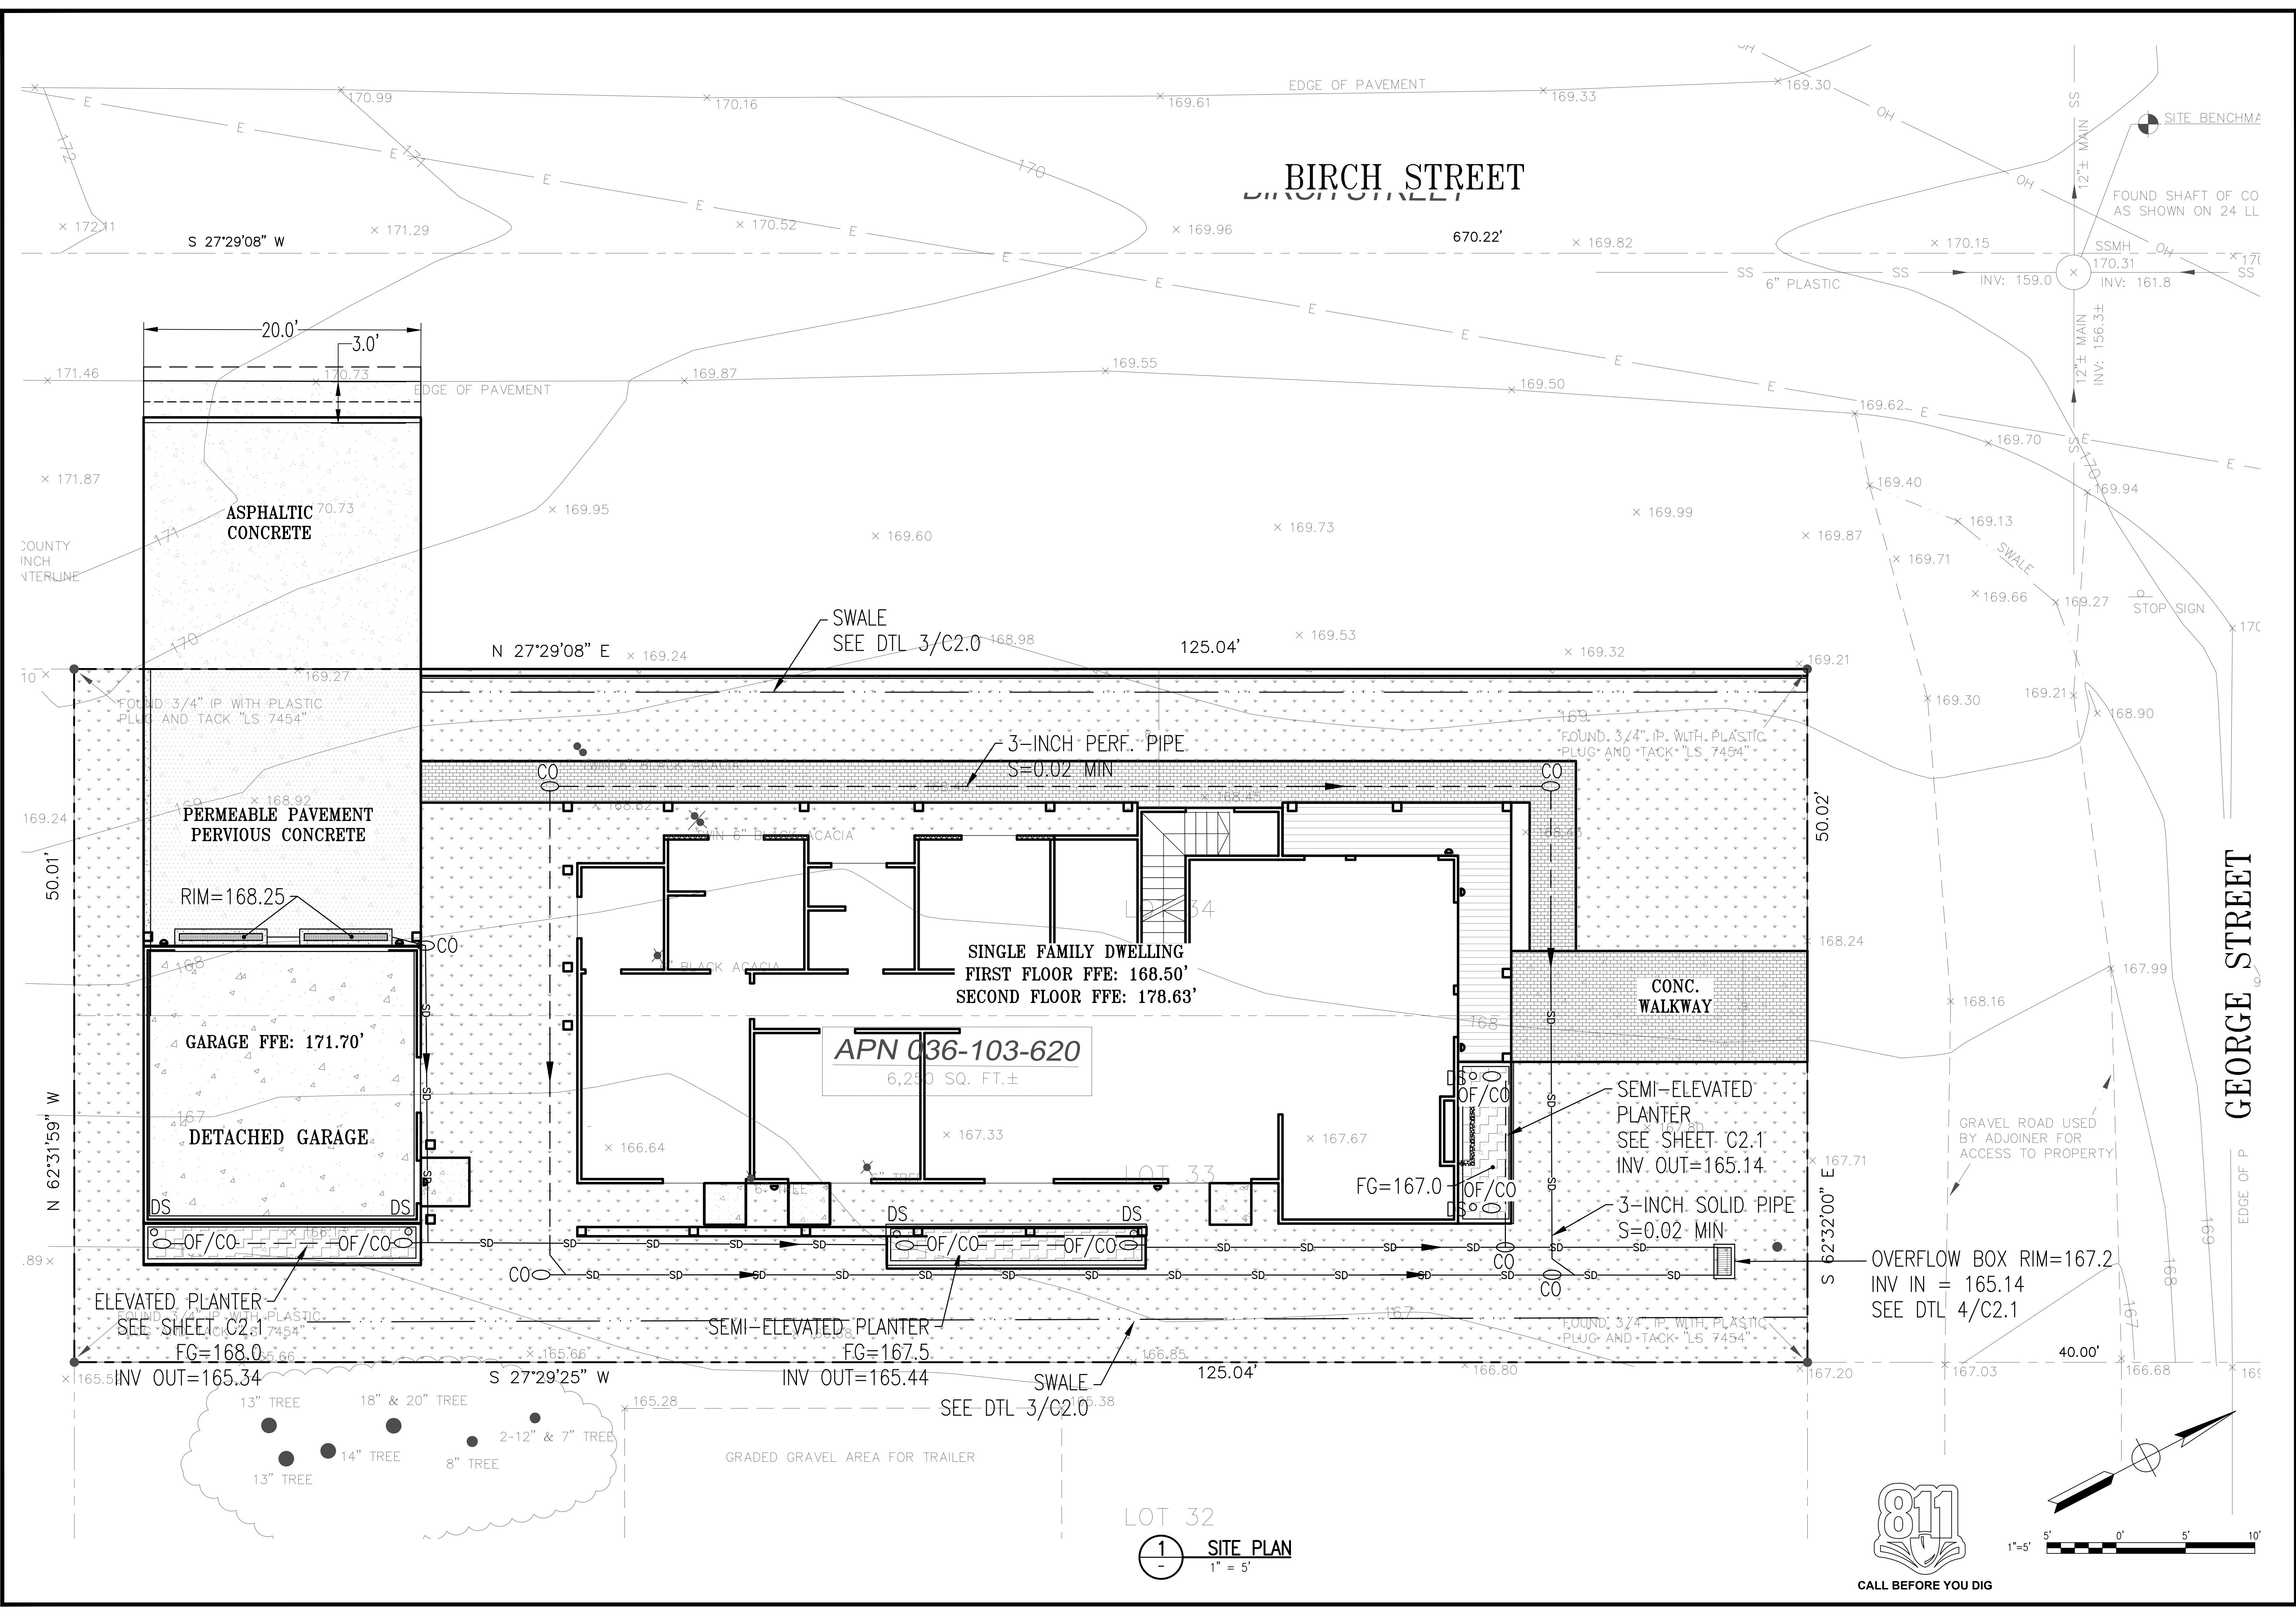
**700 GEORGE ST @ BIRCH ST
MONTARA, CA 94037
APN: 036-103-620**

GRADING PLAN


DATE	FEBRUARY 2023
SCALE	AS SHOWN
DESIGN	IK
DRAWN	IK
PROJECT	23001
SHEET	3 OF 15

C1.1





SYMBOL	DESCRIPTION	DATE	APPROVED
B	NEW SITE PLAN	03-03-24	IK
A	FOR REVIEW	02-21-23	IK

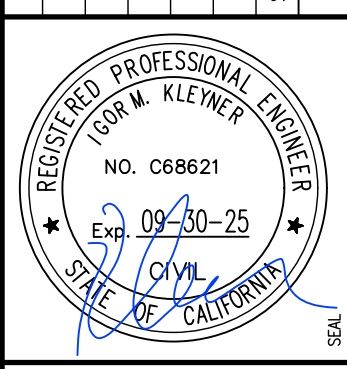

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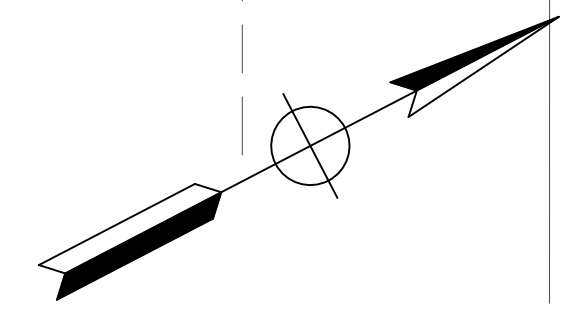
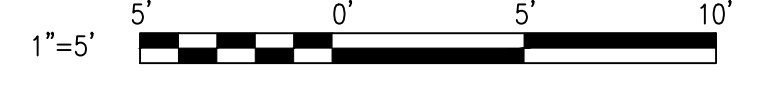
700 GEORGE ST @ BIRCH ST
MONTARA, CA 94037
APN: 036-103-620


DRAINAGE PLAN

DATE	FEBRUARY 2023
SCALE	AS SHOWN
DESIGN	IK
DRAWN	IK
PROJECT	23001
SHEET	4 OF 15


C1.2

LOT 32
1 SITE PLAN
1" = 5'



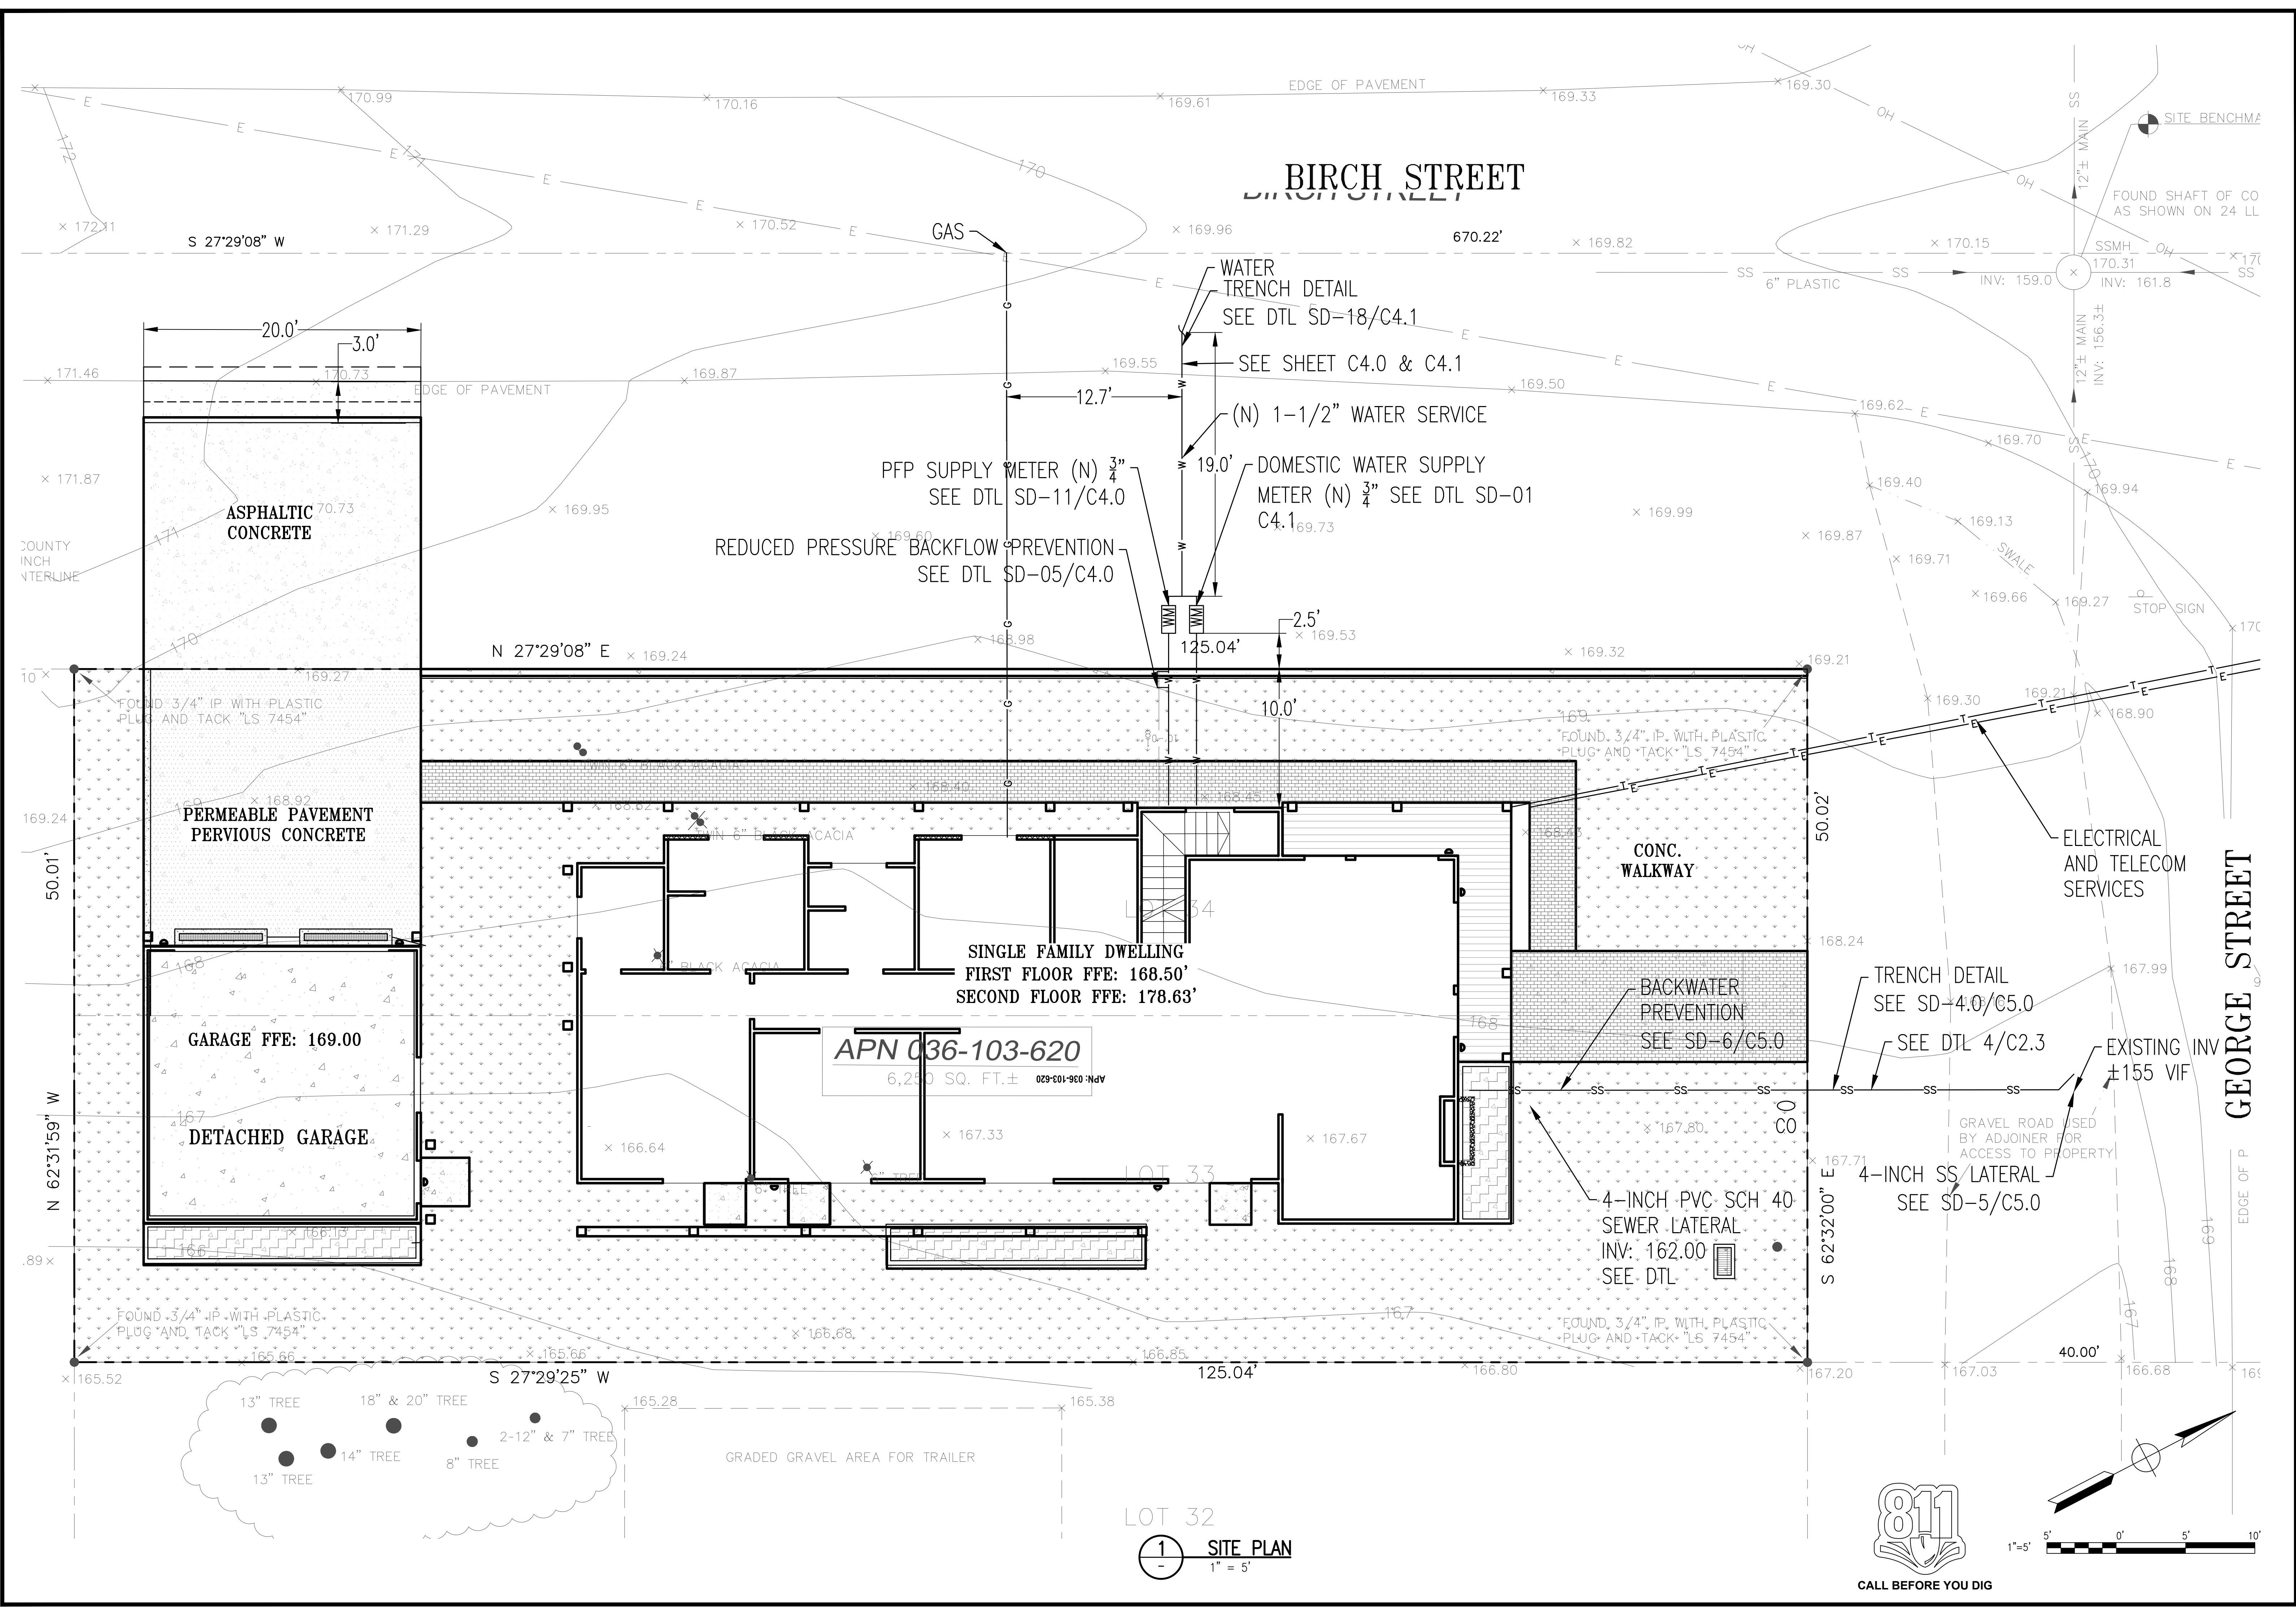

SYMBOL	DESCRIPTION	DATE	APPROVED
B	NEW SITE PLAN	03-03-24	IK
A	FOR REVIEW	02-21-23	IK

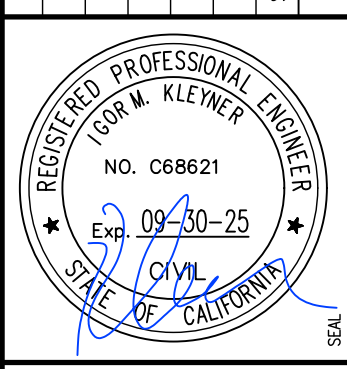


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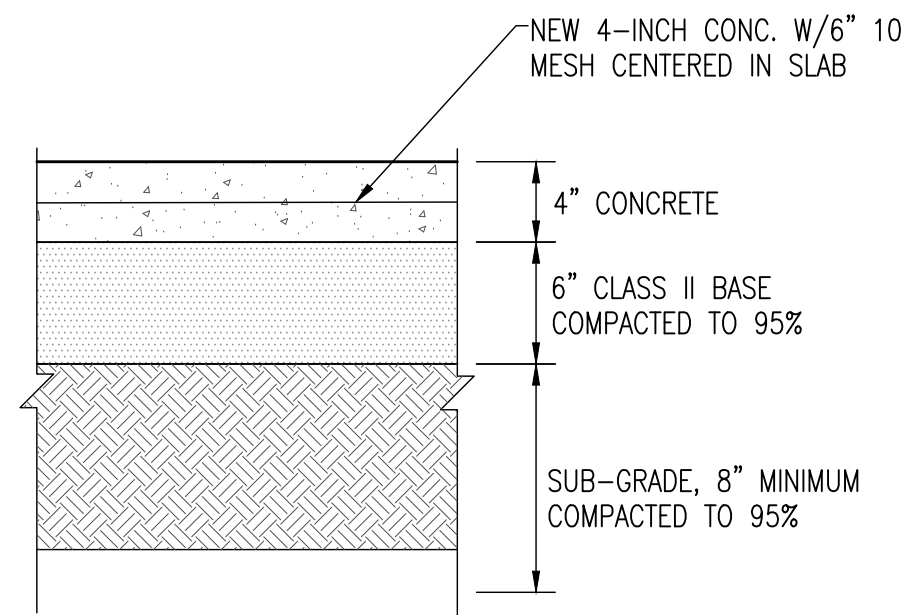
UTILITY PLAN

DATE	FEBRUARY 2023
SCALE	AS SHOWN
DESIGN	IK
DRAWN	IK
PROJECT	23001
SHEET	5 OF 15

C1.3




LOT 32
1 SITE PLAN
1" = 5'

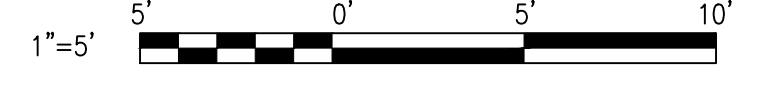


NOTES:
1. PAVEMENT RESTORATION MUST EQUAL EXISTING SECTION

1 CONCRETE WALKWAY SECTION
NO SCALE

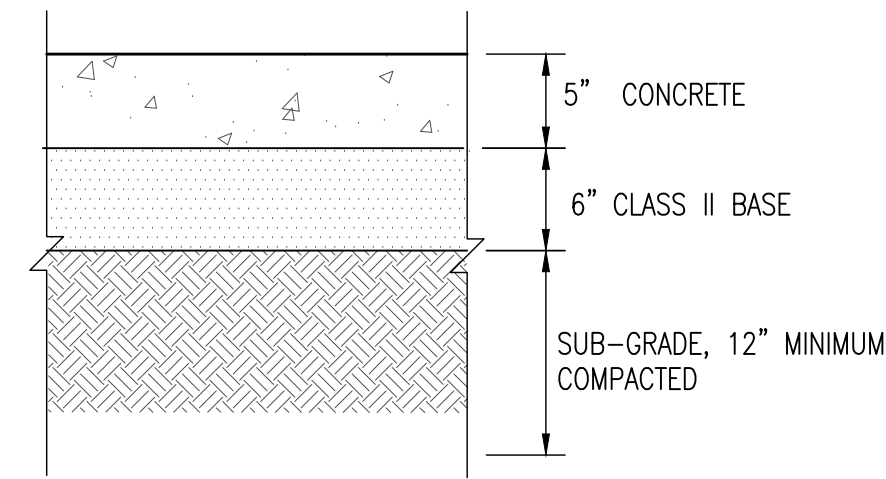


NOTES:
1. 8 FEET MAX CONSTRUCTION JOINT
2. #4 REBAR 12" O.C.
3. BROOM FINISH
4. SEE ARCH DRAWINGS FOR COLOR



2 GARAGE SECTION
NO SCALE

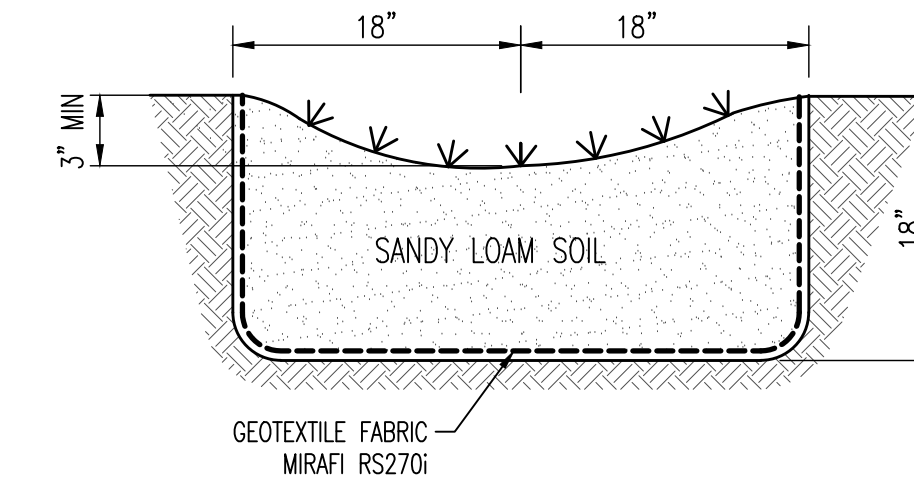


3 SWALE DETAIL
NO SCALE

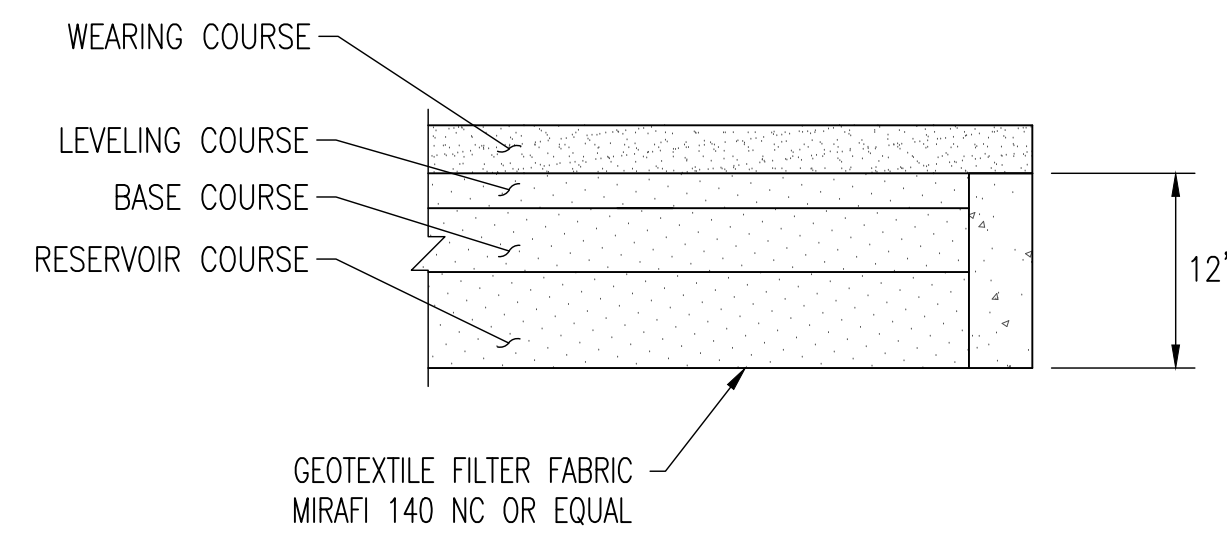


4 PERMEABLE SURFACE SECTION
NO SCALE

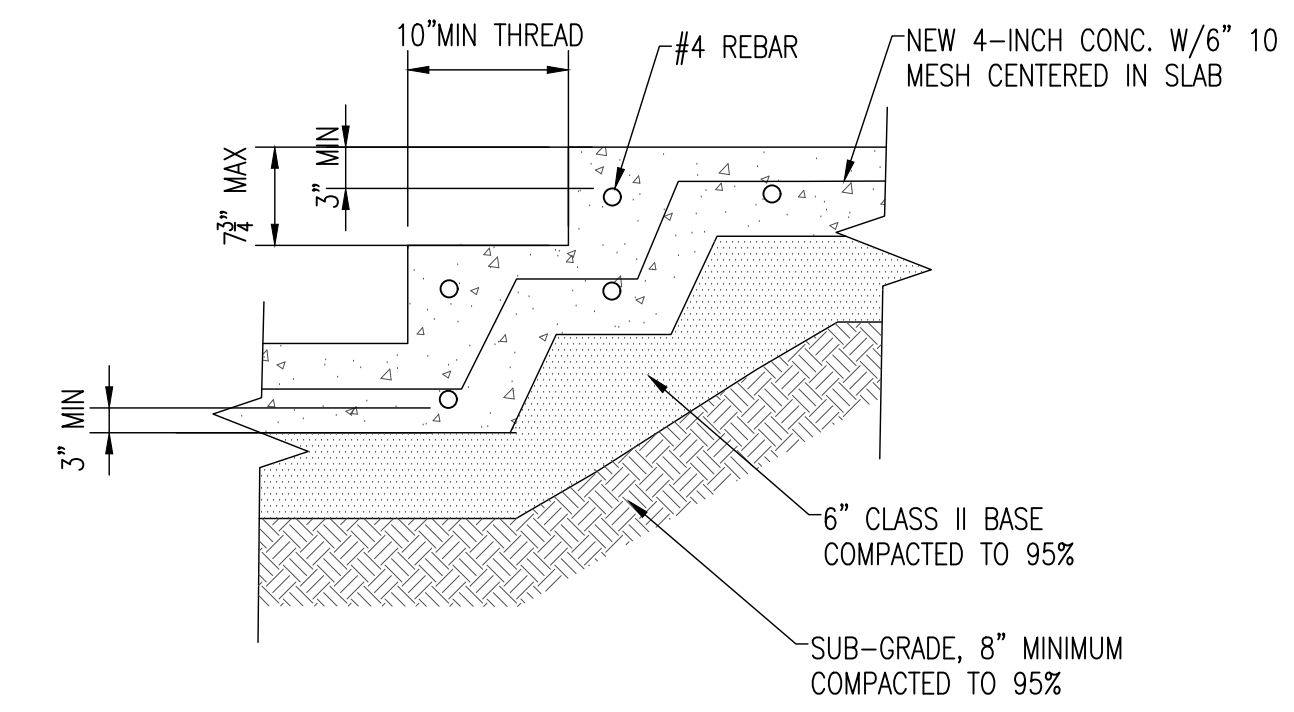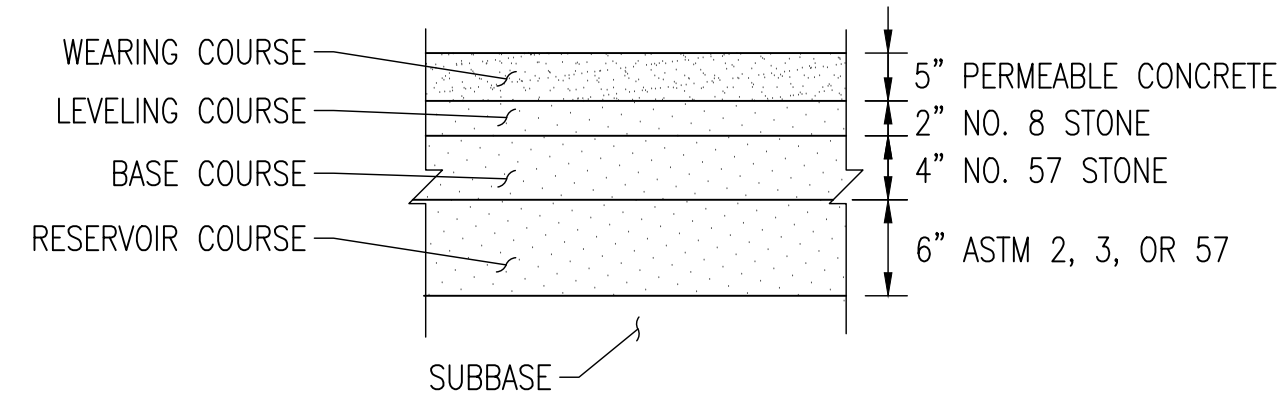


5 CONCRETE STAIR SECTION
NO SCALE

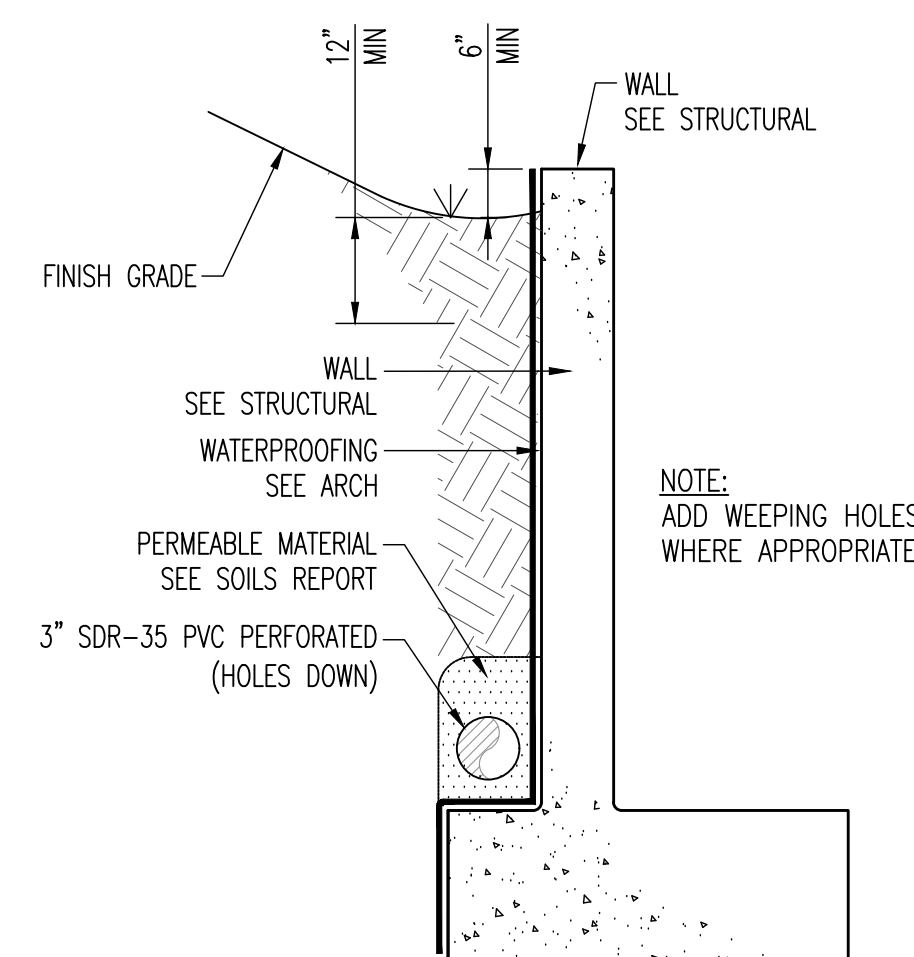

6 WALL DRAIN SECTION
NO SCALE

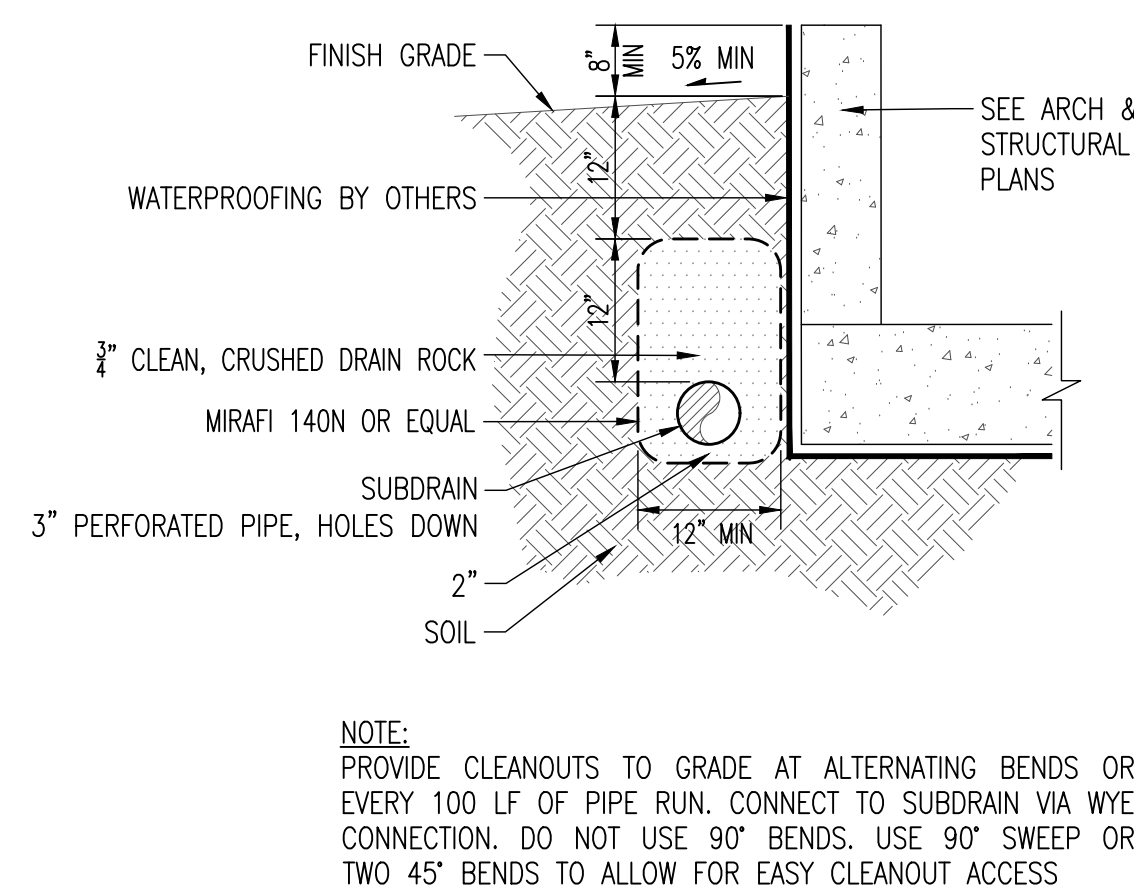

7 FOUNDATION DRAIN
NO SCALE

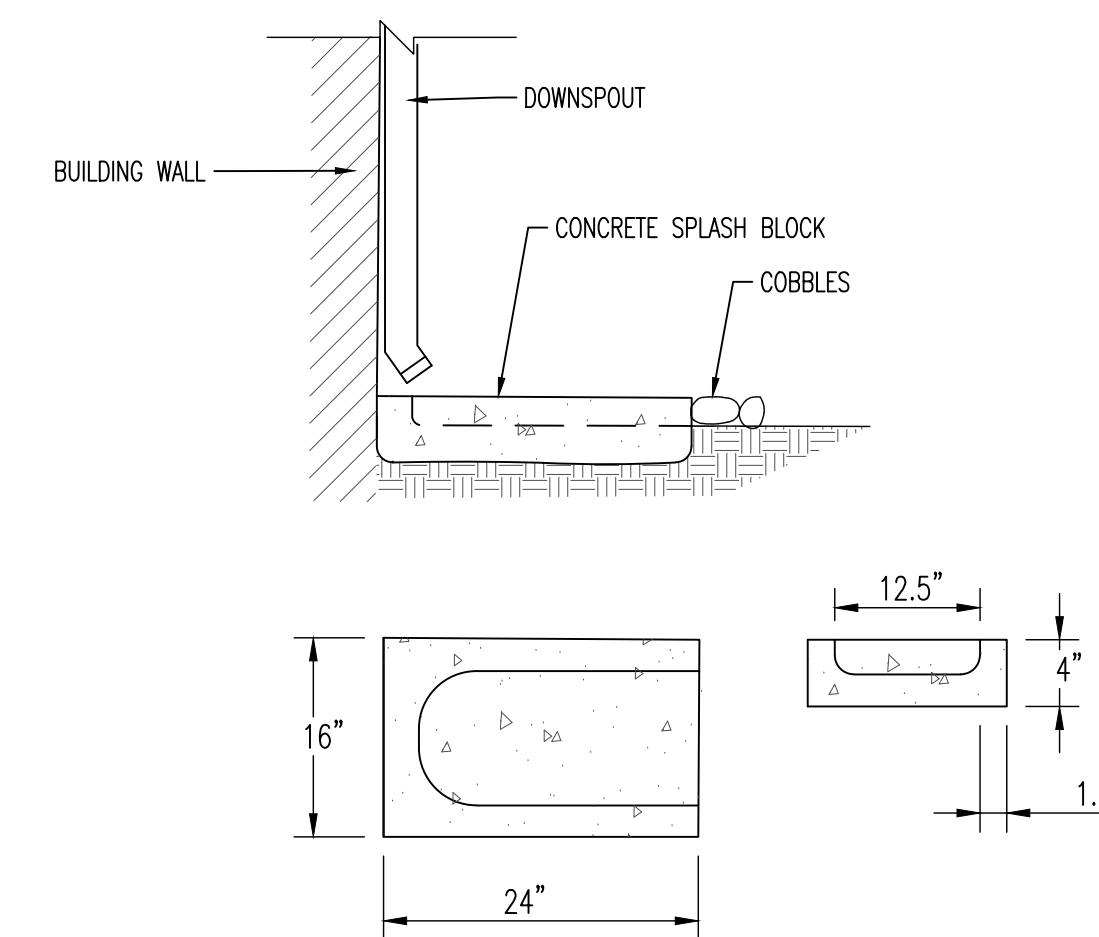

3 SPLASH BLOCK
NO SCALE

SYMBOL	DESCRIPTION	DATE	APPROVED
B	NEW SITE PLAN	03-03-24	IK
A	FOR REVIEW	02-21-23	IK




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DETAILS

DATE	FEBRUARY 2023
SCALE	AS SHOWN
DESIGN	IK
DRAWN	IK
PROJECT	23001
SHEET	6 OF 15


C2.0




CONSTRUCTION NOTES:

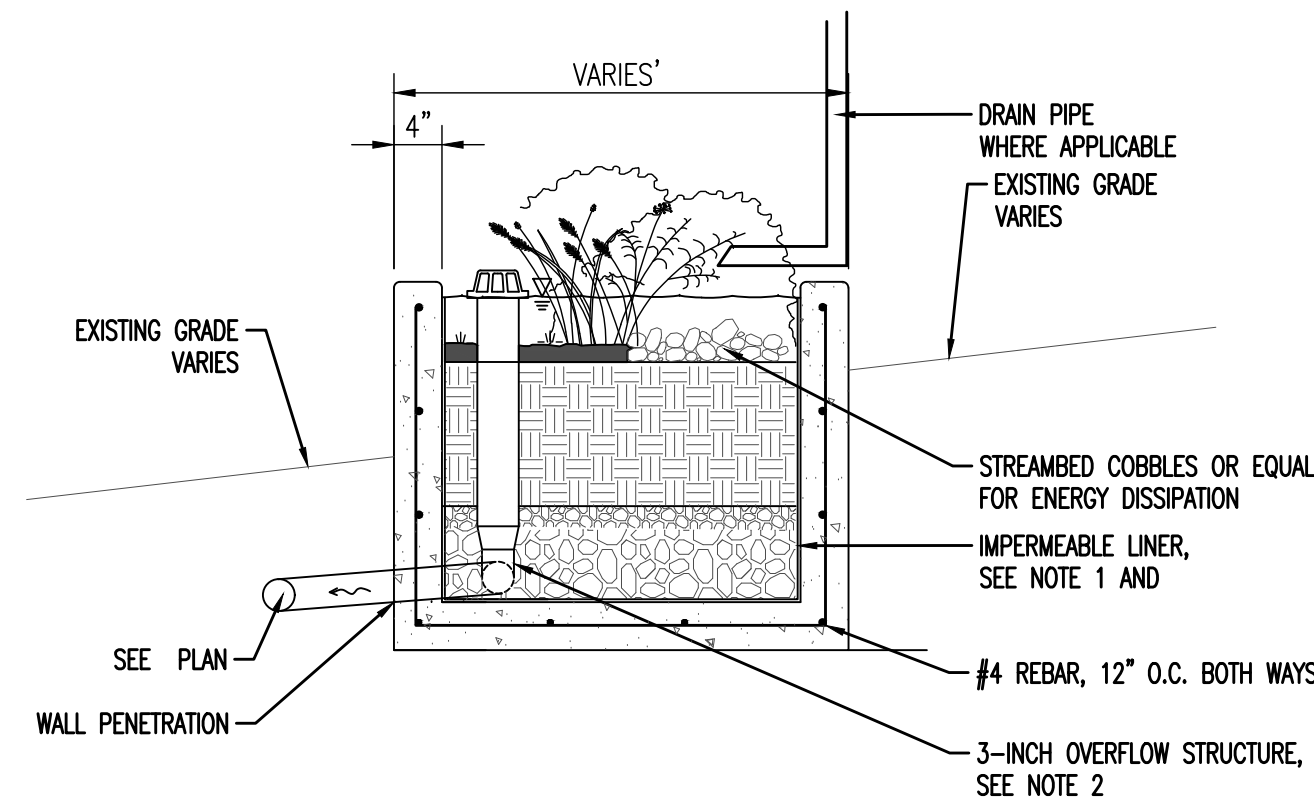1. INTEGRATE WATERPROOFING WITH WALL SYSTEMS INCLUDING WATERPROOF PIPE PENETRATIONS, JOINTS, AND LINER CONNECTIONS.
2. OVERFLOW STRUCTURE (MATERIAL AND WORKMANSHIP) SHALL CONFORM TO APPLICABLE CALIFORNIA BUILDING CODES AND REQUIREMENTS.
3. SEE DETAIL FOR ADDITIONAL DIMENSIONS AND DETAILS.

1 FLOW THROUGH PLANTER
NO SCALE


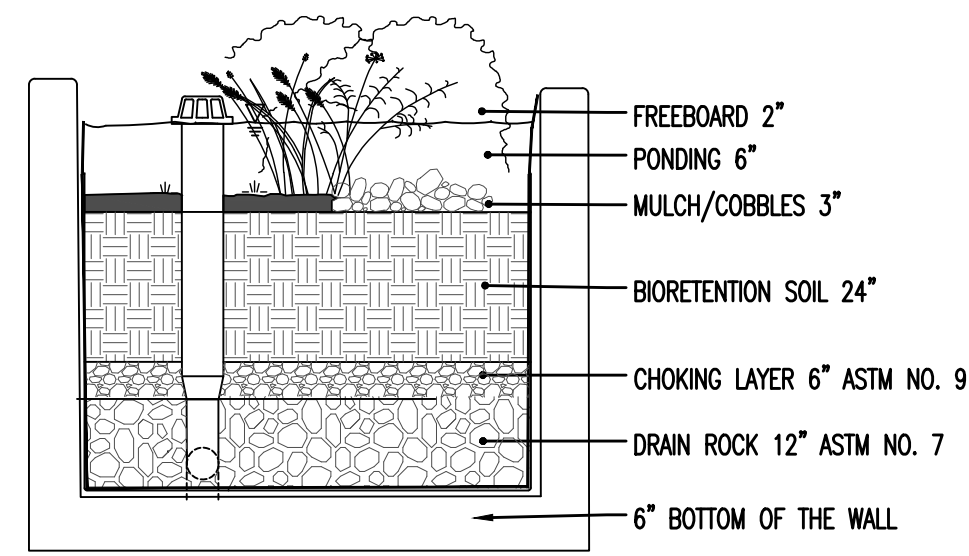


2 INLET DETAIL
NO SCALE

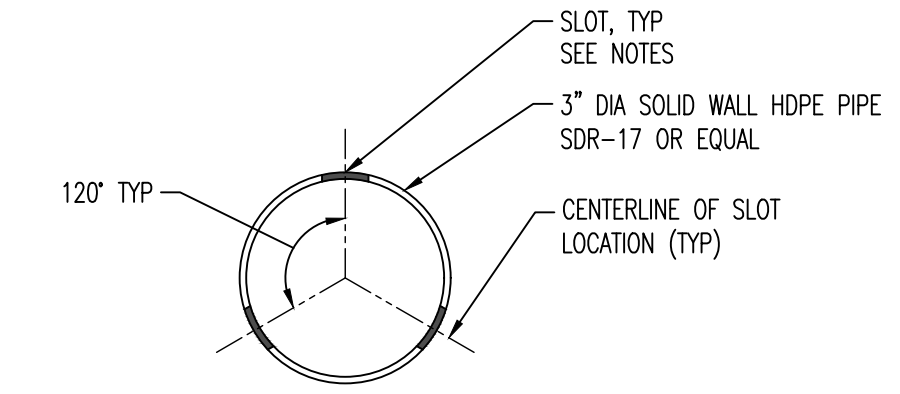


- NOTES:**
1. UNDERDRAIN PIPE SHALL BE SLOTTED HDPE SDR-17, SINGLE WALL AND DUAL WALL CORRUGATED HDPE PIPE AASHTO M252 AND M294 TYPES C, S, AND D ARE NOT ACCEPTABLE.
 2. ALL PERFORATIONS SHALL BE SLOTTED TYPE, MEASURING 0.032 INCH WIDE (MAX), SPACED AT 0.25 INCH (MIN), AND PROVIDING A MINIMUM INLET AREA OF 5.0 SQUARE INCH PER LINEAR FOOT OF PIPE.
 3. PERFORATIONS SHALL BE ORIENTED PERPENDICULAR TO LONG AXIS OF PIPE, AND EVENLY SPACED AROUND CIRCUMFERENCE AND LENGTH OF PIPE.
 4. SET CROWN OF UNDERDRAIN PIPE AT OR BELOW BOTTOM OF CHOKING COURSE.
 5. LONGITUDINAL SLOPE OF UNDERDRAIN PIPE SHALL BE FLAT.

3 SLOTTED UNDERDRAIN PIPE
NO SCALE

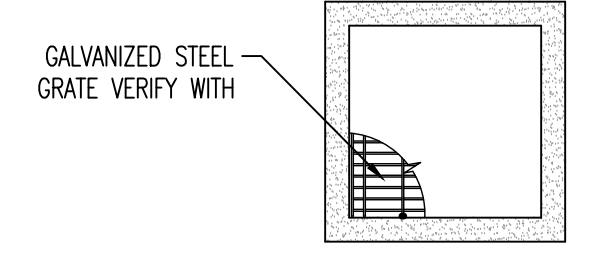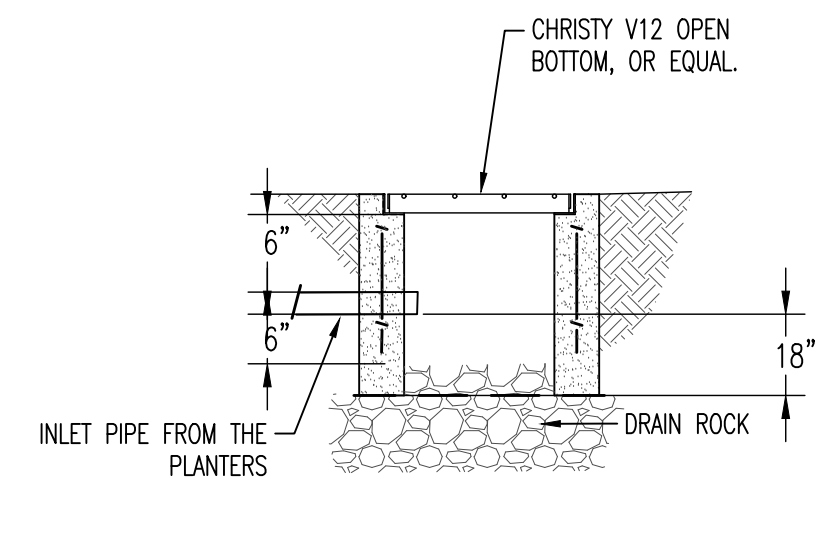


4 BUBBLER BOX DETAIL
NO SCALE

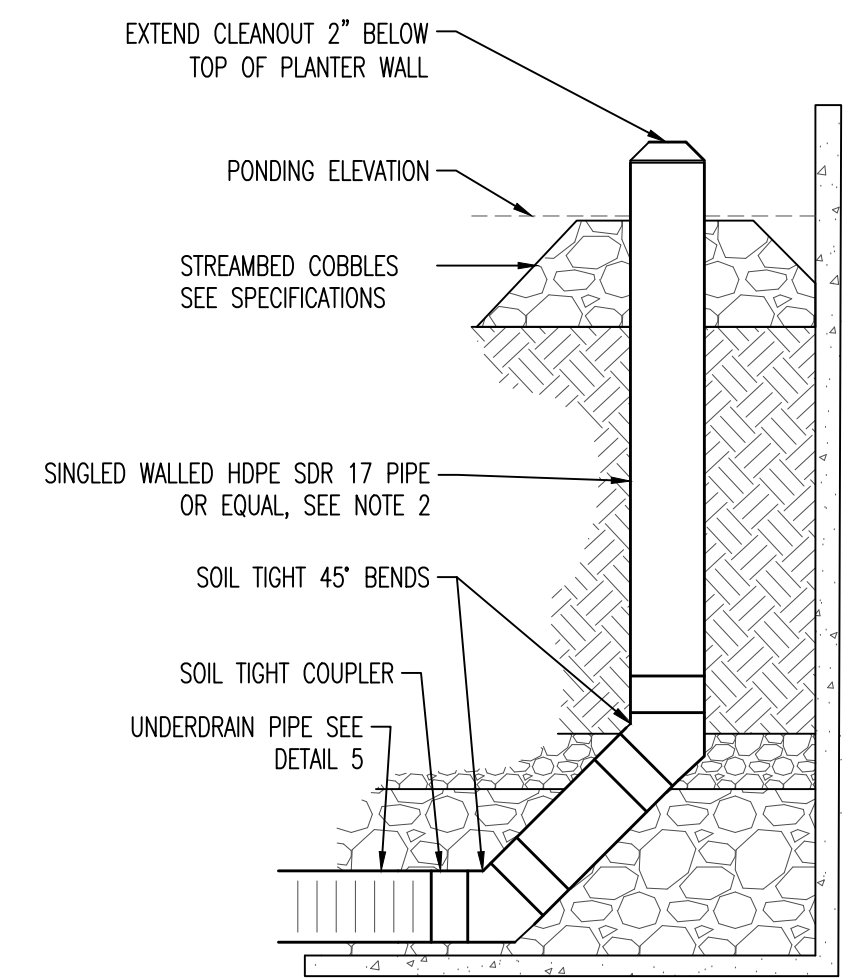


- NOTES:**
1. ALL MATERIAL AND WORKMANSHIP FOR CLEANOUTS SHALL CONFORM TO CALIFORNIA PLUMBING STANDARD SPECIFICATION AND APPLICABLE CODES PER SAN MATEO COUNTY.
 2. CLEANOUT PIPE AND FITTINGS SHALL BE SAME SIZE AND MATERIAL AS SLOTTED UNDERDRAIN PIPE.
 3. COVER SHALL HAVE A TAMPER RESISTANT LOCKING MECHANISM COVER SHALL INCLUDE CASTING OF "CO" OR EQUAL.
 4. CLEANOUT SHALL BE INSTALLED TO ALLOW FOR MAINTENANCE ACCESS TO ALL PIPES.
 5. ALL FITTINGS SHALL BE SOIL TIGHT.

5 CLEANOUT IN PLANTER
NO SCALE

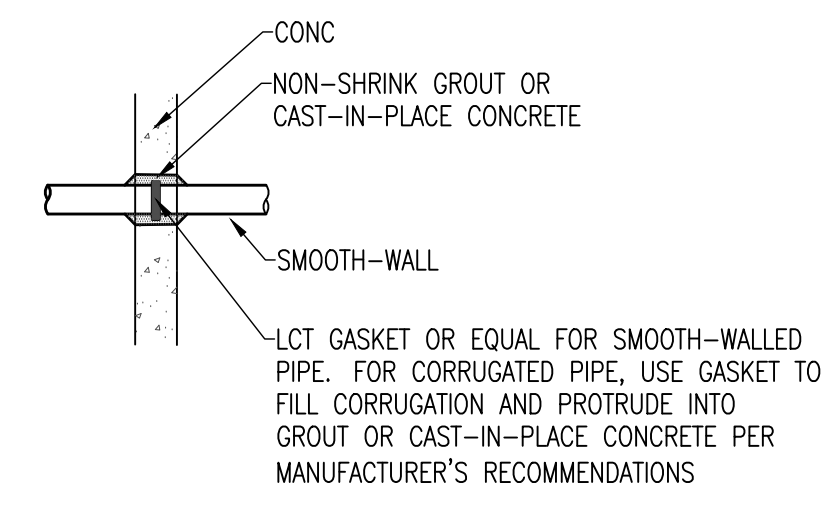


- NOTES:**
1. CUT OPENING IN LINER FOR PIPE TO WITHIN 1/2 inch OF PIPE OUTSIDE DIAMETER.
 2. FILL ANNULAR SPACE WITH 1 inch MINIMUM GRANULAR BENTONITE FILLET AS SHOWN.
 3. APPLY BUTYL MASTIC CAULK AND NEOPRENE RUBBER PAD CONTINUOUSLY AROUND PIPE.
 4. PROVIDE CONTINUOUS EXTRUSION WELD AT PIPE BOOT/LINER INTERFACE.
 5. FORM BOOT WITH SUFFICIENT MATERIAL TO PREVENT OVERSTRESSING DURING BACKFILLING, BUT WITHOUT FOLDS OR WRINKLES.
 6. CONSTRUCT BOOT FROM SAME MATERIAL AS THE LINER.
 7. ANGLE SHOULD NOT BE LESS THAN 30 degrees. IF ANGLE LESS THAN 30 degrees ADD SOIL AROUND THE PIPE TO INCREASE THE ANGLE AND PREVENT STRESSING AND CRACKING.
 8. SEAL CLAMP AND END OF BOOT WITH HEAT SHRINK WRAP. EXTEND HEAT SHRINK WRAP ONE PIPE DIAMETER (MINIMUM) BEYOND CLAMP.
 9. CONTRACTOR MAY USE PREFABRICATED PIPE BOOTS IN LIEU OF FIELD-FABRICATED BOOTS. CONNECT PREFABRICATED BOOT TO LINER AND PIPE PER MANUFACTURER'S RECOMMENDATIONS.

6 WALL TIGHT PENETRATION
NO SCALE

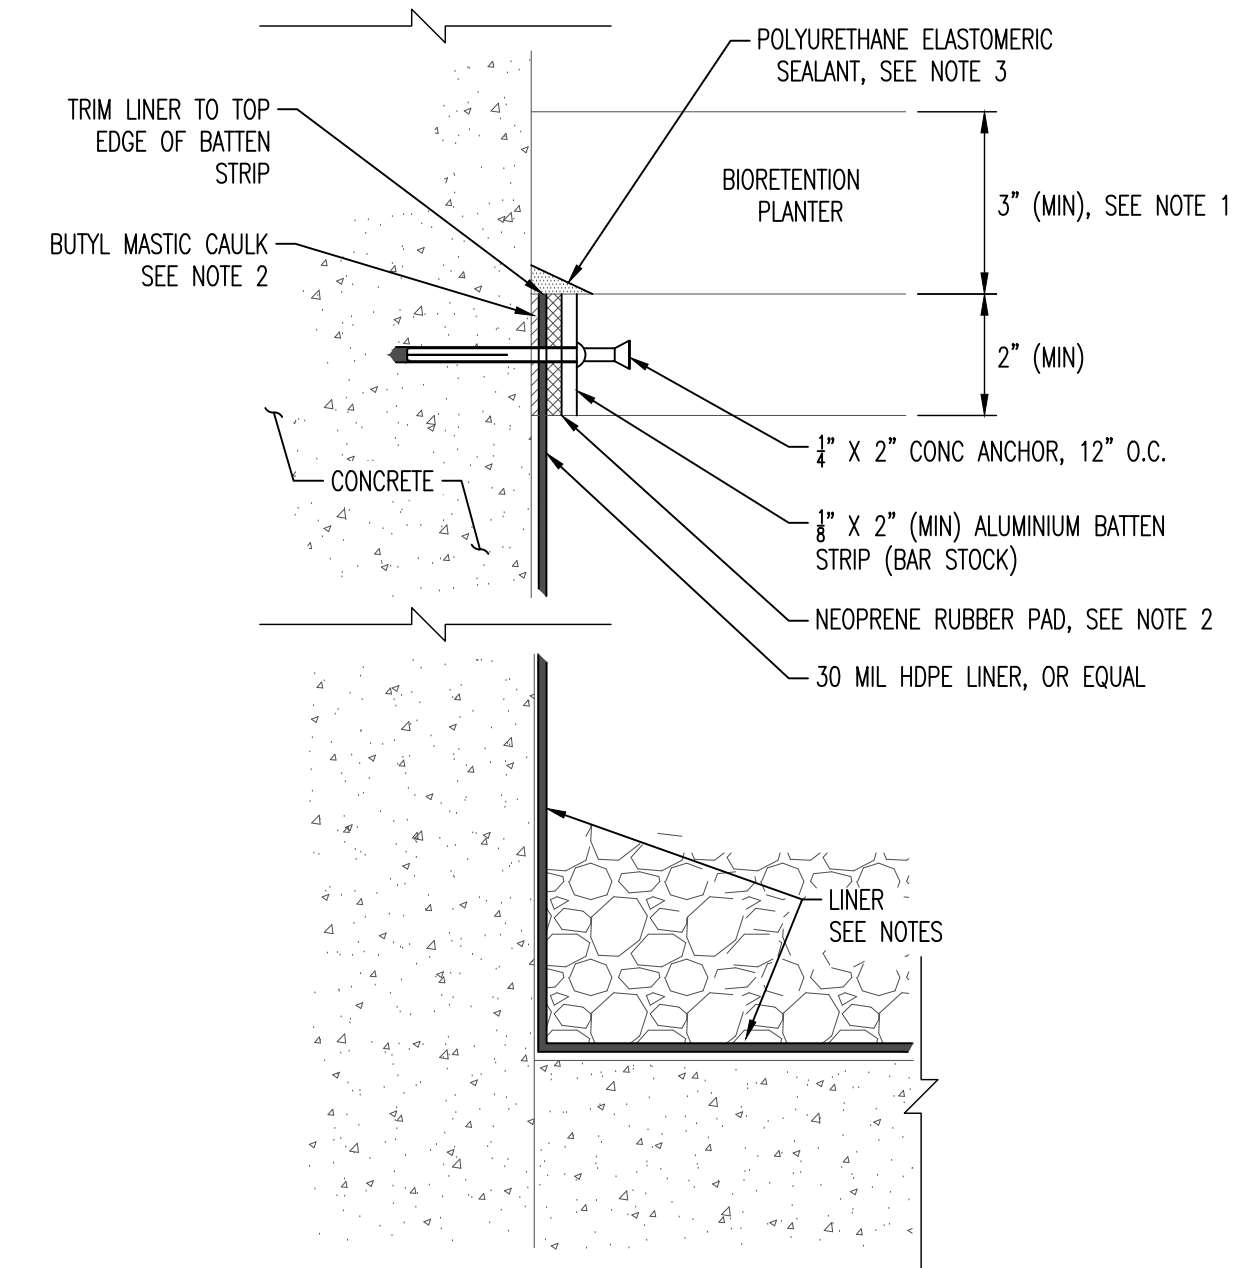

- NOTES:**
1. LINER SHALL BE HDPE CONFORMING TO GEOSYNTHETIC RESEARCH INSTITUTE (GRI) GM13 OR LLDPE CONFORMING TO GRI GM17.
 2. LINER SHALL LAY FLUSH WITH SURFACE WITH NO AIR VOIDS BELOW THE LINER PRIOR TO BACKFILLING MATERIAL ABOVE LINER.
 3. OVERLAP LINER PER MANUFACTURER'S RECOMMENDATIONS.
 4. ALL SEAMS SHALL BE WELDED PER MANUFACTURER'S RECOMMENDATIONS UNLESS OTHERWISE SPECIFIED.
 5. SECURE LINER CONTINUOUSLY WITH DOUBLE-SIDED TAPE ALONG LINER EDGE AND SINGLE SIDED TAPE ALONG TOP EDGE OF LINER TO HOLD LINER IN PLACE DURING BACKFILLING.
 6. TOP OF LINER LINER OR EQUAL WATERPROOFING SHALL EXTEND TO TOP OF FREEBOARD ELEVATION (2 inch TOP OF PLANTER).
 7. APPLY BUTYL MASTIC CAULK, BATTEN STRIP, AND NEOPRENE RUBBER PAD CONTINUOUSLY ALONG TOP EDGE OF LINER.
 8. APPLY BEAD OF POLYURETHANE ELASTOMERIC SEALANT CONTINUOUSLY ALONG TOP EDGE OF BATTEN STRIP ASSEMBLY.


7 WATERTIGHT LINER ATTACHMENT
NO SCALE

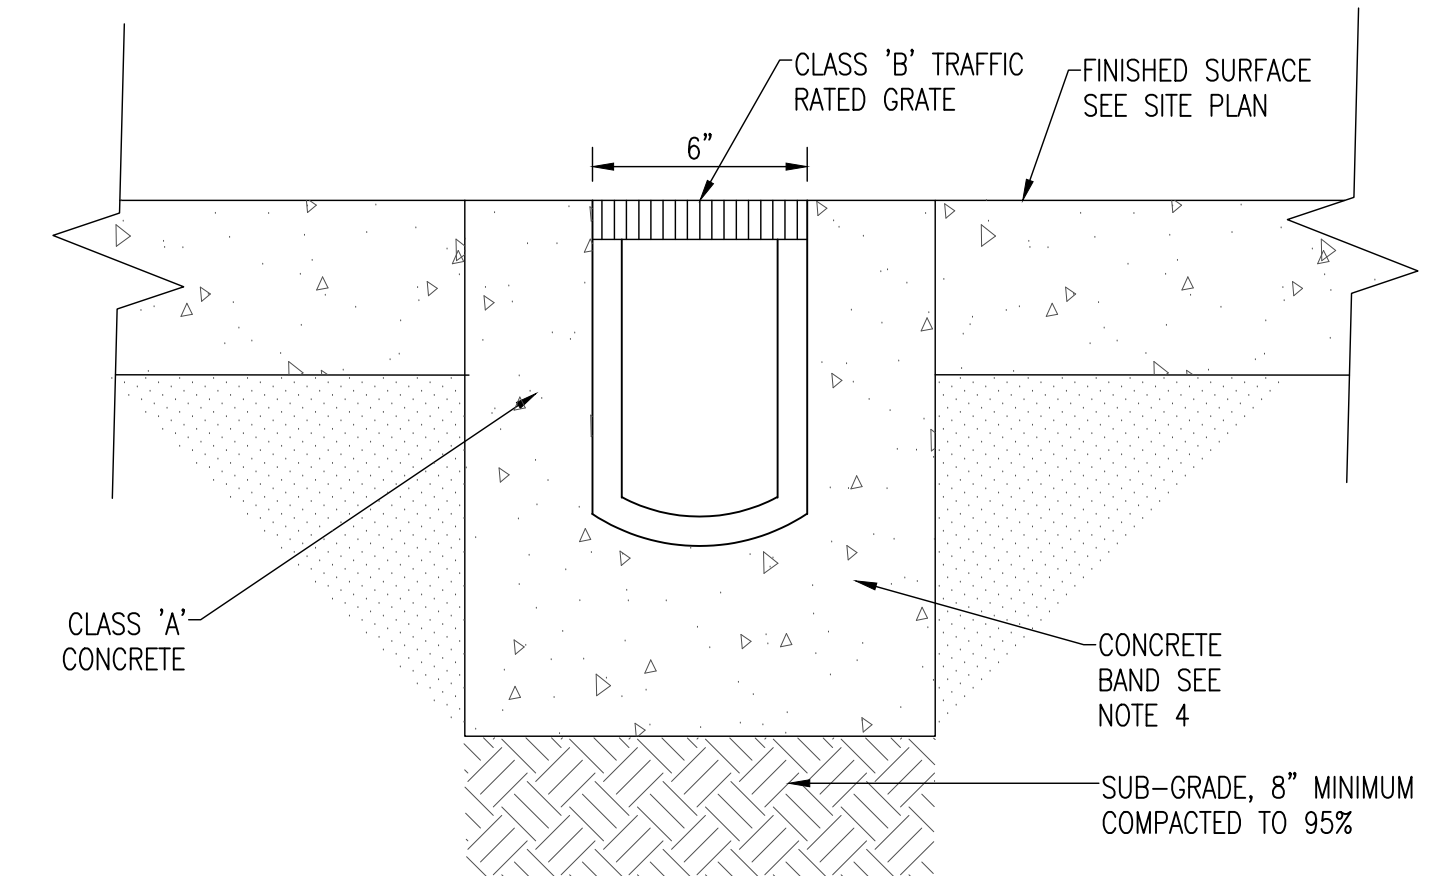

- NOTES:**
1. PRE-SLOPED TRENCH DRAIN. CONTRACTOR MAY USE POLYCAST 600 SERIES OR ZURN890 OR ACO DRAINLINE 150.
 2. MIN INVERT DEPTH 4-INCH.
 3. INSTALL PER MANUFACTURER'S INSTRUCTIONS.
 4. 4-INCH SIDE, 6-INCH BOTTOM

8 TRENCH SECTION
NO SCALE

SYMBOL	DESCRIPTION	DATE	APPROVED
B	NEW SITE PLAN	03-03-24	IK
A	FOR REVIEW	02-21-23	IK

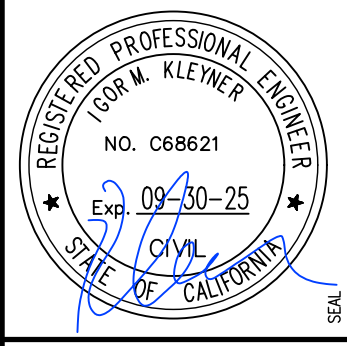


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415.602.2290

**700 GEORGE ST @ BIRCH ST
MONTARA, CA 94037
APN: 036-103-620**

DETAILS

DATE	FEBRUARY 2023
SCALE	AS SHOWN
DESIGN	IK
DRAWN	IK
PROJECT	23001
SHEET	7 OF 15


C2.1

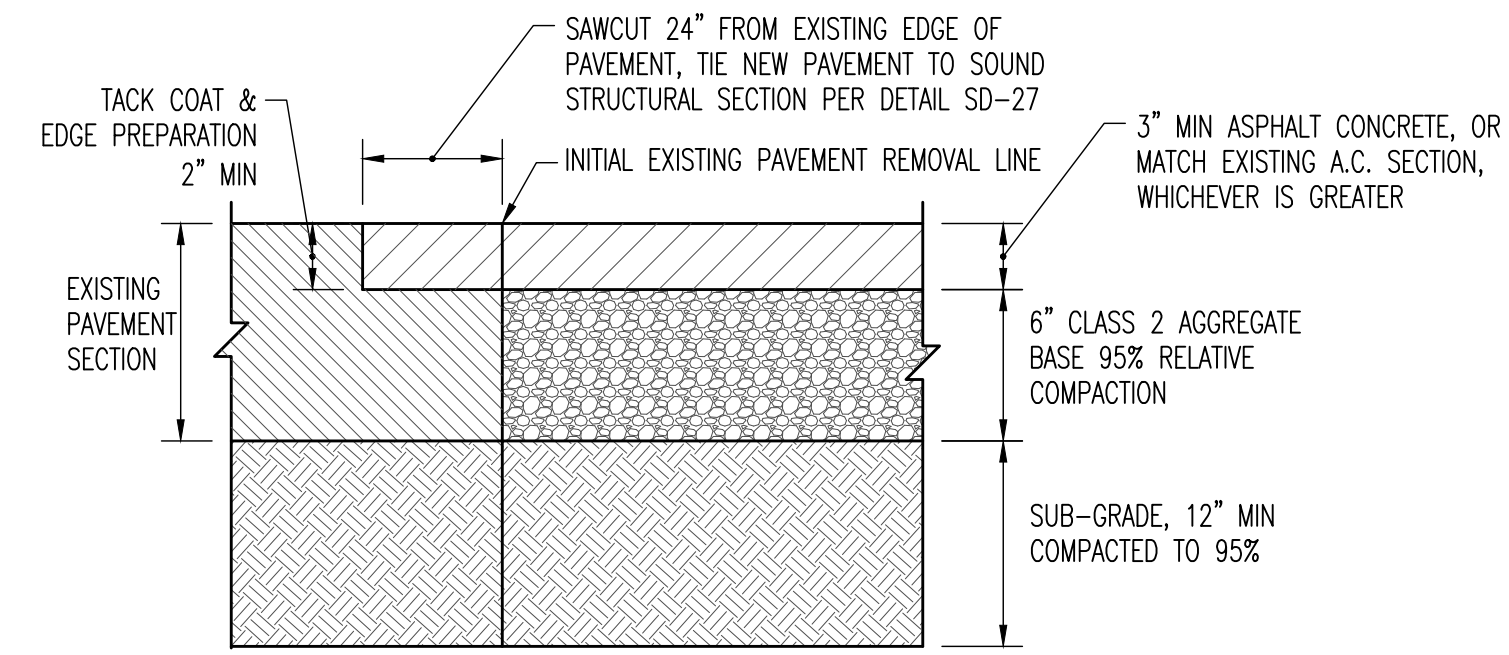


NOTES:

1. PAVEMENT RESTORATION MUST EQUAL EXISTING SECTION.

1 TRANSITION AC DETAIL
SCALE: NO SCALE

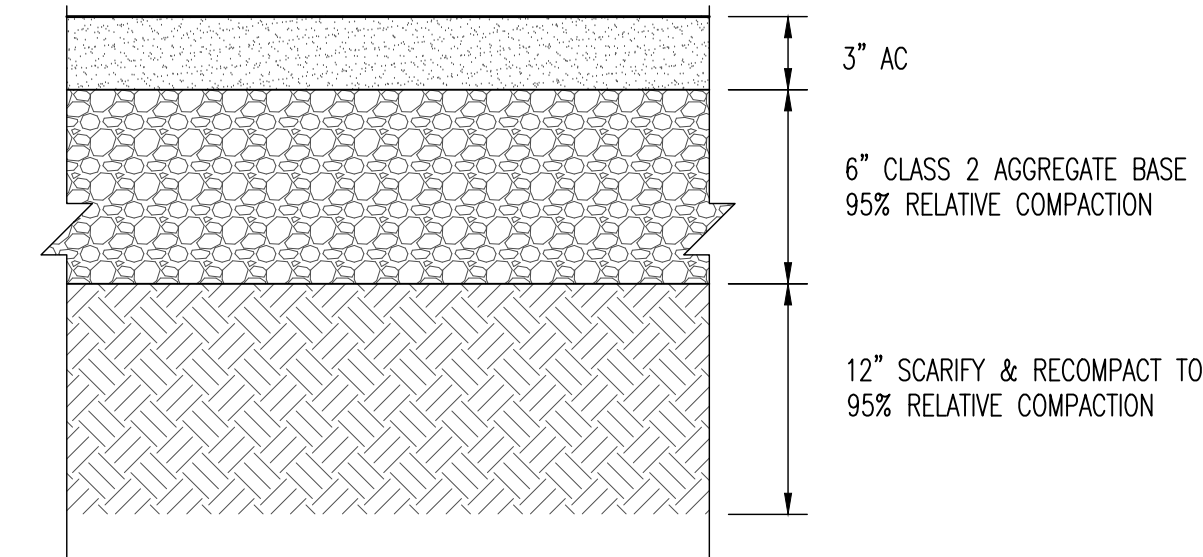


2 AC SECTION DETAIL
SCALE: NO SCALE

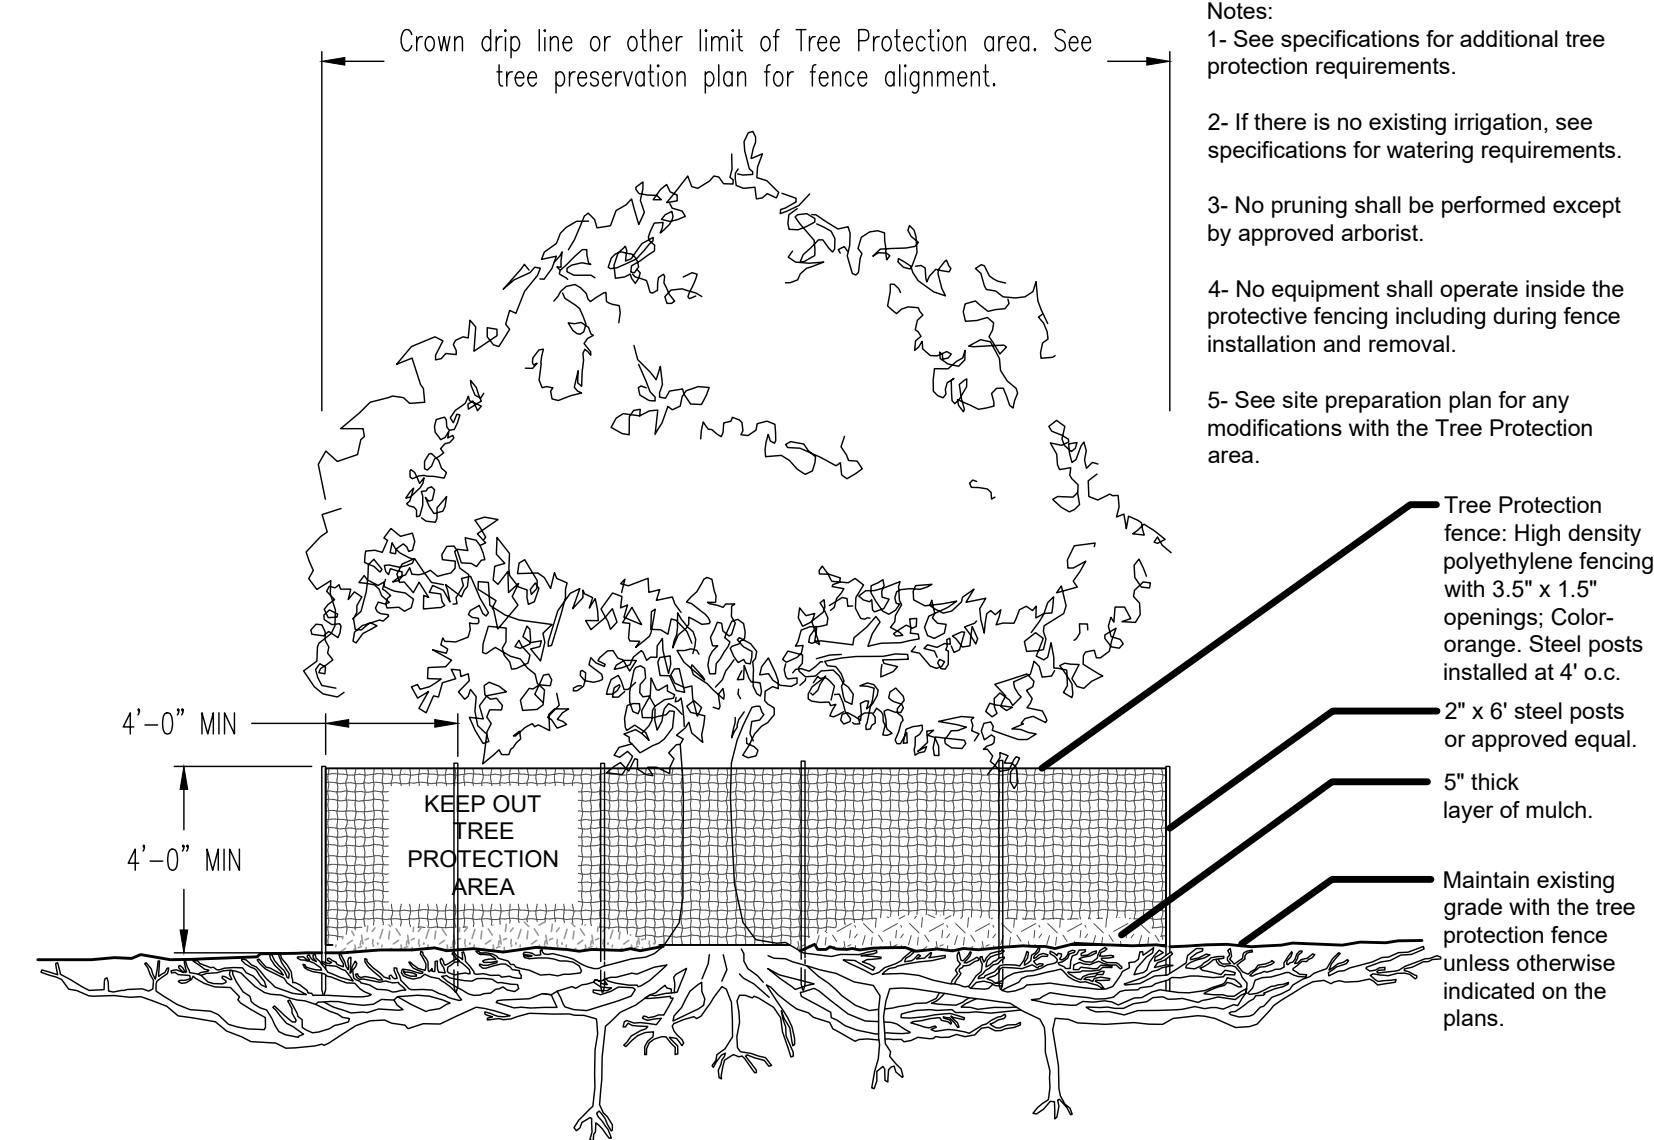

Notes:

- 1- See specifications for additional tree protection requirements.
- 2- If there is no existing irrigation, see specifications for watering requirements.
- 3- No pruning shall be performed except by approved arborist.
- 4- No equipment shall operate inside the protective fencing including during fence installation and removal.
- 5- See site preparation plan for any modifications with the Tree Protection area.

3 TREE PROTECTION DETAIL
SCALE: NO SCALE

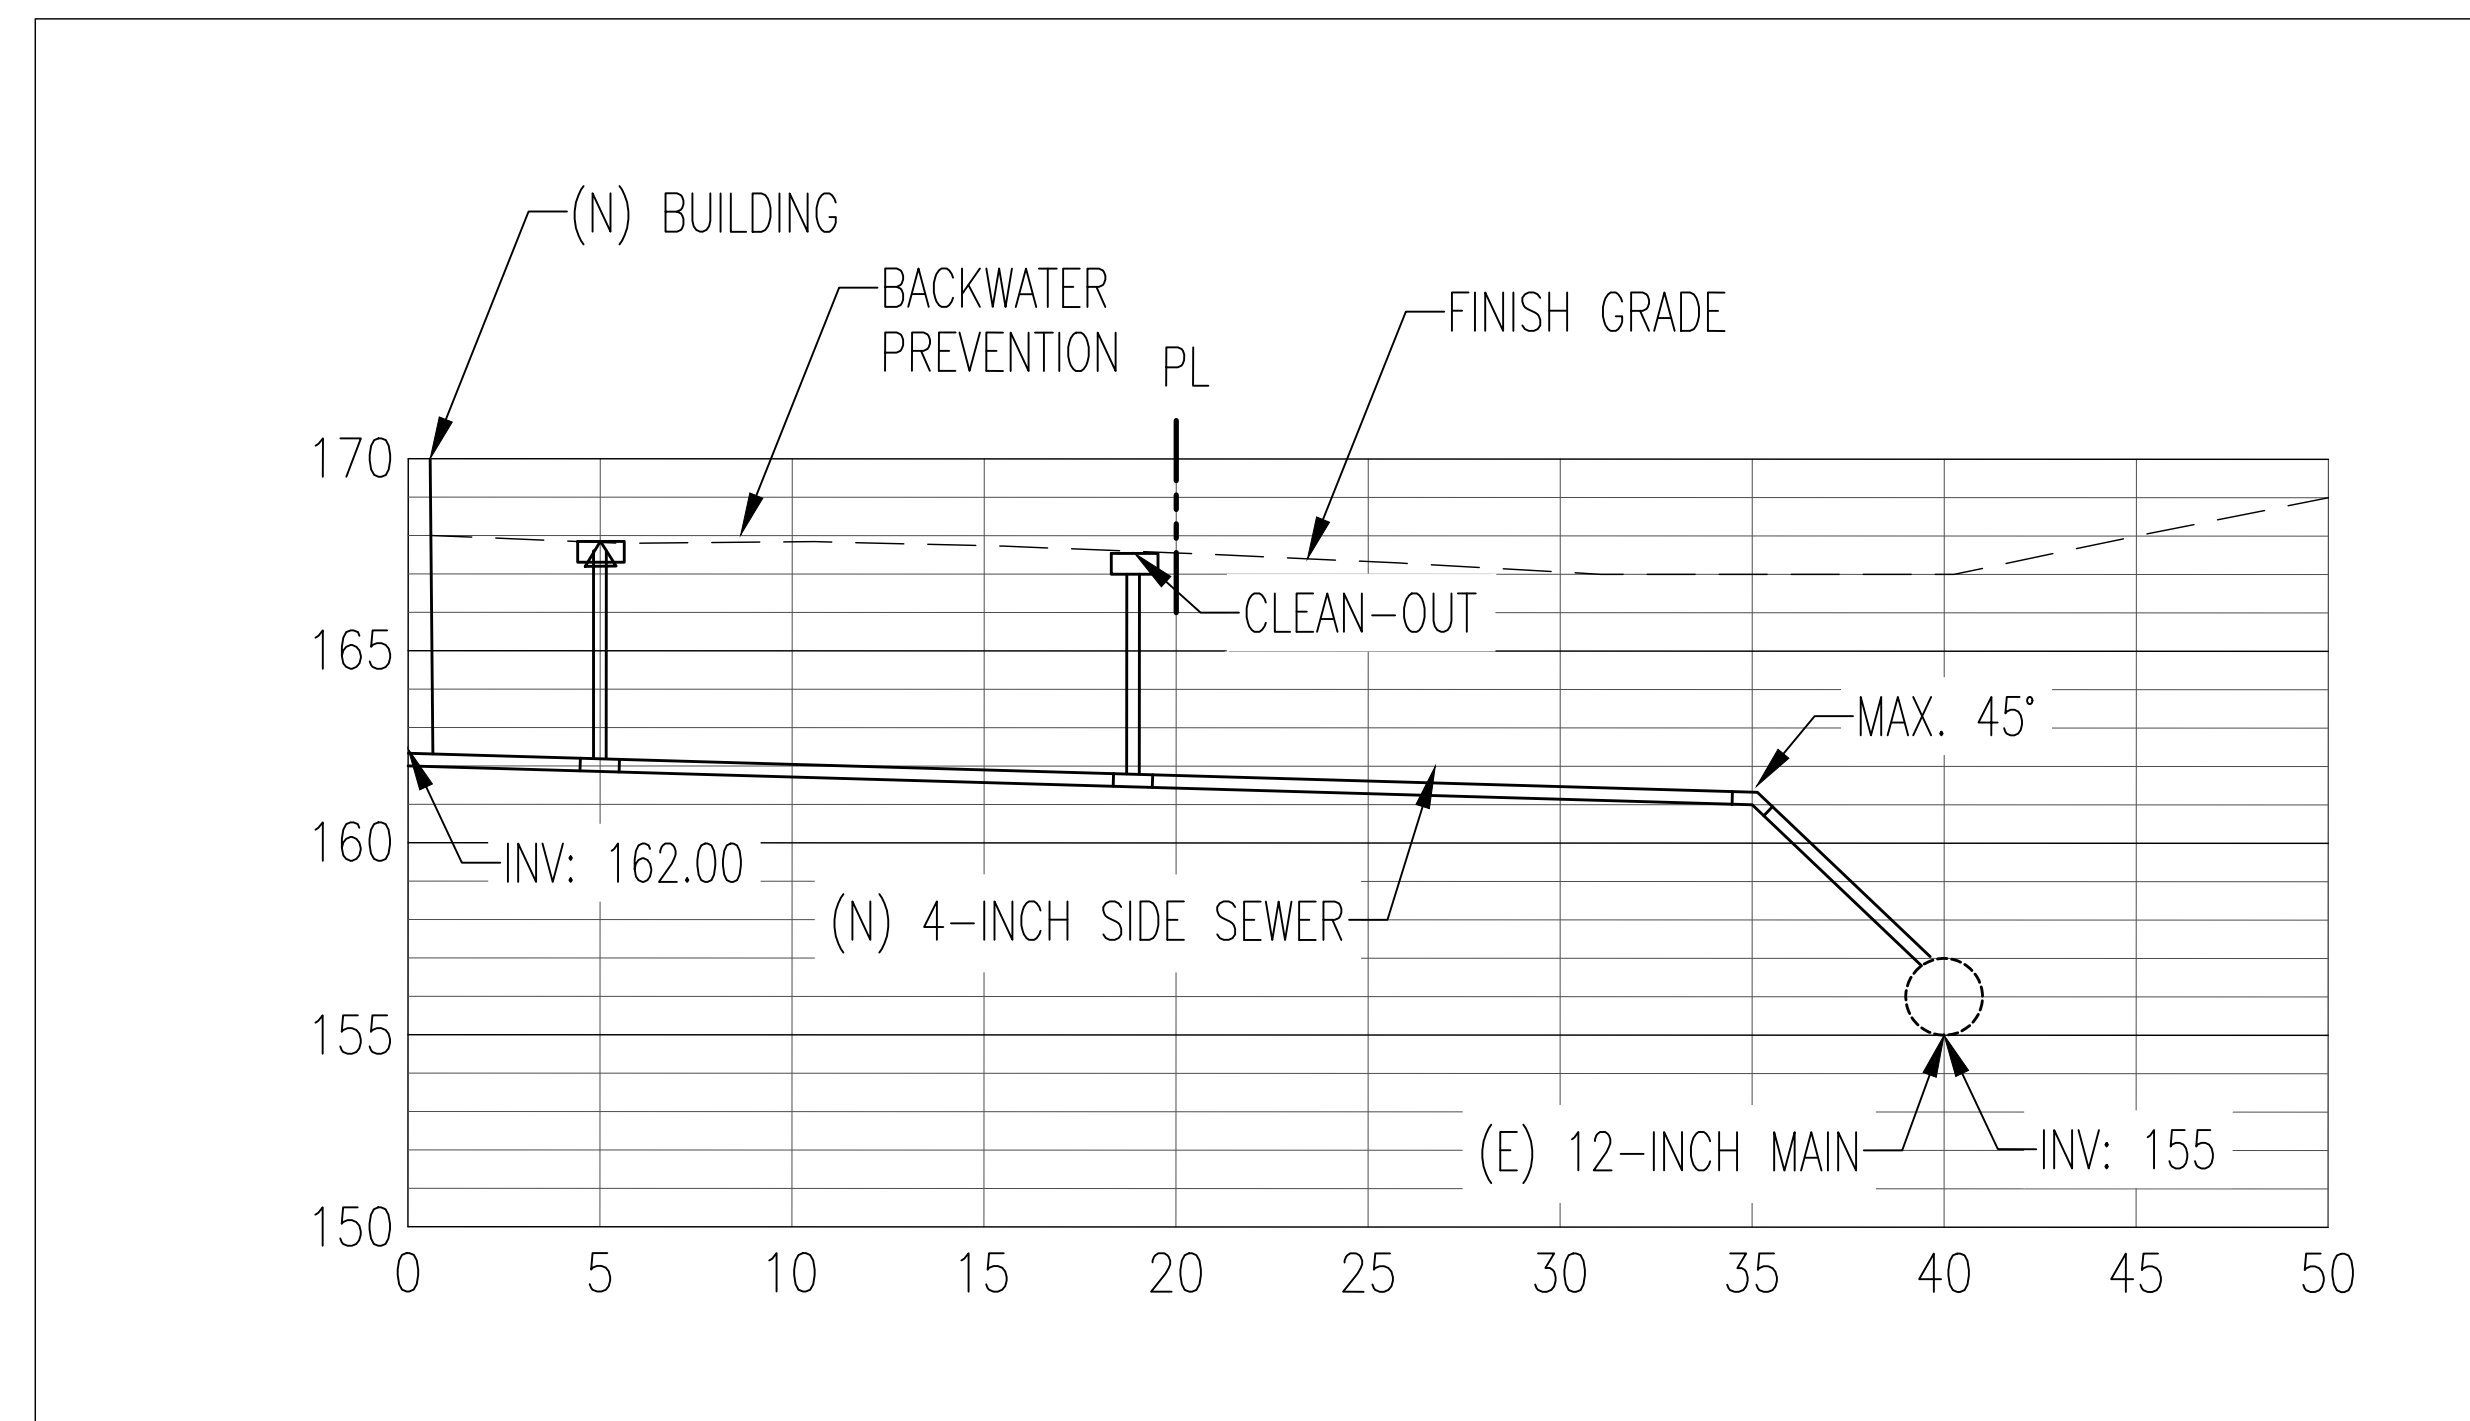

4 SIDE SEWER LATERAL SECTION DETAIL
SCALE: 1"=5'

SYMBOL	DESCRIPTION	DATE	APPROVED
B	NEW SITE PLAN	03-03-24	IK
A	FOR REVIEW	02-21-23	IK




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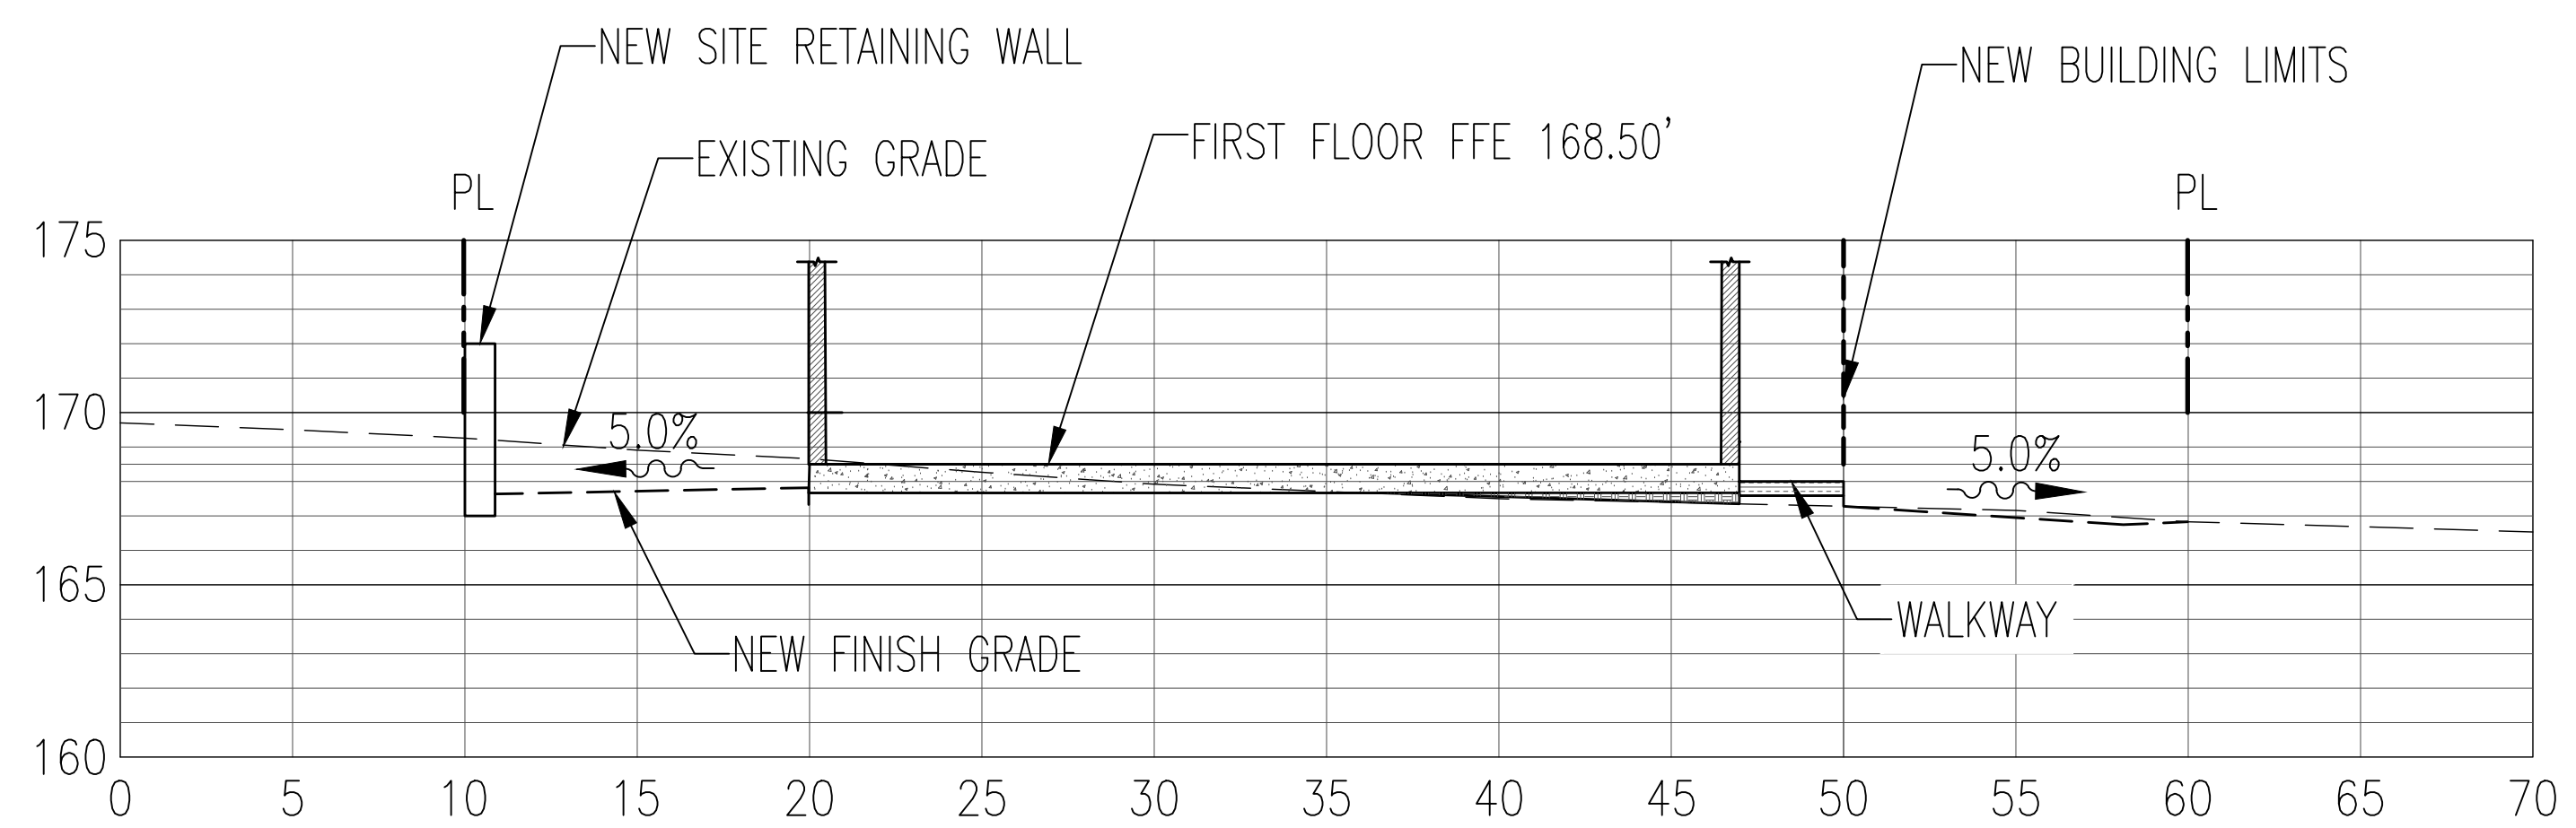
DETAILS

DATE	FEBRUARY 2023
SCALE	AS SHOWN
DESIGN	IK
DRAWN	IK
PROJECT	23001
SHEET	8 OF 15

C2.2




1 SECTION A-A
1"=5'; V:1', H:5'

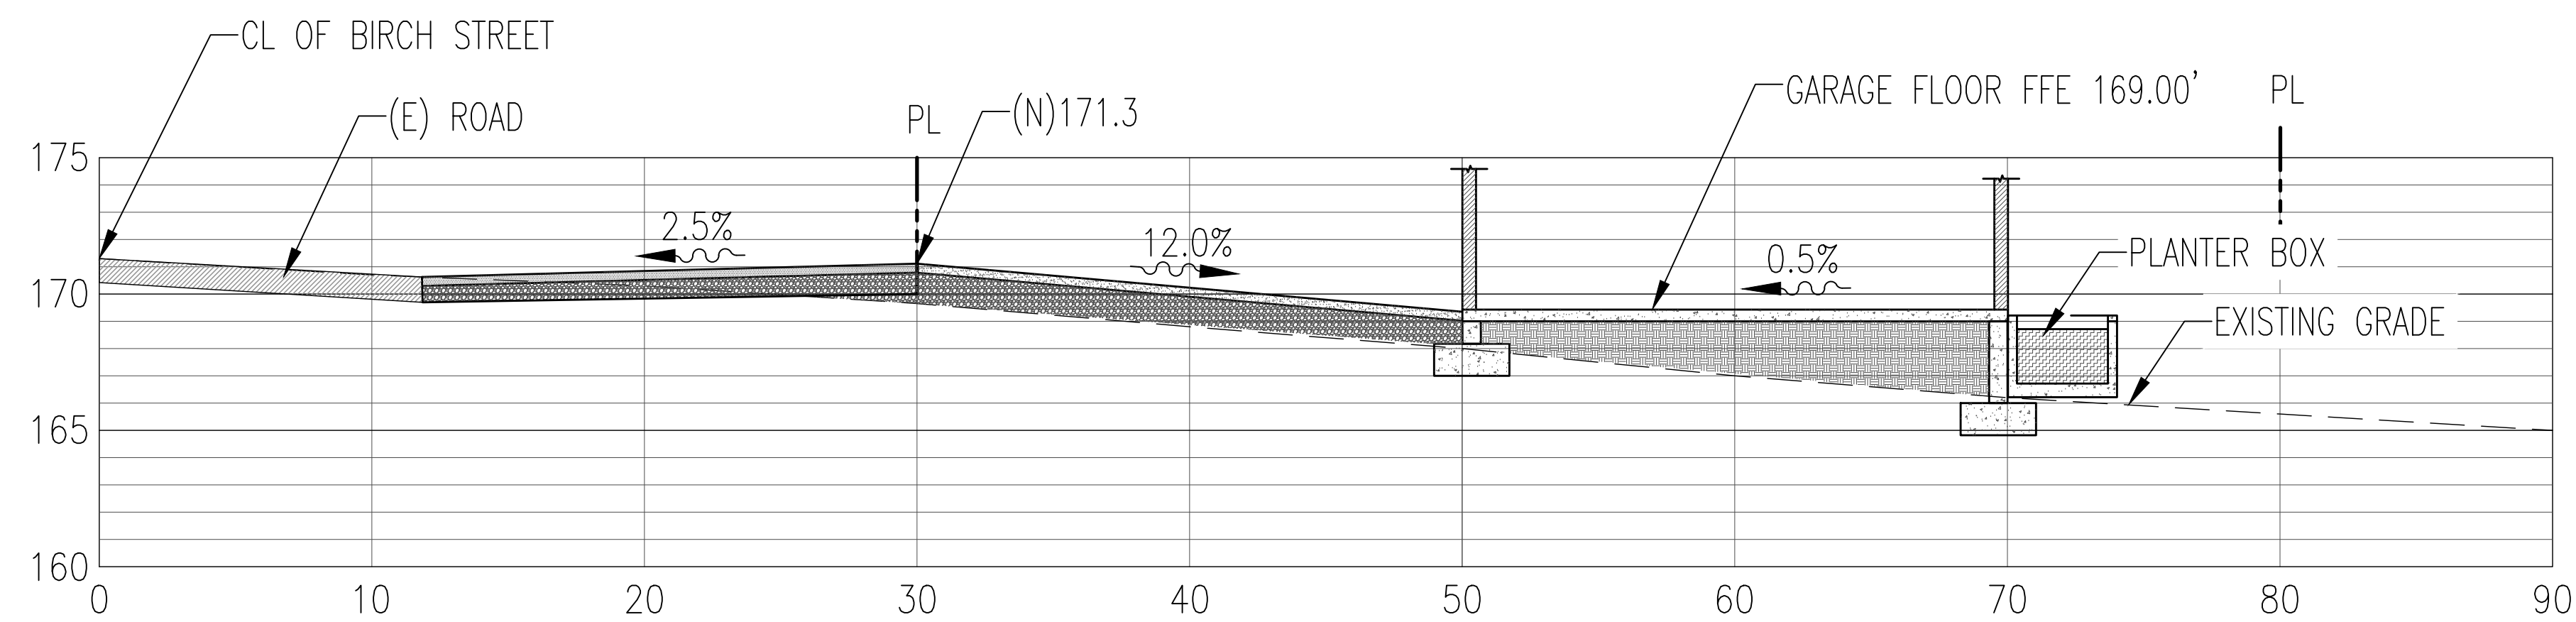

2 SECTION B-B
1"=5'; V:1', H:5'

SYMBOL	DESCRIPTION	DATE	APPROVED
B	NEW SITE PLAN	03-03-24	IK
A	FOR REVIEW	02-21-23	IK

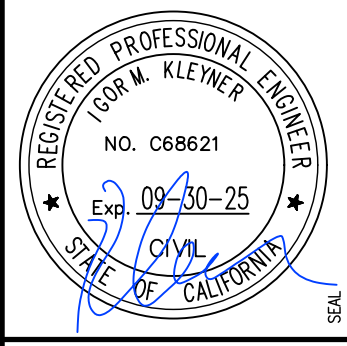


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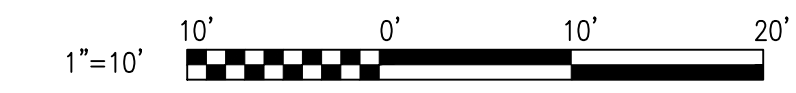
SECTION A-A

DATE	FEBRUARY 2023
SCALE	AS SHOWN
DESIGN	IK
DRAWN	IK
PROJECT	23001
SHEET	9 OF 15

C2.3



1 SITE PLAN
SCALE 1"=10'

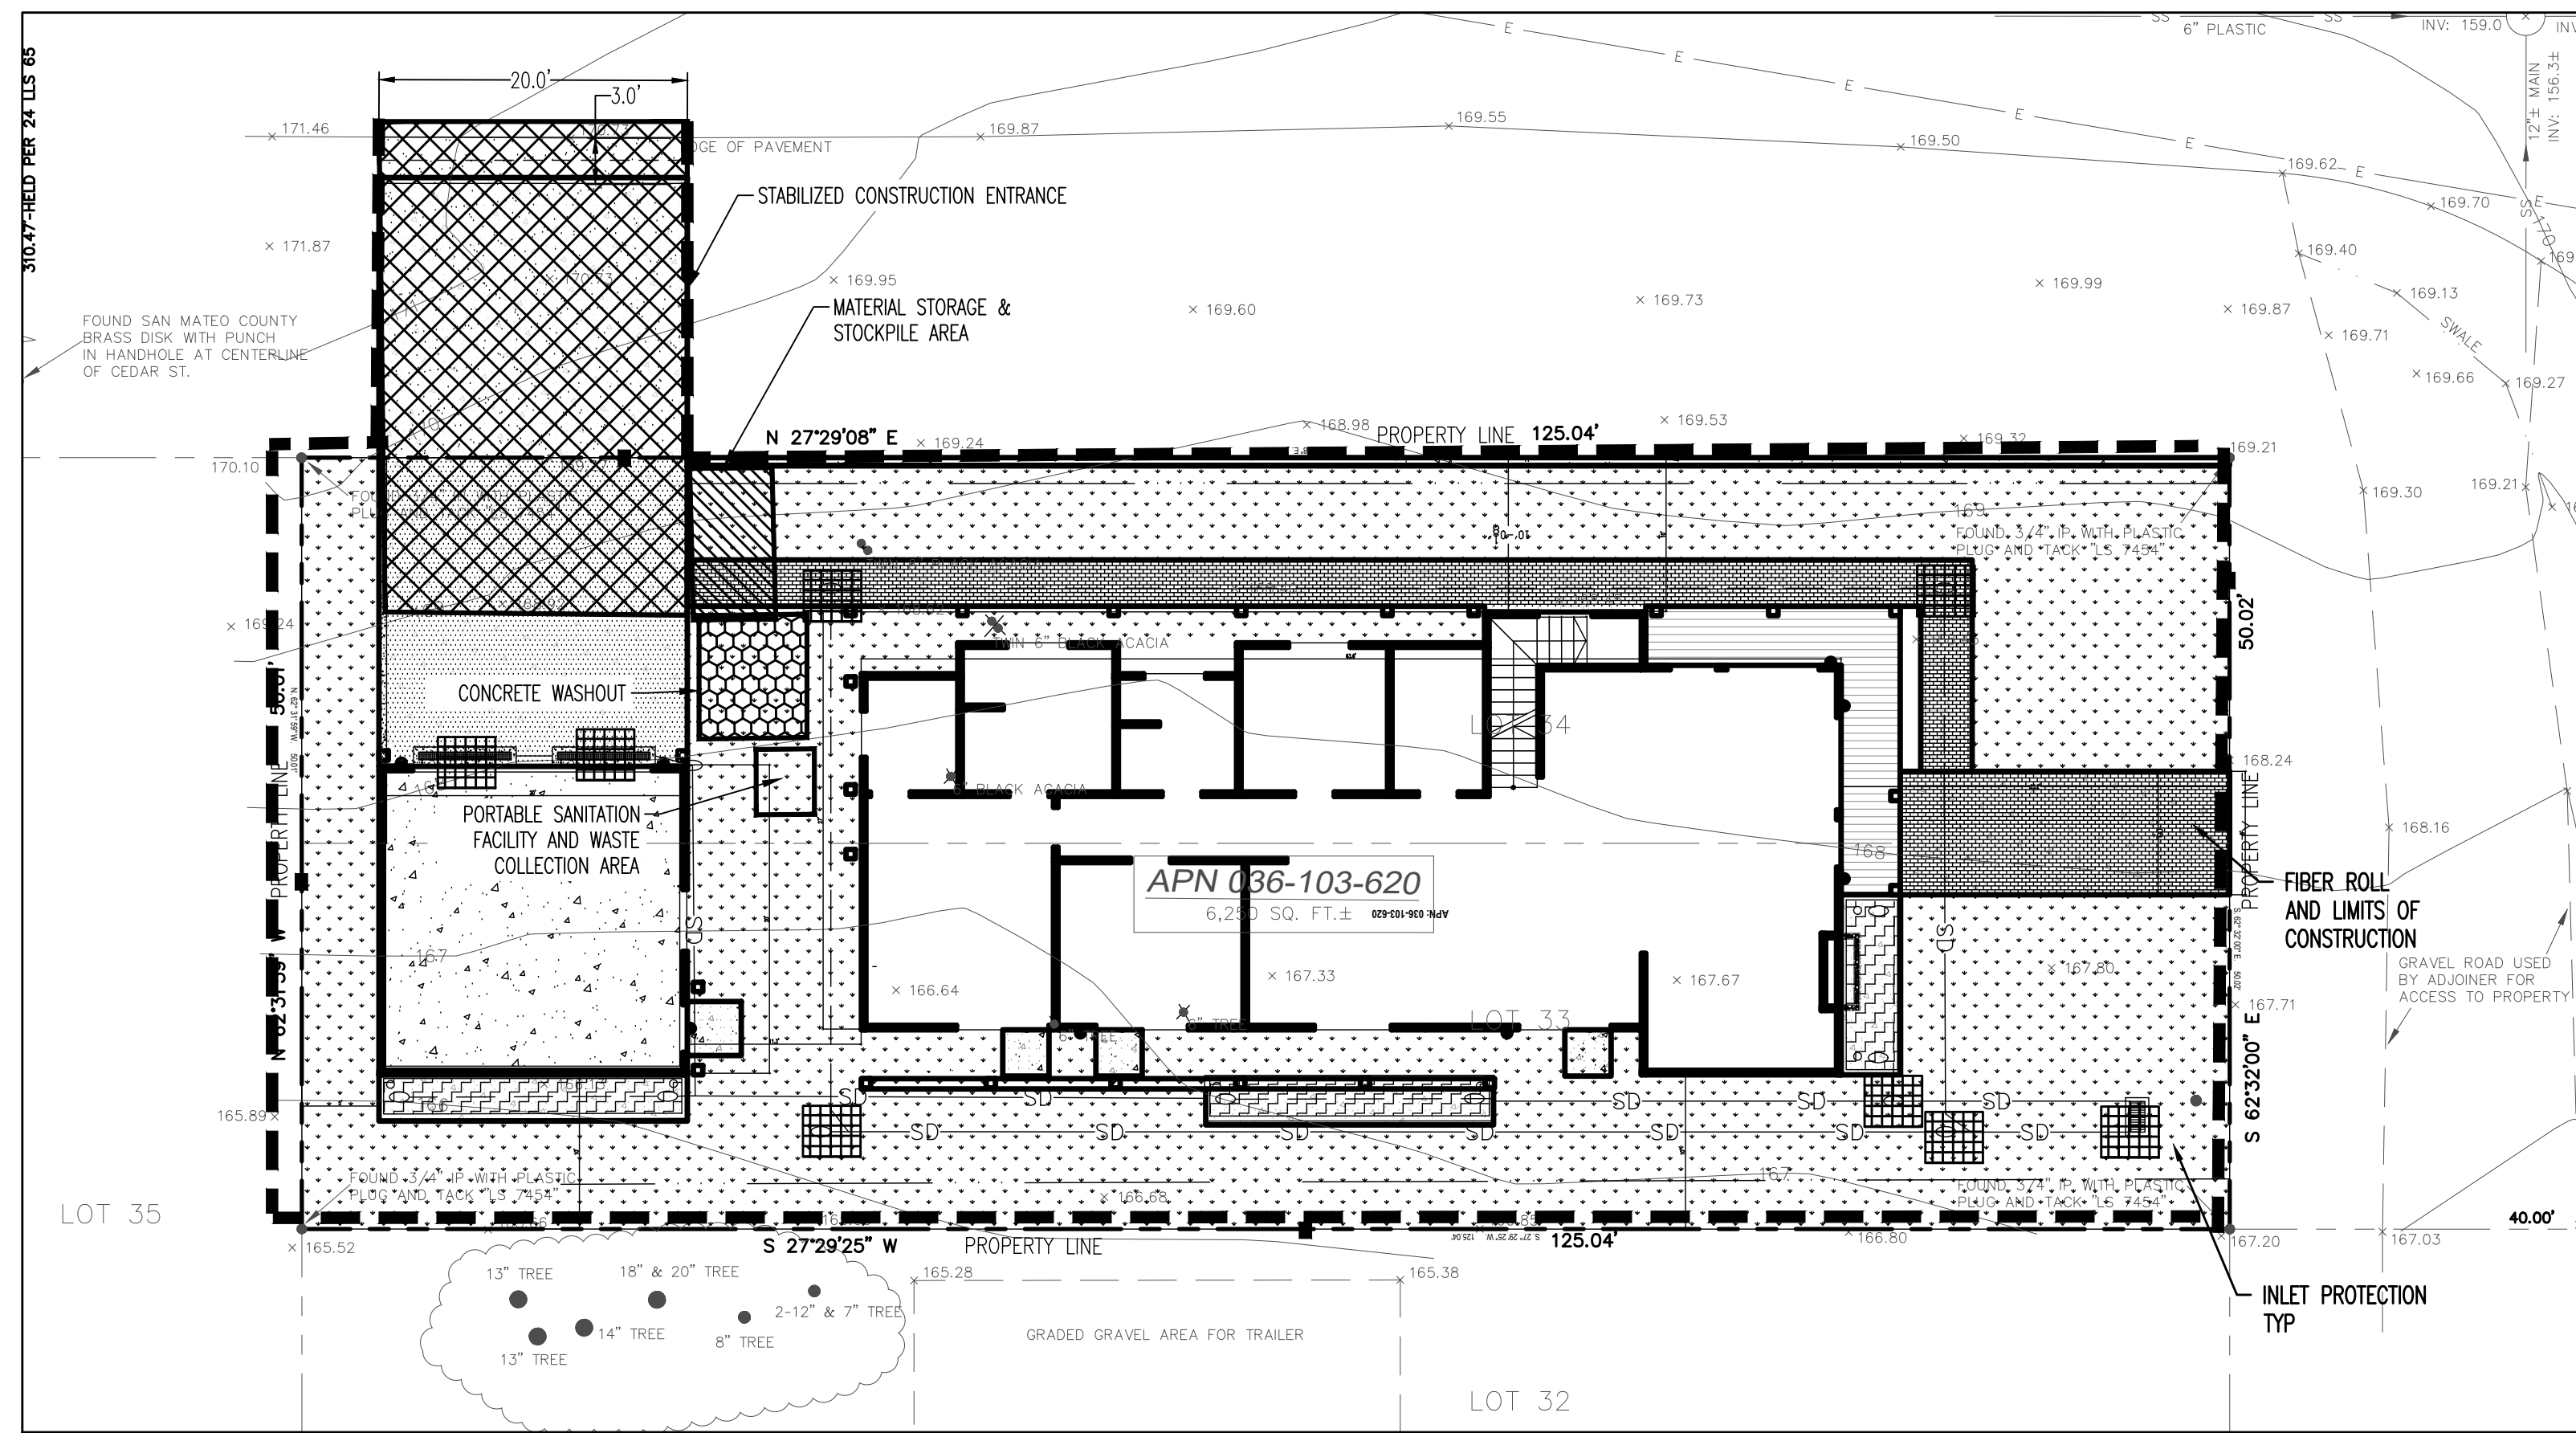

EROSION & SEDIMENT CONTROL NOTES:

- THIS PLAN IS INTENDED FOR EROSION CONTROL ONLY. OTHER INFORMATION SHOWN HEREIN MAY NOT BE THE MOST CURRENT.
- THE CONTRACTOR IS RESPONSIBLE FOR OBTAINING ALL PERMITS AND FILING ALL PLANS WITH THE RELATED AGENCIES ASSOCIATED WITH THEIR WORK. THIS SHALL INCLUDE, BUT NOT BE LIMITED TO, PERMITS FOR STORAGE OF HAZARDOUS MATERIALS, BUSINESS PLANS, PERMITS FOR STORAGE OF FLAMMABLE LIQUIDS, GRADING PERMITS, OR OTHER PLANS OR PERMITS REQUIRED BY THE JURISDICTION. ALL PROPERTY OWNERS, CONTRACTORS, OR SUBCONTRACTORS WORKING ON-SITE ARE INDIVIDUALLY RESPONSIBLE FOR OBTAINING AND SUBMITTING ANY BUSINESS PLANS OR PERMITS REQUIRED BY CITY, STATE OR LOCAL AGENCIES.
- ALL EROSION CONTROL MEASURES SHALL BE MAINTAINED, DURING THE RAINY SEASON (OCT. 15 TO MAY 15), UNTIL DISTURBED AREAS ARE STABILIZED. CHANGES TO THIS PLAN TO MEET FIELD CONDITIONS WILL BE MADE ONLY WITH THE APPROVAL OF, OR AT THE DIRECTION OF THE OWNER. CHANGES MADE TO SUIT FIELD CONDITIONS WILL BE MADE ONLY WITH THE APPROVAL OF OR AT THE DIRECTION OF THE OWNER. CHANGES MADE TO SUIT FIELD CONDITIONS SHALL BE BROUGHT TO THE IMMEDIATE ATTENTION OF THE CIVIL ENGINEER AND JURISDICTION FOR COMMENT AND APPROVAL.
- ALL EROSION CONTROL FACILITIES MUST BE INSPECTED AND REPAIRED AS NECESSARY AT THE END OF EACH WORKING DAY, AFTER SIGNIFICANT RAIN OR DAILY DURING THE RAINY SEASON.
- IF SIGNIFICANT SEDIMENT OR OTHER VISUAL SYMPTOMS OF IMPURITIES ARE NOTICED IN THE STORM WATER, CONTACT THE CIVIL ENGINEER IMMEDIATELY.
- CONTRACTOR IS RESPONSIBLE FOR INSPECTION AND RESTORATION OF ALL ASPECTS OF THE EROSION CONTROL PLAN. SEDIMENT ON THE SIDEWALKS AND CUTTERS SHALL BE REMOVED BY SHOVEL OR BROOM AND DISPOSED APPROPRIATELY.
- ALL EMPLOYEES, CONTRACTORS, AND SUBCONTRACTORS ARE RESPONSIBLE FOR CONFORMING TO THE ELEMENTS SHOWN ON THIS PLAN AND RELATED DOCUMENTS.
- CONTRACTOR TO EMPLOY BEST MANAGEMENT PRACTICES (BMP'S) IN ACCORDANCE WITH THE STATE OF CALIFORNIA DEPARTMENT OF TRANSPORTATION.
- ALL DUMPSTERS OR OTHER TRASH STORAGE ENCLOSURES SHALL BE UTILIZED SOLELY FOR NON-HAZARDOUS MATERIALS.
- CONTRACTOR TO PROPERLY AVOID AND PROTECT EXISTING TREES AND TREE ROOTS
- DURING THE RAINY SEASON, ALL PAVED AREAS WILL BE KEPT CLEAR OF EARTH MATERIAL AND DEBRIS, THE SITE SHALL BE MAINTAINED SO THAT A MINIMUM OF SEDIMENT-LADEN RUNOFF ENTERS THE STORM DRAIN SYSTEM. THESE PLANS SHALL REMAIN IN EFFECT UNTIL THE IMPROVEMENTS ARE ACCEPTED BY THE JURISDICTION AND ALL SLOPES ARE STABILIZED.
- BORROW AREAS AND TEMPORARY STOCKPILES SHALL BE PROTECTED WITH APPROPRIATE EROSION CONTROL MEASURES TO THE SATISFACTION OF THE JURISDICTION.
- REMOVE SPOILS PROMPTLY AND AVOID STOCKPILING OF FILL MATERIALS WHEN RAIN IS FORECAST. IF RAIN IS FORECAST OR APPARENT, STOCKPILED SOILS AND OTHER MATERIALS SHALL BE COVERED WITH PLASTIC OR A TARP, AT THE REQUEST OF THE JURISDICTION.
- STORE, HANDLE AND DISPOSE OF CONSTRUCTION MATERIALS AND WASTES SO AS TO PREVENT THEIR ENTRY INTO THE STORM DRAIN SYSTEM. CONTRACTOR MUST NOT ALLOW CONCRETE, WASHWATERS, SLURRIES, PAINT OR OTHER MATERIALS TO ENTER THE CATCH BASINS, STORM DRAINAGE, OR ENTER SITE RUNOFF.
- USE FILTRATION OR OTHER APPROVED MEASURES TO REMOVE SEDIMENT FROM DEWATERING EFFLUENT.
- NO CLEANING, FUELING OR MAINTAINING VEHICLES ON SITE SHALL BE PERMITTED TO ALLOW DELETERIOUS MATERIALS FROM ENTERING THE CATCH BASINS, STORM DRAINAGE, OR ENTER SITE RUNOFF.
- EROSION CONTROL MEASURES TO BE EMPLOYED PER "EROSION AND SEDIMENT CONTROL FIELD MANUAL", CALIFORNIA REGIONAL WATER QUALITY CONTROL BOARD CENTRAL COAST REGION.
- VEHICLES SHALL BE WASHED PRIOR TO LEAVING SITE DURING CONSTRUCTION.
- SEEPS OR SPRINGS ENCOUNTERED DURING CONSTRUCTION SHALL BE HANDLED IN ACCORDANCE WITH APPROVED METHODS ESTABLISHED BY THE SOILS ENGINEER.
- STOCKPILES, BORROW AREAS AND SPOIL AREAS SHALL BE STABILIZED TO PREVENT EROSION AND SEDIMENTATION.
- APPLY SEED, FERTILIZER AND STRAW MULCH, THEN TRACK OR PUSH IN THE MULCH WITH AN APPROVED MECHANICAL MEANS OR BY HAND.
- DISTURBANCE OF SURFACE VEGETATION DURING CONSTRUCTION SHALL BE KEPT TO A MINIMUM.
- DISTURBED AREAS SHOULD BE SEEDED, FERTILIZED, AND MULCHED TO PREVENT EROSION DURING WINTER MONTHS. INSTALL STRAW BALE SILTATION BARRIER AS NECESSARY.
- CONTRACTOR SHALL BE RESPONSIBLE FOR STREET SWEEPING TO KEEP DUST, SOIL, AND OTHER CONSTRUCTION DEBRIS FROM LEAVING PROJECT SITE.

COUNTY OF SAN MATEO EROSION & SEDIMENT CONTROL NOTES:

- EROSION CONTROL POINT OF CONTACT: NAME: _____ ADDRESS: _____ EMAIL: _____ TEL: _____
- PERFORM CLEARING AND EARTH-MOVING ACTIVITIES ONLY DURING DRY WEATHER. MEASURES TO ENSURE ADEQUATE EROSION AND SEDIMENT CONTROL SHALL BE INSTALLED PRIOR TO EARTH-MOVING ACTIVITIES AND CONSTRUCTION.
 - MEASURES TO ENSURE ADEQUATE EROSION AND SEDIMENT CONTROL ARE REQUIRED YEAR-ROUND. STABILIZE ALL DENUDED AREAS AND MAINTAIN EROSION CONTROL MEASURES CONTINUOUSLY BETWEEN OCTOBER 1 AND APRIL 30.
 - STORE, HANDLE, AND DISPOSE OF CONSTRUCTION MATERIALS AND WASTES PROPERLY, SO AS TO PREVENT THEIR CONTACT WITH STORMWATER.
 - CONTROL AND PREVENT THE DISCHARGE OF ALL POTENTIAL POLLUTANTS, INCLUDING PAVEMENT CUTTING WASTES, PAINTS, CONCRETE, PETROLEUM PRODUCTS, CHEMICALS, WASH WATER OR SEDIMENTS, AND NON-STORMWATER DISCHARGES TO STORM DRAINS AND WATERCOURSES.
 - USE SEDIMENT CONTROLS OR FILTRATION TO REMOVE SEDIMENT WHEN DEWATERING SITE AND OBTAIN REGIONAL WATER QUALITY CONTROL BOARD (RWQCB) PERMIT(S) AS NECESSARY.
 - AVOID CLEANING, FUELING, OR MAINTAINING VEHICLES ON-SITE, EXCEPT IN A DESIGNATED AREA WHERE WASH WATER IS CONTAINED AND TREATED.
 - LIMIT AND TIME APPLICATIONS OF PESTICIDES AND FERTILIZERS TO PREVENT POLLUTED RUNOFF.
 - LIMIT CONSTRUCTION ACCESS ROUTES TO STABILIZED, DESIGNATED ACCESS POINTS.
 - AVOID TRACKING DIRT OR OTHER MATERIALS OFF-SITE; CLEAN OFF-SITE PAVED AREAS AND SIDEWALKS USING DRY SWEEPING METHODS.
 - TRAIN AND PROVIDE INSTRUCTION TO ALL EMPLOYEES AND SUBCONTRACTORS REGARDING THE WATERSHED PROTECTION MAINTENANCE STANDARDS AND CONSTRUCTION BEST MANAGEMENT PRACTICES.
 - PLACEMENT OF EROSION MATERIALS REQUIRED ON WEEKENDS AND DURING RAIN EVENTS.
 - THE AREAS DELINEATED ON THE PLANS FOR PARKING, GRUBBING, STORAGE, ETC., SHALL NOT BE ENLARGED OR "RUN OVER."
 - CONSTRUCTION SITES ARE REQUIRED TO HAVE EROSION CONTROL MATERIALS ON-SITE DURING THE "OFF-SEASON."
 - DUST CONTROL IS REQUIRED YEAR-ROUND.
 - EROSION CONTROL MATERIALS SHALL BE STORED ON-SITE.
 - USE OF PLASTIC SHEETING BETWEEN OCTOBER 1 AND APRIL 30 IS NOT ACCEPTABLE, UNLESS FOR USE ON STOCKPILES WHERE THE STOCKPILE IS ALSO PROTECTED WITH FIBER ROLLS CONTAINING THE BASE OF THE STOCKPILE.
 - TREE PROTECTION SHALL BE IN PLACE BEFORE ANY DEMOLITION, GRADING, EXCAVATING OR GRUBBING IS STARTED
 - PROTECT ALL STORM DRAIN INLETS AND OUTLETS IN VICINITY OF SITE USING SEDIMENT CONTROLS SUCH AS BERMS, FIBER ROLLS, OR FILTERS.
 - USE TEMPORARY EROSION CONTROLS TO STABILIZE ALL DENUDED AREAS UNTIL PERMANENT EROSION CONTROLS ARE ESTABLISHED.
 - TRAP SEDIMENT ON-SITE, USING BEST MANAGEMENT PRACTICES SUCH AS SEDIMENT BASINS OR TRAPS, EARTHEN DIKES OR BERMS, SILT FENCES, CHECK DAMS, SOIL BLANKETS OR MATS, COVERS FOR SOIL STOCK PILES, ETC.
 - DIVERT ON-SITE RUNOFF AROUND EXPOSED AREAS; DIVERT OFF-SITE RUNOFF AROUND THE SITE (E.G., SWALES AND DIKES).
 - PROTECT ADJACENT PROPERTIES AND UNDISTURBED AREAS FROM CONSTRUCTION IMPACT USING VEGETATIVE BUFFER STRIPS, SEDIMENT BARRIERS, DIKES, MULCHING, OR OTHER MEASURES AS APPROPRIATE.

CONSTRUCTION PARKING AND STORAGE

- PARK CONSTRUCTION VEHICLES IN THE DESIGNATED AREAS OF THE EXISTING DRIVEWAY AND ALONG LARCHMONT RD
- EQUIPMENT AND MATERIALS TO BE STORED AS SHOWN ON PLAN

CONSTRUCTION NOTES:

- EXCAVATION, GRADING, FILLING, CLEANING OF VEGETATION SHALL BE DONE BY HAND AND/OR SMALL MACHINERY. USE STOCKPILE AREA FOR STORAGE.
- MIXED CONSTRUCTION AND DISPOSAL DEBRIS MUST BE TRANSPORTED OFF-SITE BY ORDINANCE OF CITY, STATE, OR LOCAL AGENCIES.
- CONTRACTOR SHALL PROVIDE TEMPORARY IRRIGATION AND INSTALL PERMANENT IRRIGATION AFTER COMPLETION OF THE CONSTRUCTION.
- ALL DISTURBED AREAS MUST BE GRASSED IMMEDIATELY AFTER CONSTRUCTION IS COMPLETED.

LEGEND



SYMBOL	DESCRIPTION	DATE	APPROVED
B	NEW SITE PLAN	03-03-24	IK
A	FOR REVIEW	02-21-23	IK





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APN: 036-103-620**


EROSION CONTROL PLAN

DATE	FEBRUARY 2023
SCALE	AS SHOWN
DESIGN	IK
DRAWN	IK
PROJECT	23001
SHEET	10 OF 15

C3.0

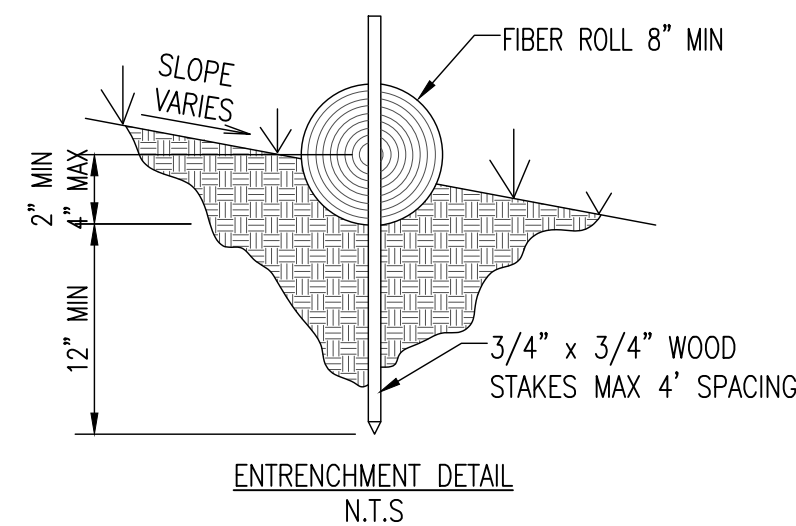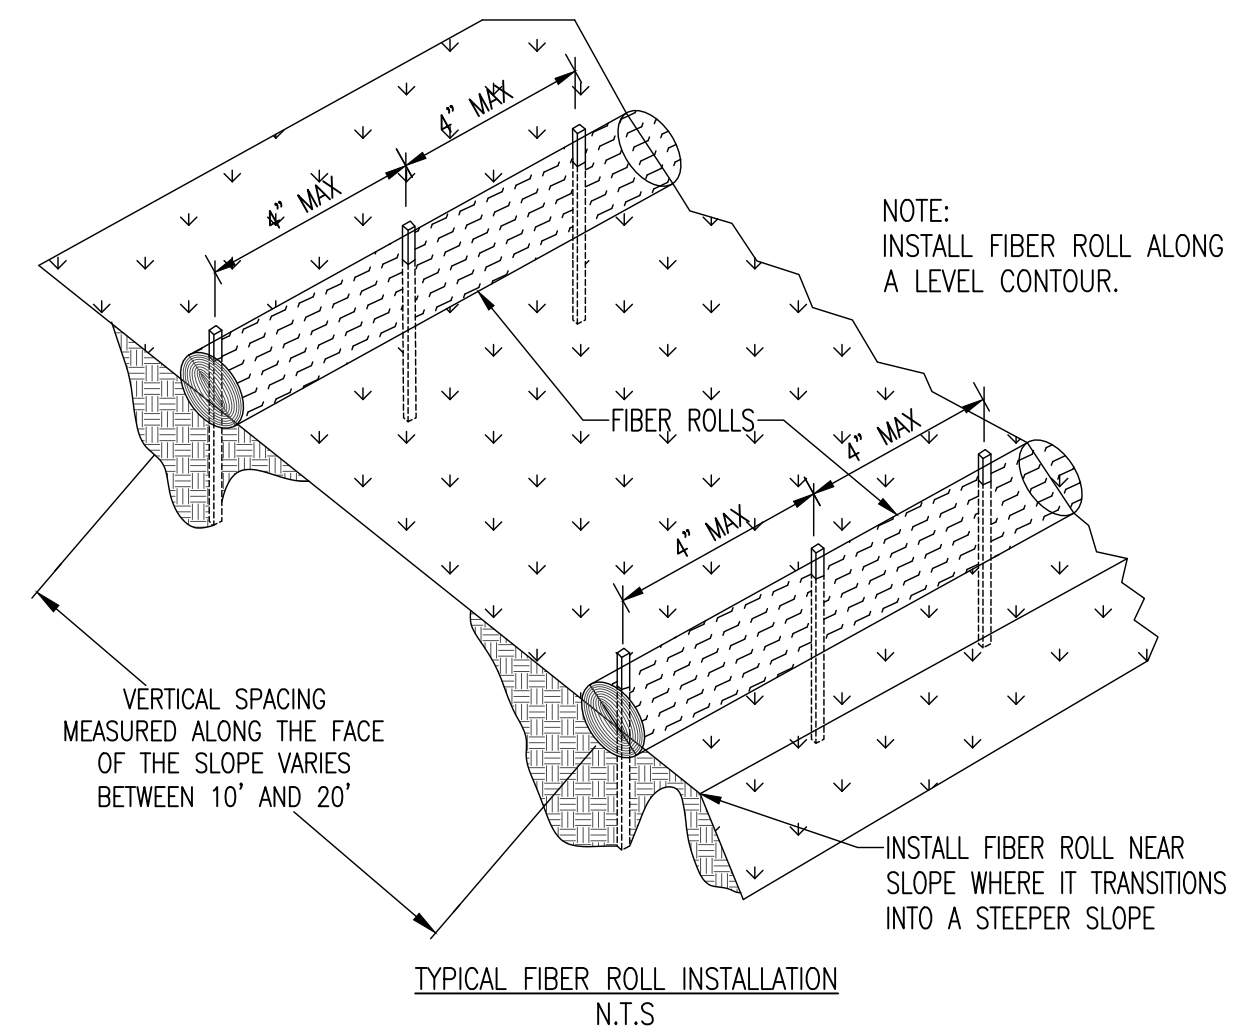


1 FIBER ROLL
NOT TO SCALE

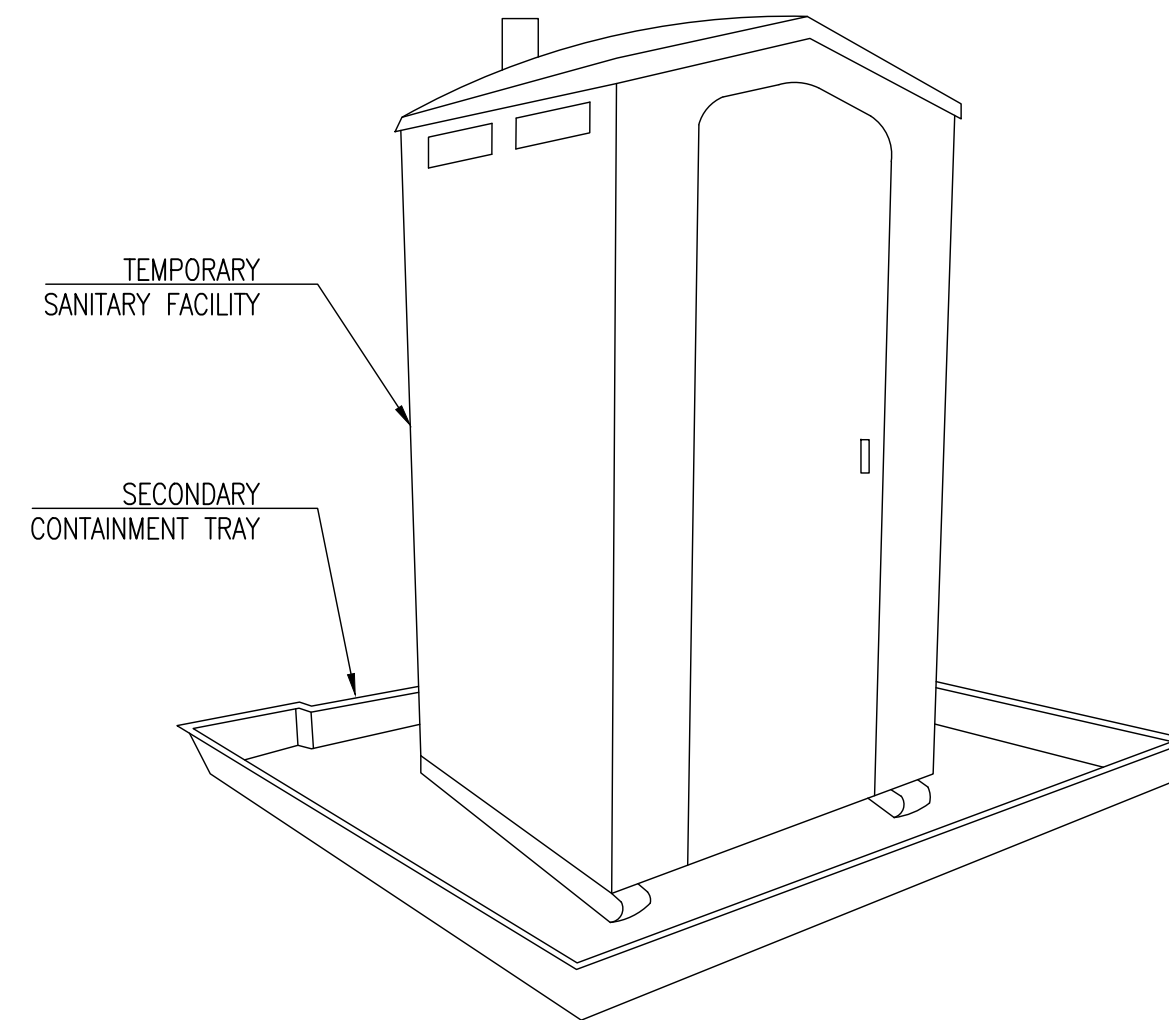

STORAGE AND DISPOSAL PROCEDURES:

- TEMPORARY SANITARY FACILITIES SHOULD BE LOCATED AWAY FROM DRAINAGE FACILITIES, WATERCOURSES, AND FROM TRAFFIC CIRCULATION. IF SITE CONDITIONS ALLOW, PLACE PORTABLE FACILITIES A MINIMUM OF 50 FEET FROM DRAINAGE CONVEYANCES AND TRAFFIC AREAS.
- WHEN SUBJECTED TO HIGH WINDS OR RISK OF HIGH WINDS, TEMPORARY SANITARY FACILITIES SHOULD BE SECURED TO PREVENT OVERTURNING.
- TEMPORARY SANITARY FACILITIES MUST BE EQUIPPED WITH SECONDARY CONTAINMENT TRAYS TO PREVENT DISCHARGE OF POLLUTANTS TO THE STORMWATER DRAINAGE SYSTEM OF THE RECEIVING WATER.
- ARRANGE FOR REGULAR WASTE COLLECTION, DO NOT ALLOW SANITARY FACILITY TO BECOME OVERFULL.


2 SANITARY WASTE MANAGEMENT
NOT TO SCALE

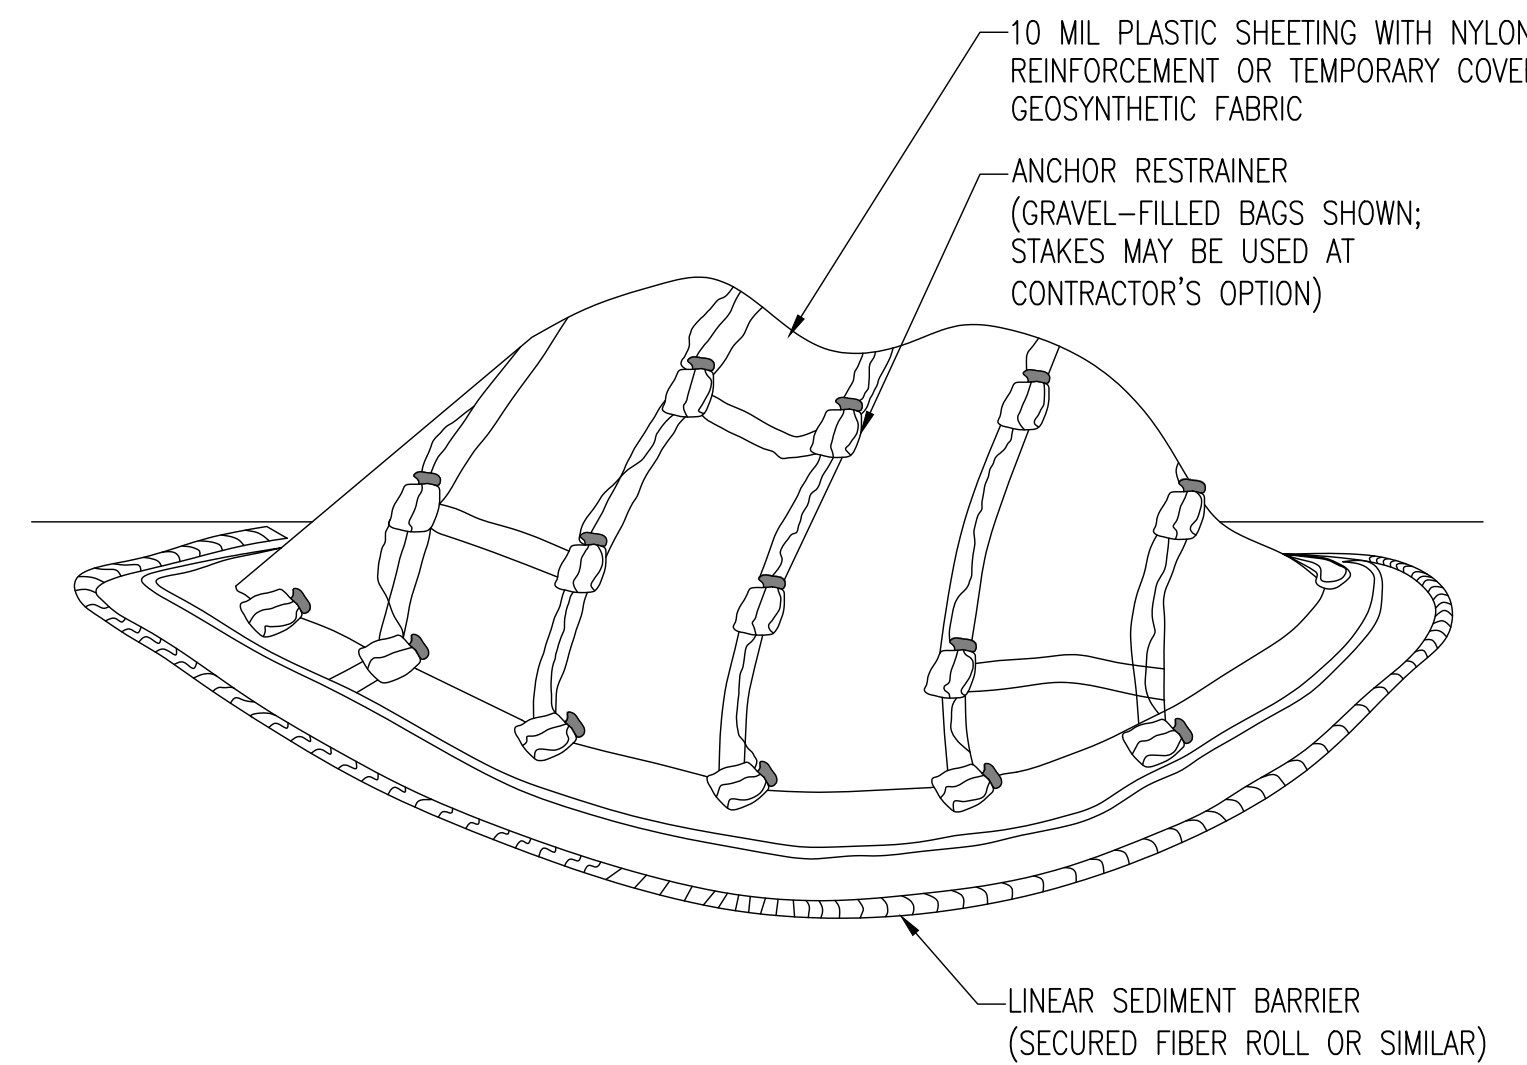

NOTES:


- ALL STOCKPILES SHALL BE CONTAINED AND COVERED WHEN NOT ACTIVE, AND SECURED AT THE END OF EACH DAY.
- STOCKPILES SHALL BE SECURELY COVERED OVERNIGHT, AND PRIOR TO, DURING, AND AFTER RAIN EVENTS.
- NO MATERIAL SHALL LEAVE THE SITE OR MOVE INTO STREET.
- PLASTIC SHEETING HAS LIMITATIONS DUE TO SUNLIGHT BREAKDOWN, HARD TO MANAGE IN WINDY CONDITIONS, AND CAN INCREASE RUNOFF ISSUE FOR PERIMETER CONTROLS. INSPECT FREQUENTLY OR USE GEOSYNTHETIC FABRIC AS APPLICABLE.
- DO NOT LOCATE WITHIN 50 FEET OF A STORM DRAIN.

3 TEMPORARY COVER ON STOCKPILE
NOT TO SCALE

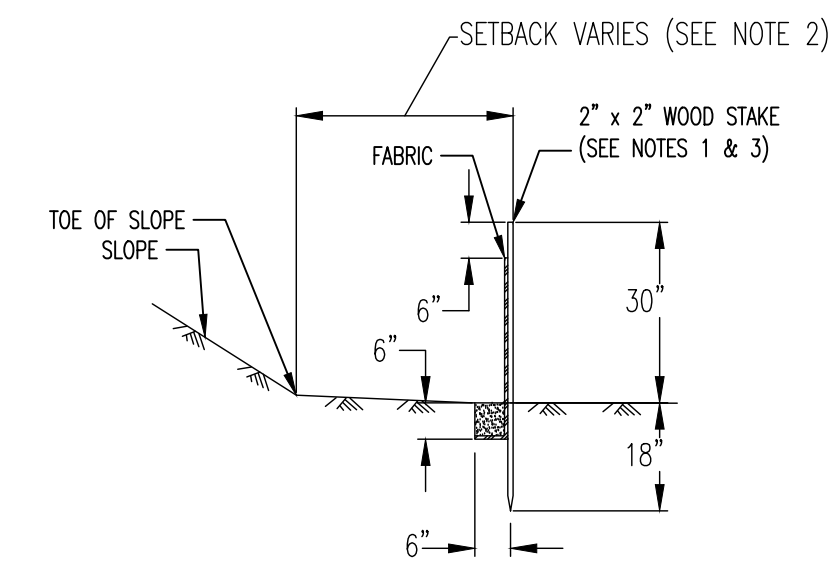

NOTES:


- STAKE DIMENSIONS ARE NOMINAL.
- DIMENSIONS MAY VARY TO FIT FIELD CONDITIONS.
- STAKES SHALL BE SPACED AT 8'-0" MAXIMUM AND SHALL BE POSITIONED ON DOWNSTREAM SIDE OF FENCE.
- STAKES TO OVERLAP AND FENCE FABRIC TO FOLD AROUND EACH STAKE AND FULL TURN. SECURE.

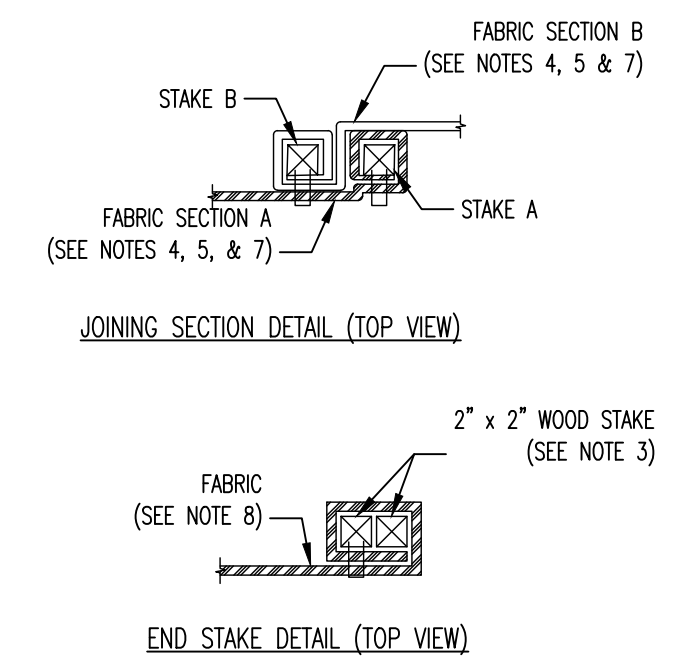

FABRIC TO STAKE WITH 4 STAPLES.


- STAKES SHALL BE DRIVEN TIGHTLY TOGETHER TO PREVENT POTENTIAL FLOW-THROUGH OF SEDIMENT AT JOINT. THE TOPS OF THE STAKES SHALL BE SECURED WITH WIRE.
- FOR END STAKE, FENCE FABRIC SHALL BE FOLDED AROUND TWO STAKES ONE FULL TURN AND SECURED WITH 4 STAPLES.
- JOINING SECTIONS SHALL NOT BE PLACED AT SUMP LOCATIONS.

4 SILT FENCE
NOT TO SCALE

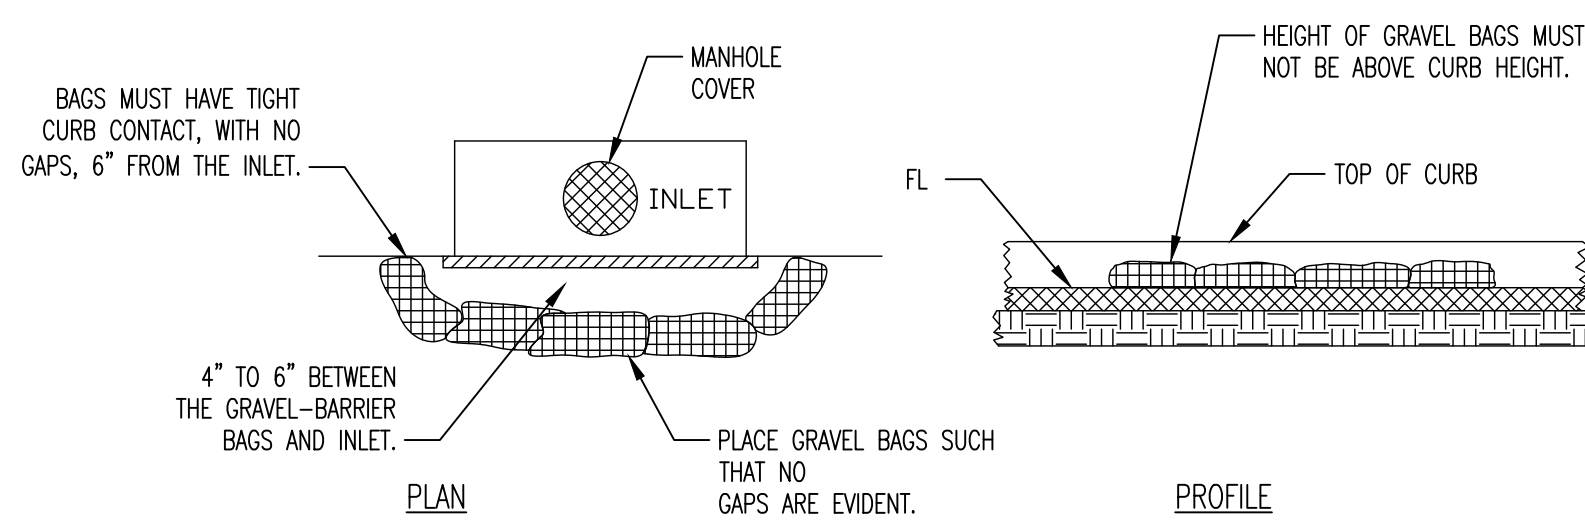


- NOTES:**
- GRAVEL BAGS SHALL CONTAIN 1" TO 2" DIAMETER ROCK CONTAINED IN PERVIOUS BURLAP BAGS OR SYNTHETIC NET BAGS ABOUT 24" LONG, 12" WIDE, AND 6" HIGH.


5 DRAIN INLET BARRIER
NOT TO SCALE

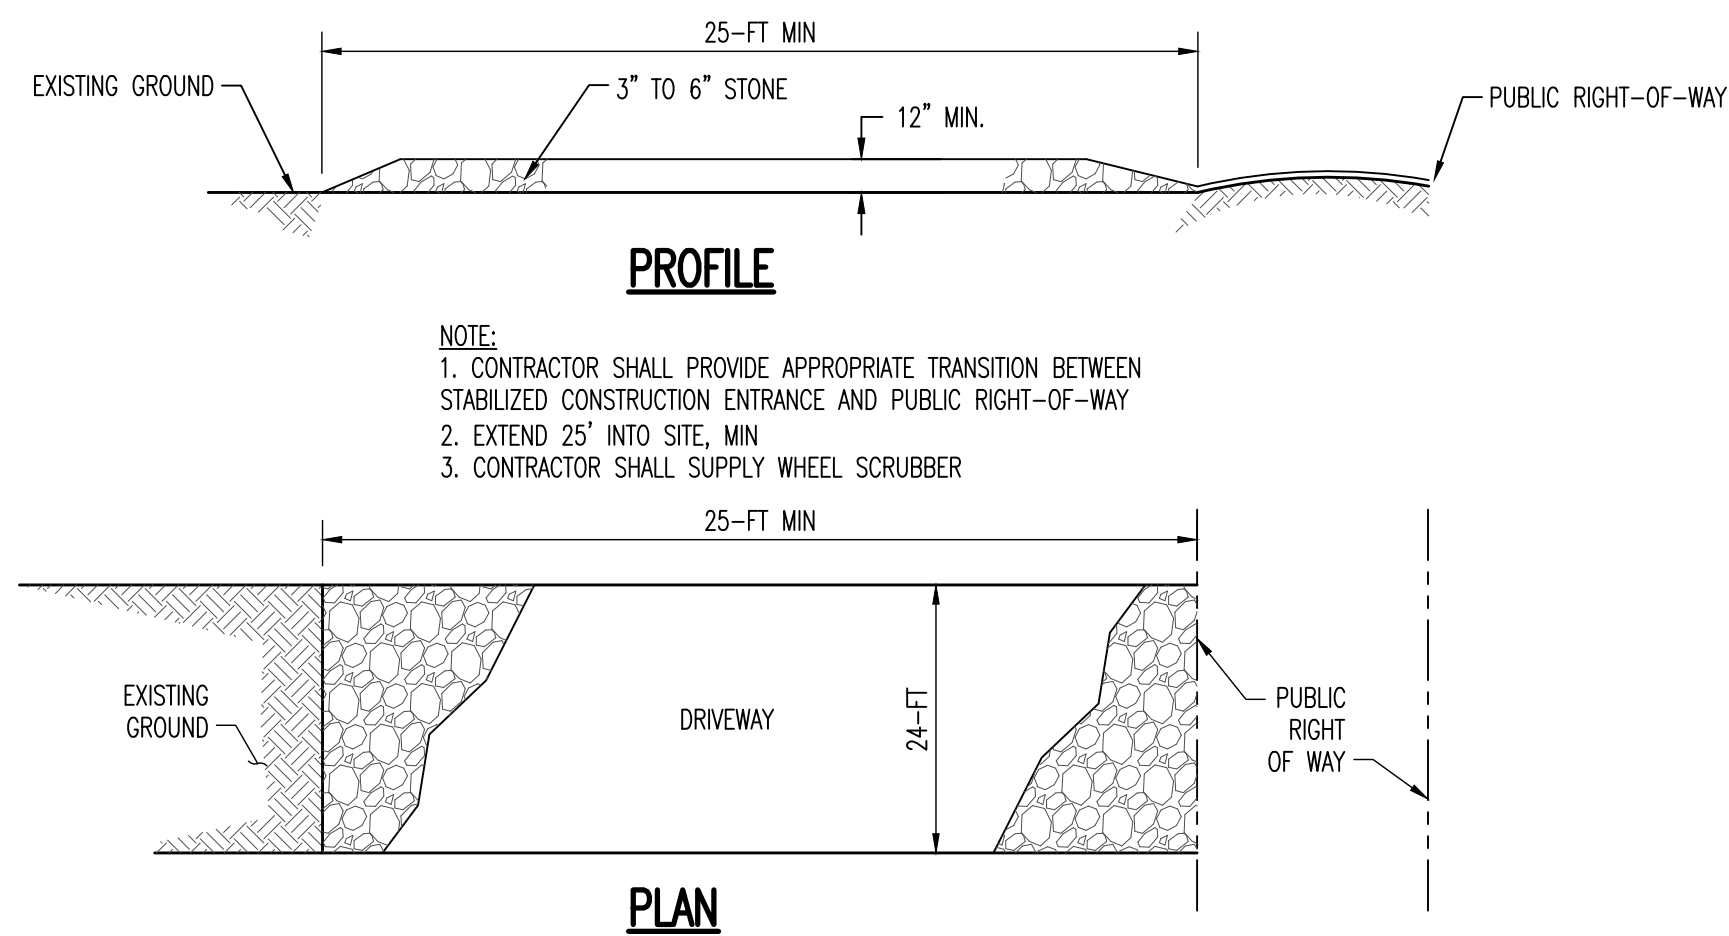

6 STABILIZED CONSTRUCTION ENTRANCE
NOT TO SCALE

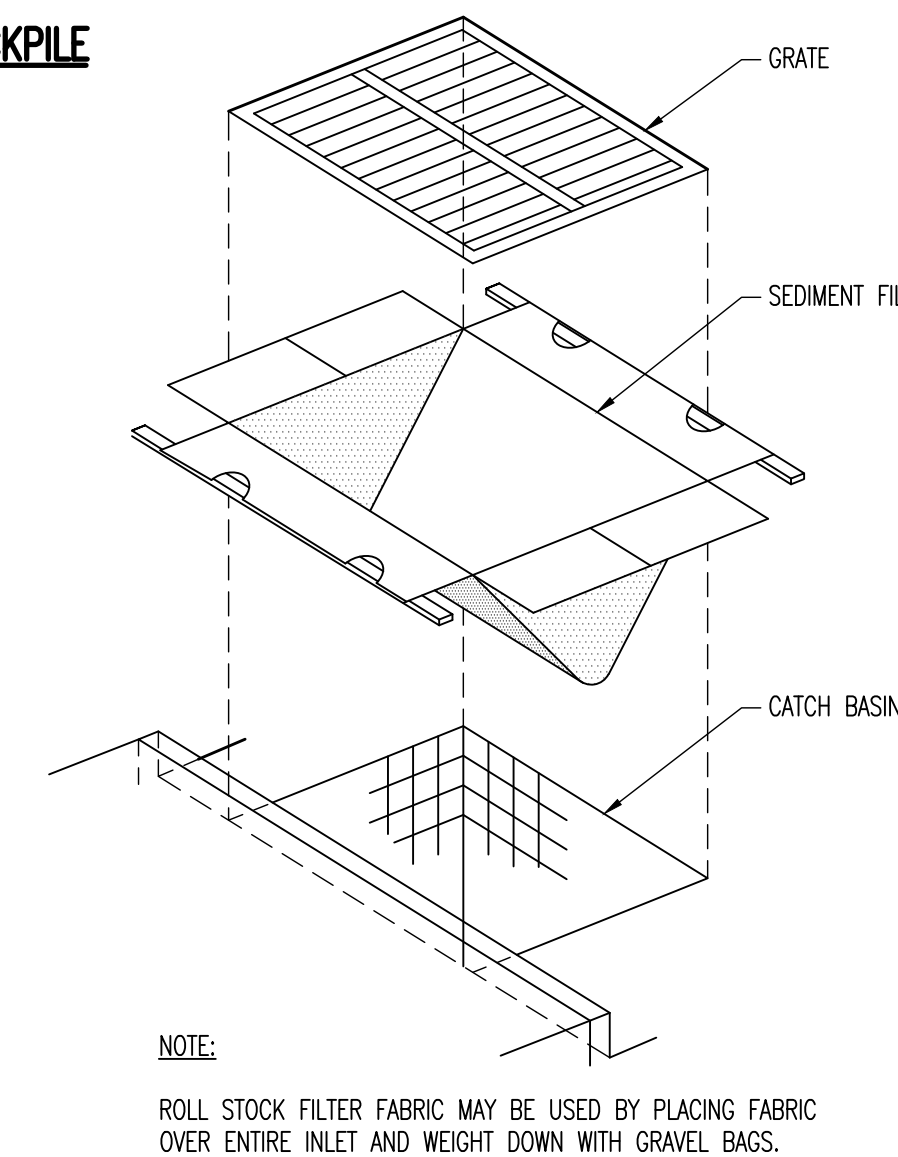


7 INLET FILTER DETAIL
NOT TO SCALE

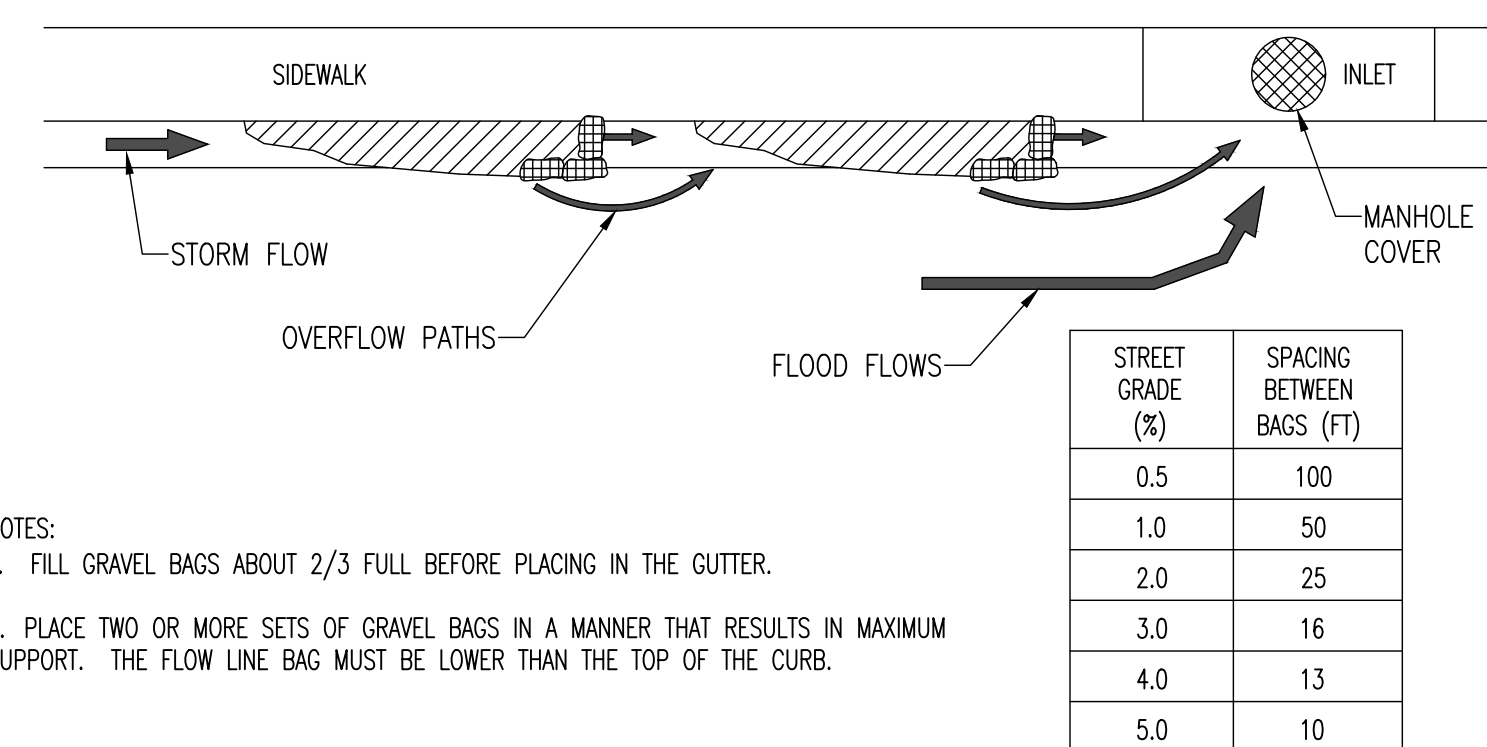


- NOTES:**
- FILL GRAVEL BAGS ABOUT 2/3 FULL BEFORE PLACING IN THE GUTTER.
 - PLACE TWO OR MORE SETS OF GRAVEL BAGS IN A MANNER THAT RESULTS IN MAXIMUM SUPPORT. THE FLOW LINE BAG MUST BE LOWER THAN THE TOP OF THE CURB.

8 CURB AND GUTTER CONTAINMENT
NOT TO SCALE

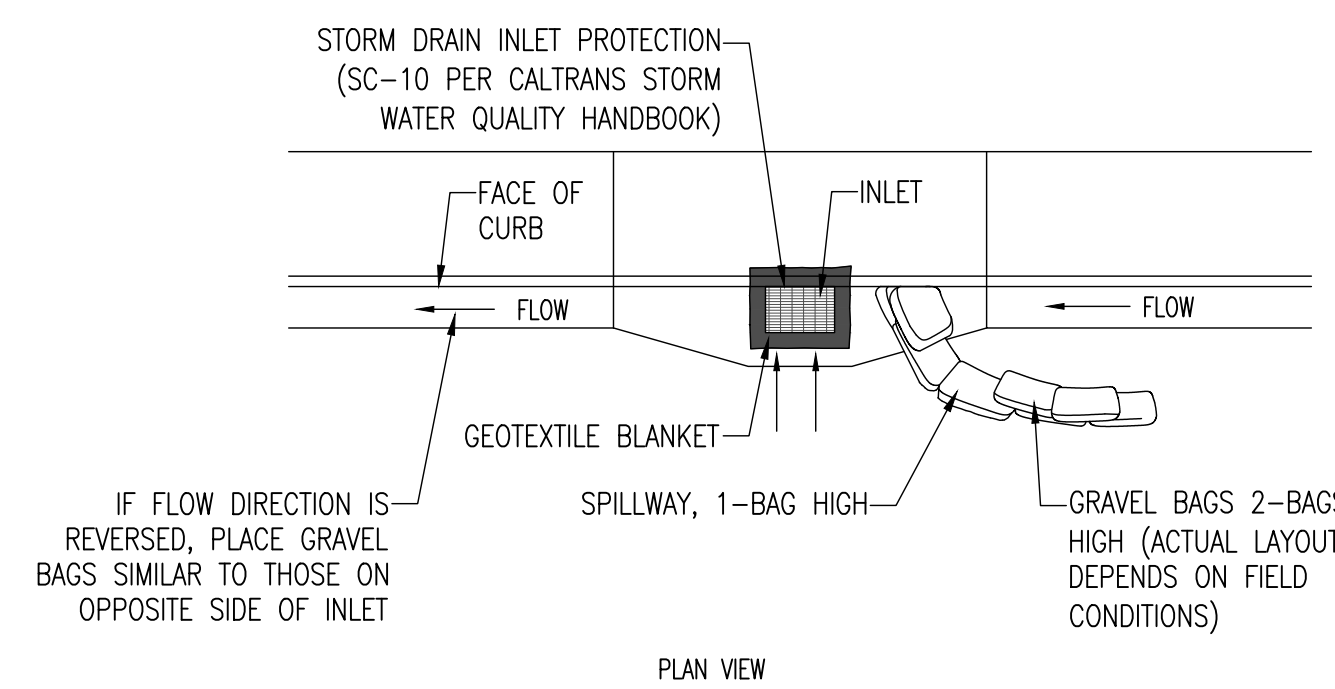

9 STORM DRAIN INLET PROTECTION
NOT TO SCALE

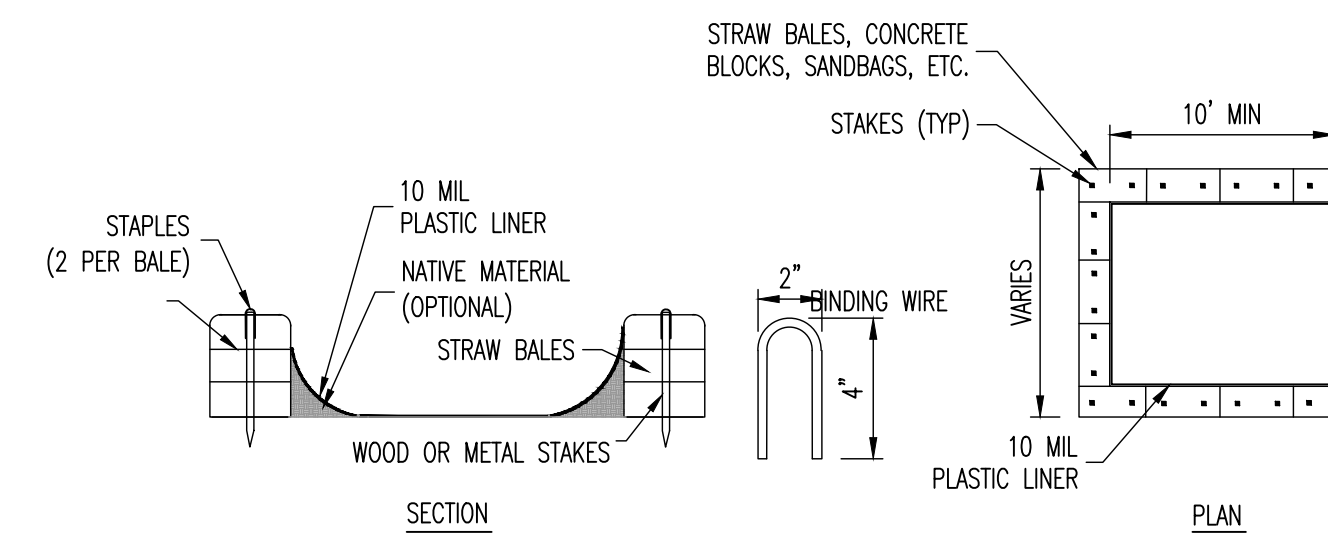

- NOTES:**
- ACTUAL LAYOUT DETERMINED IN FIELD
 - THE CONCRETE WASHOUT SIGN SHALL BE INSTALLED WITHIN 30 FT. OF THE TEMPORARY CONCRETE WASHOUT FACILITY

10 CONCRETE WASHOUT
NOT TO SCALE

SYMBOL	DESCRIPTION	DATE	APPROVED
B	NEW SITE PLAN	03-03-24	IK
A	FOR REVIEW	02-21-23	IK



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EROSION CONTROL DETAILS


DATE: FEBRUARY 2023
SCALE: AS SHOWN
DESIGN: IK
DRAWN: IK
PROJECT#: 23001
SHEET: 11 OF 15

C3.1

Construction Best Management Practices (BMPs)

Construction projects are required to implement the stormwater best management practices (BMP) on this page, as they apply to your project, all year long.

Materials & Waste Management

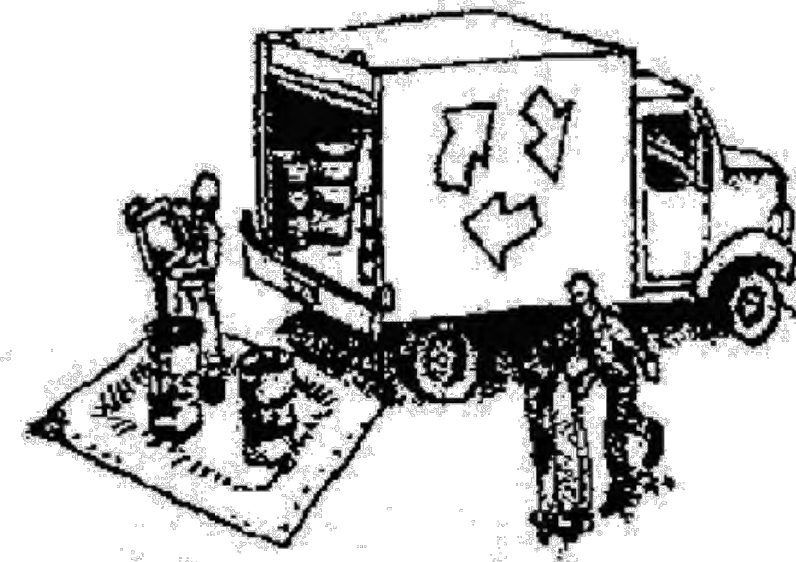

Non-Hazardous Materials

- Berm and cover stockpiles of sand, dirt or other construction material with tarps when rain is forecast or if not actively being used within 14 days.
- Use (but don't overuse) reclaimed water for dust control.

Hazardous Materials

- Label all hazardous materials and hazardous wastes (such as pesticides, paints, thinners, solvents, fuel, oil, and antifreeze) in accordance with city, county, state and federal regulations.
- Store hazardous materials and wastes in water tight containers, store in appropriate secondary containment, and cover them at the end of every work day or during wet weather or when rain is forecast.
- Follow manufacturer's application instructions for hazardous materials and be careful not to use more than necessary. Do not apply chemicals outdoors when rain is forecast within 24 hours.
- Arrange for appropriate disposal of all hazardous wastes.

Waste Management

- Cover waste disposal containers securely with tarps at the end of every work day and during wet weather.
- Check waste disposal containers frequently for leaks and to make sure they are not overfilled. Never hose down a dumpster on the construction site.
- Clean or replace portable toilets, and inspect them frequently for leaks and spills.
- Dispose of all wastes and debris properly. Recycle materials and wastes that can be recycled (such as asphalt, concrete, aggregate base materials, wood, gyp board, pipe, etc.)
- Dispose of liquid residues from paints, thinners, solvents, glues, and cleaning fluids as hazardous waste.

Construction Entrances and Perimeter

- Establish and maintain effective perimeter controls and stabilize all construction entrances and exits to sufficiently control erosion and sediment discharges from site and tracking off site.
- Sweep or vacuum any street tracking immediately and secure sediment source to prevent further tracking. Never hose down streets to clean up tracking.

Equipment Management & Spill Control




Maintenance and Parking

- Designate an area, fitted with appropriate BMPs, for vehicle and equipment parking and storage.
- Perform major maintenance, repair jobs, and vehicle and equipment washing off site.
- If refueling or vehicle maintenance must be done onsite, work in a bermed area away from storm drains and over a drip pan or drop cloths big enough to collect fluids. Recycle or dispose of fluids as hazardous waste.
- If vehicle or equipment cleaning must be done onsite, clean with water only in a bermed area that will not allow rinse water to run into gutters, streets, storm drains, or surface waters.
- Do not clean vehicle or equipment onsite using soaps, solvents, degreasers, or steam cleaning equipment.

Spill Prevention and Control

- Keep spill cleanup materials (e.g., rags, absorbents and cat litter) available at the construction site at all times.
- Inspect vehicles and equipment frequently for and repair leaks promptly. Use drip pans to catch leaks until repairs are made.
- Clean up spills or leaks immediately and dispose of cleanup materials properly.
- Do not hose down surfaces where fluids have spilled. Use dry cleanup methods (absorbent materials, cat litter, and/or rags).
- Sweep up spilled dry materials immediately. Do not try to wash them away with water, or bury them.
- Clean up spills on dirt areas by digging up and properly disposing of contaminated soil.
- Report significant spills immediately. You are required by law to report all significant releases of hazardous materials, including oil. To report a spill: 1) Dial 911 or your local emergency response number, 2) Call the Governor's Office of Emergency Services Warning Center, (800) 852-7550 (24 hours).

Earthmoving

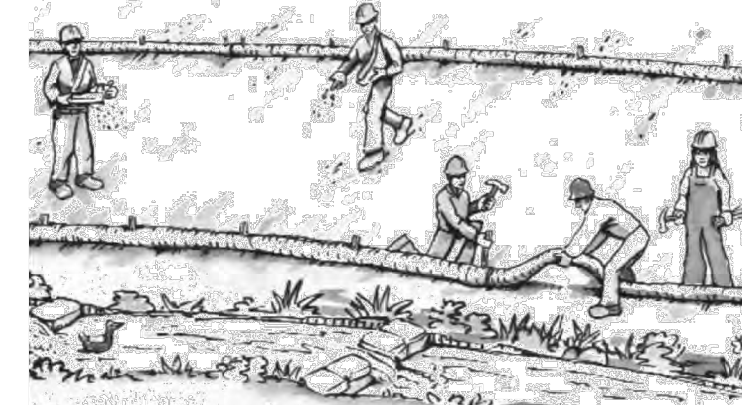

- Schedule grading and excavation work during dry weather.
- Stabilize all denuded areas, install and maintain temporary erosion controls (such as erosion control fabric or bonded fiber matrix) until vegetation is established.
- Remove existing vegetation only when absolutely necessary, and seed or plant vegetation for erosion control on slopes or where construction is not immediately planned.
- Prevent sediment from migrating offsite and protect storm drain inlets, gutters, ditches, and drainage courses by installing and maintaining appropriate BMPs, such as fiber rolls, silt fences, sediment basins, gravel bags, berms, etc.
- Keep excavated soil on site and transfer it to dump trucks on site, not in the streets.

Contaminated Soils

- If any of the following conditions are observed, test for contamination and contact the Regional Water Quality Control Board:
 - Unusual soil conditions, discoloration, or odor.
 - Abandoned underground tanks.
 - Abandoned wells
 - Buried barrels, debris, or trash.

Paving/Asphalt Work



- Avoid paving and seal coating in wet weather or when rain is forecast, to prevent materials that have not cured from contacting stormwater runoff.
- Cover storm drain inlets and manholes when applying seal coat, tack coat, slurry seal, fog seal, etc.
- Collect and recycle or appropriately dispose of excess abrasive gravel or sand. Do NOT sweep or wash it into gutters.
- Do not use water to wash down fresh asphalt concrete pavement.

Sawcutting & Asphalt/Concrete Removal

- Protect nearby storm drain inlets when saw cutting. Use filter fabric, catch basin inlet filters, or gravel bags to keep slurry out of the storm drain system.
- Shovel, absorb, or vacuum saw-cut slurry and dispose of all waste as soon as you are finished in one location or at the end of each work day (whichever is sooner!).
- If sawcut slurry enters a catch basin, clean it up immediately.

Concrete, Grout & Mortar Application




- Store concrete, grout, and mortar away from storm drains or waterways, and on pallets under cover to protect them from rain, runoff, and wind.
- Wash out concrete equipment/trucks offsite or in a designated washout area, where the water will flow into a temporary waste pit, and in a manner that will prevent leaching into the underlying soil or onto surrounding areas. Let concrete harden and dispose of as garbage.
- When washing exposed aggregate, prevent washwater from entering storm drains. Block any inlets and vacuum gutters, hose washwater onto dirt areas, or drain onto a bermed surface to be pumped and disposed of properly.

Landscaping



- Protect stockpiled landscaping materials from wind and rain by storing them under tarps all year-round.
- Stack bagged material on pallets and under cover.
- Discontinue application of any erodible landscape material within 2 days before a forecast rain event or during wet weather.


Painting & Paint Removal

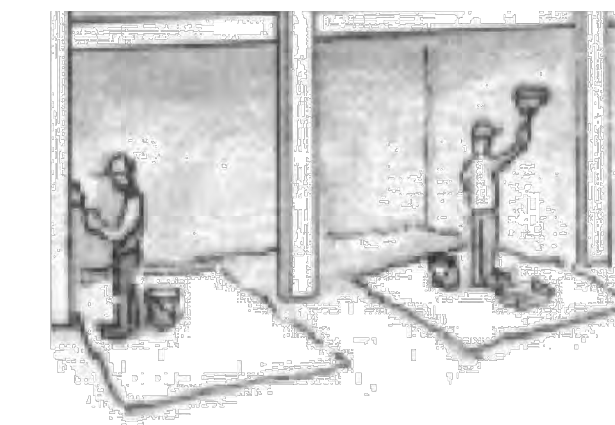

Painting Cleanup and Removal

- Never clean brushes or rinse paint containers into a street, gutter, storm drain, or stream.
- For water-based paints, paint out brushes to the extent possible, and rinse into a drain that goes to the sanitary sewer. Never pour paint down a storm drain.
- For oil-based paints, paint out brushes to the extent possible and clean with thinner or solvent in a proper container. Filter and reuse thinners and solvents. Dispose of excess liquids as hazardous waste.
- Paint chips and dust from non-hazardous dry stripping and sand blasting may be swept up or collected in plastic drop cloths and disposed of as trash.
- Chemical paint stripping residue and chips and dust from marine paints or paints containing lead, mercury, or tributyltin must be disposed of as hazardous waste. Lead based paint removal requires a state-certified contractor.

Dewatering

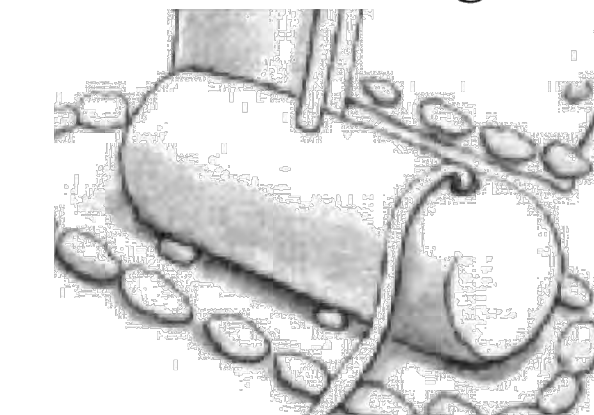

- Discharges of groundwater or captured runoff from dewatering operations must be properly managed and disposed. When possible send dewatering discharge to landscaped area or sanitary sewer. If discharging to the sanitary sewer call your local wastewater treatment plant.
- Divert run-on water from offsite away from all disturbed areas.
- When dewatering, notify and obtain approval from the local municipality before discharging water to a street gutter or storm drain. Filtration or diversion through a basin, tank, or sediment trap may be required.
- In areas of known or suspected contamination, call your local agency to determine whether the ground water must be tested. Pumped groundwater may need to be collected and hauled off-site for treatment and proper disposal.

Storm drain polluters may be liable for fines of up to \$10,000 per day!

SYMBOL	DESCRIPTION	DATE	APPROVED
B	NEW SITE PLAN	03-03-24	IK
A	FOR REVIEW	02-21-23	IK









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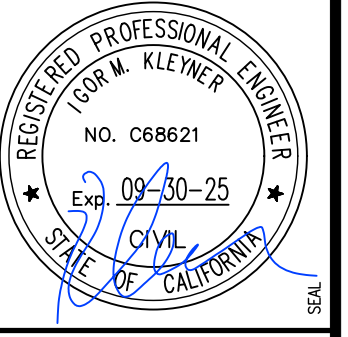
CONSTRUCTION BMP

DATE	FEBRUARY 2023
SCALE	AS SHOWN
DESIGN	IK
DRAWN	IK
PROJECT#	23001
SHEET	12 OF 15

C3.2



SYMBOL	DESCRIPTION	DATE	APPROVED
B	NEW SITE PLAN	03-03-24	IK
A	FOR REVIEW	02-21-23	IK

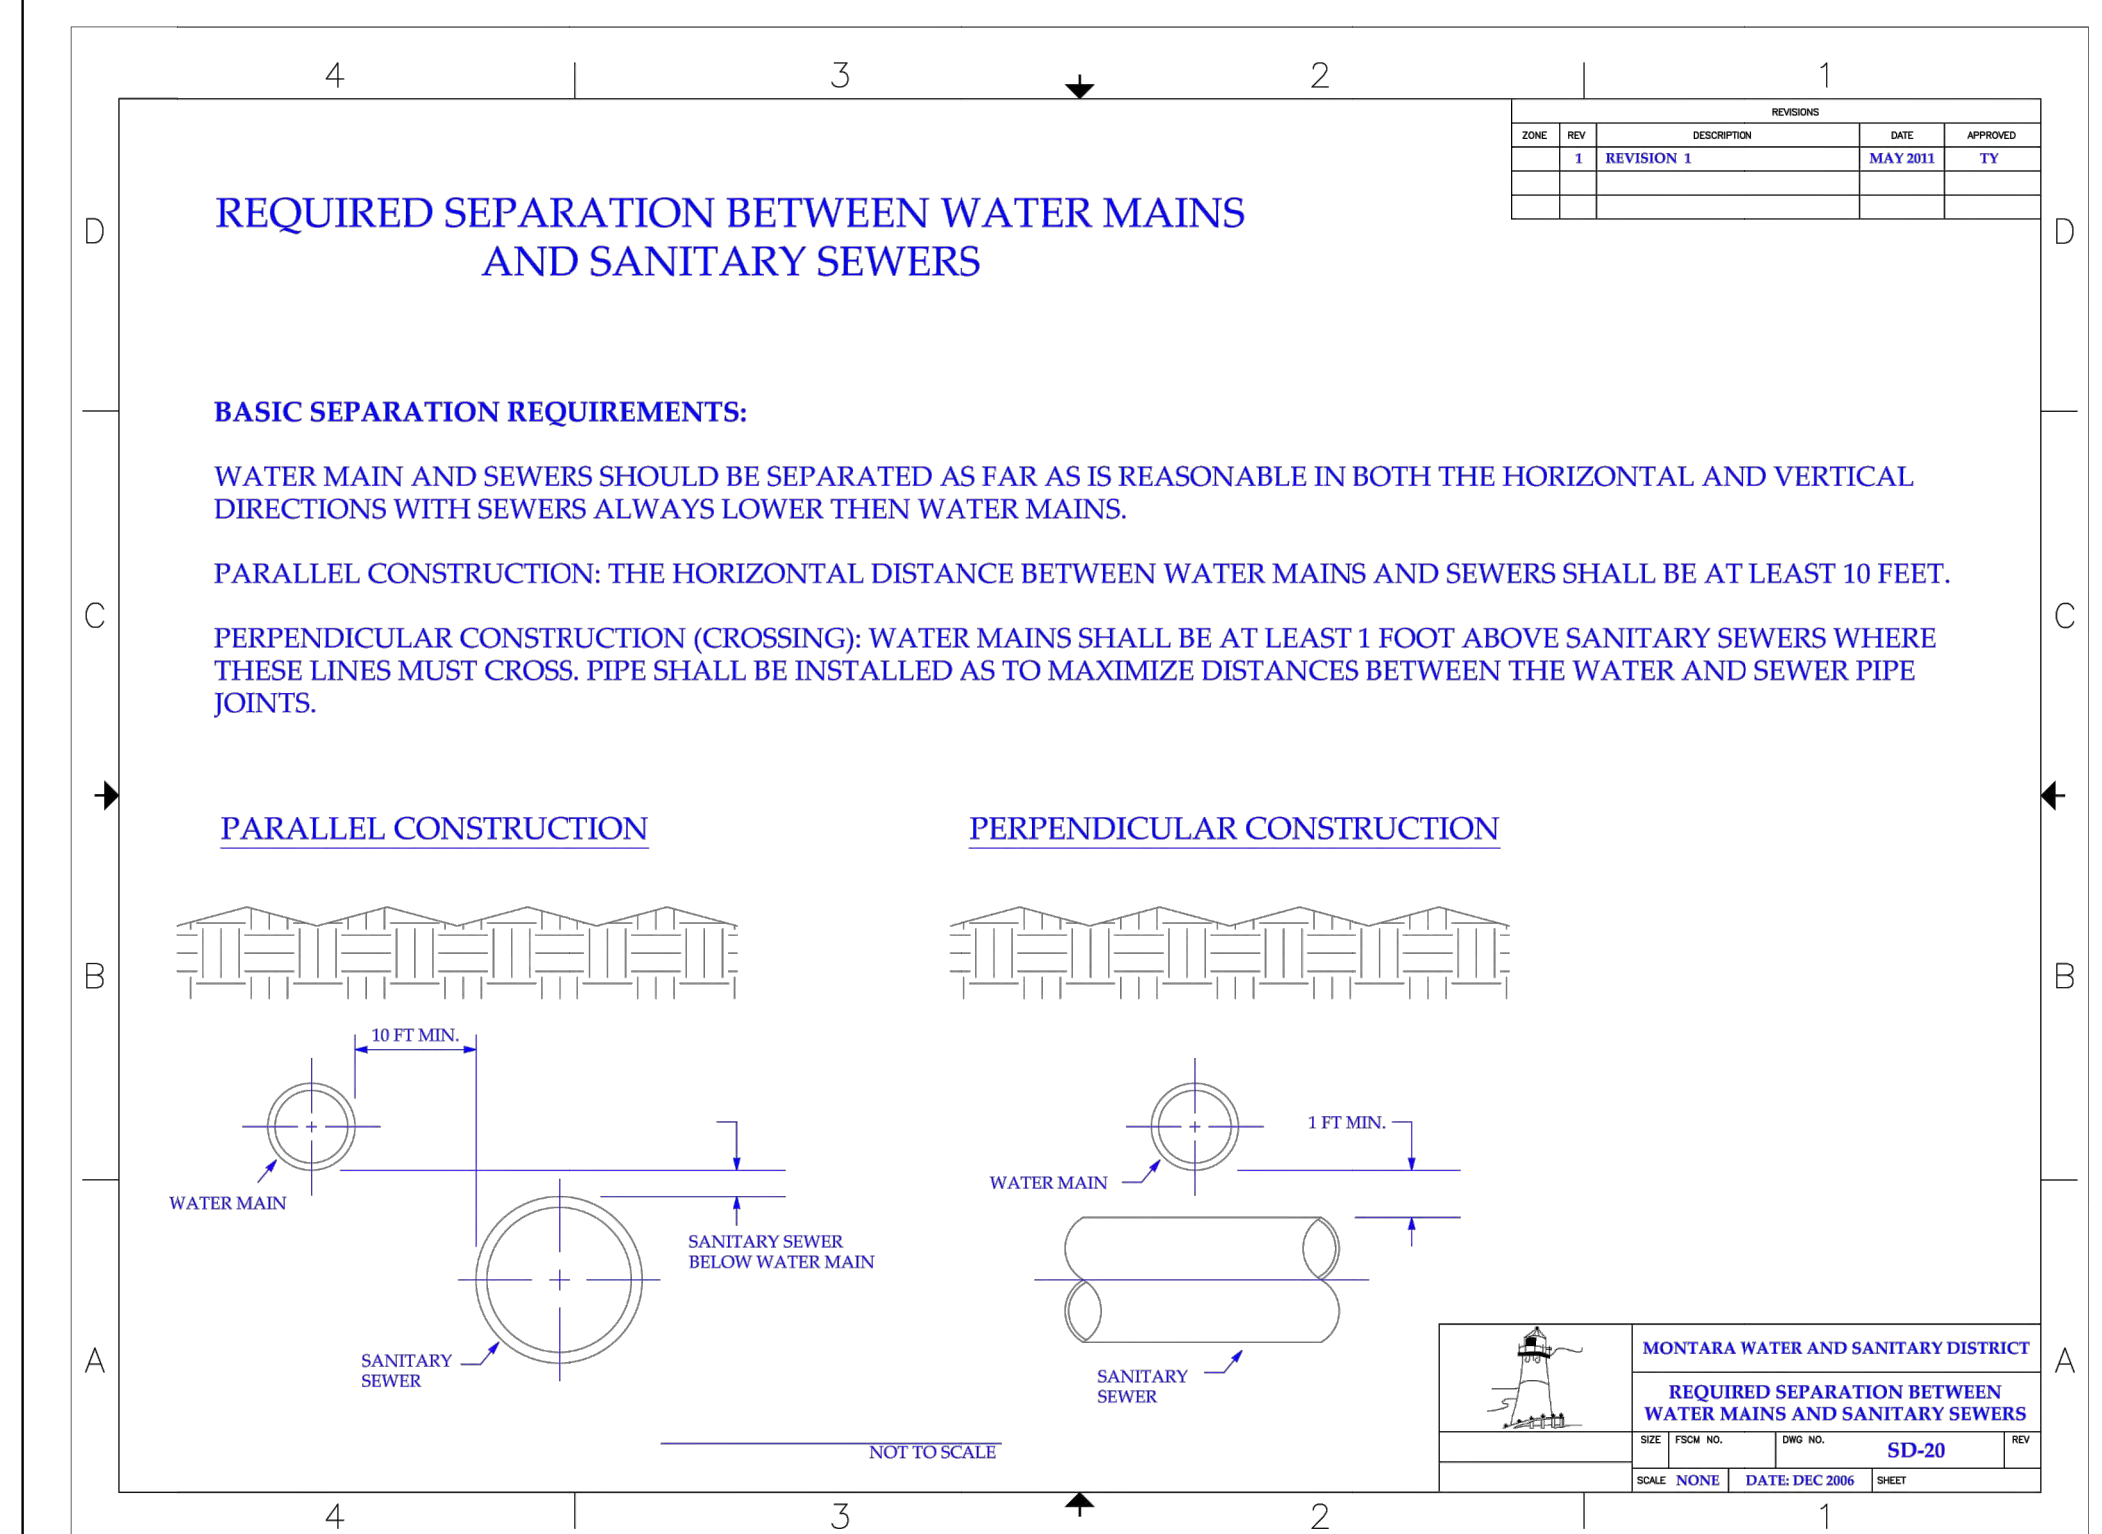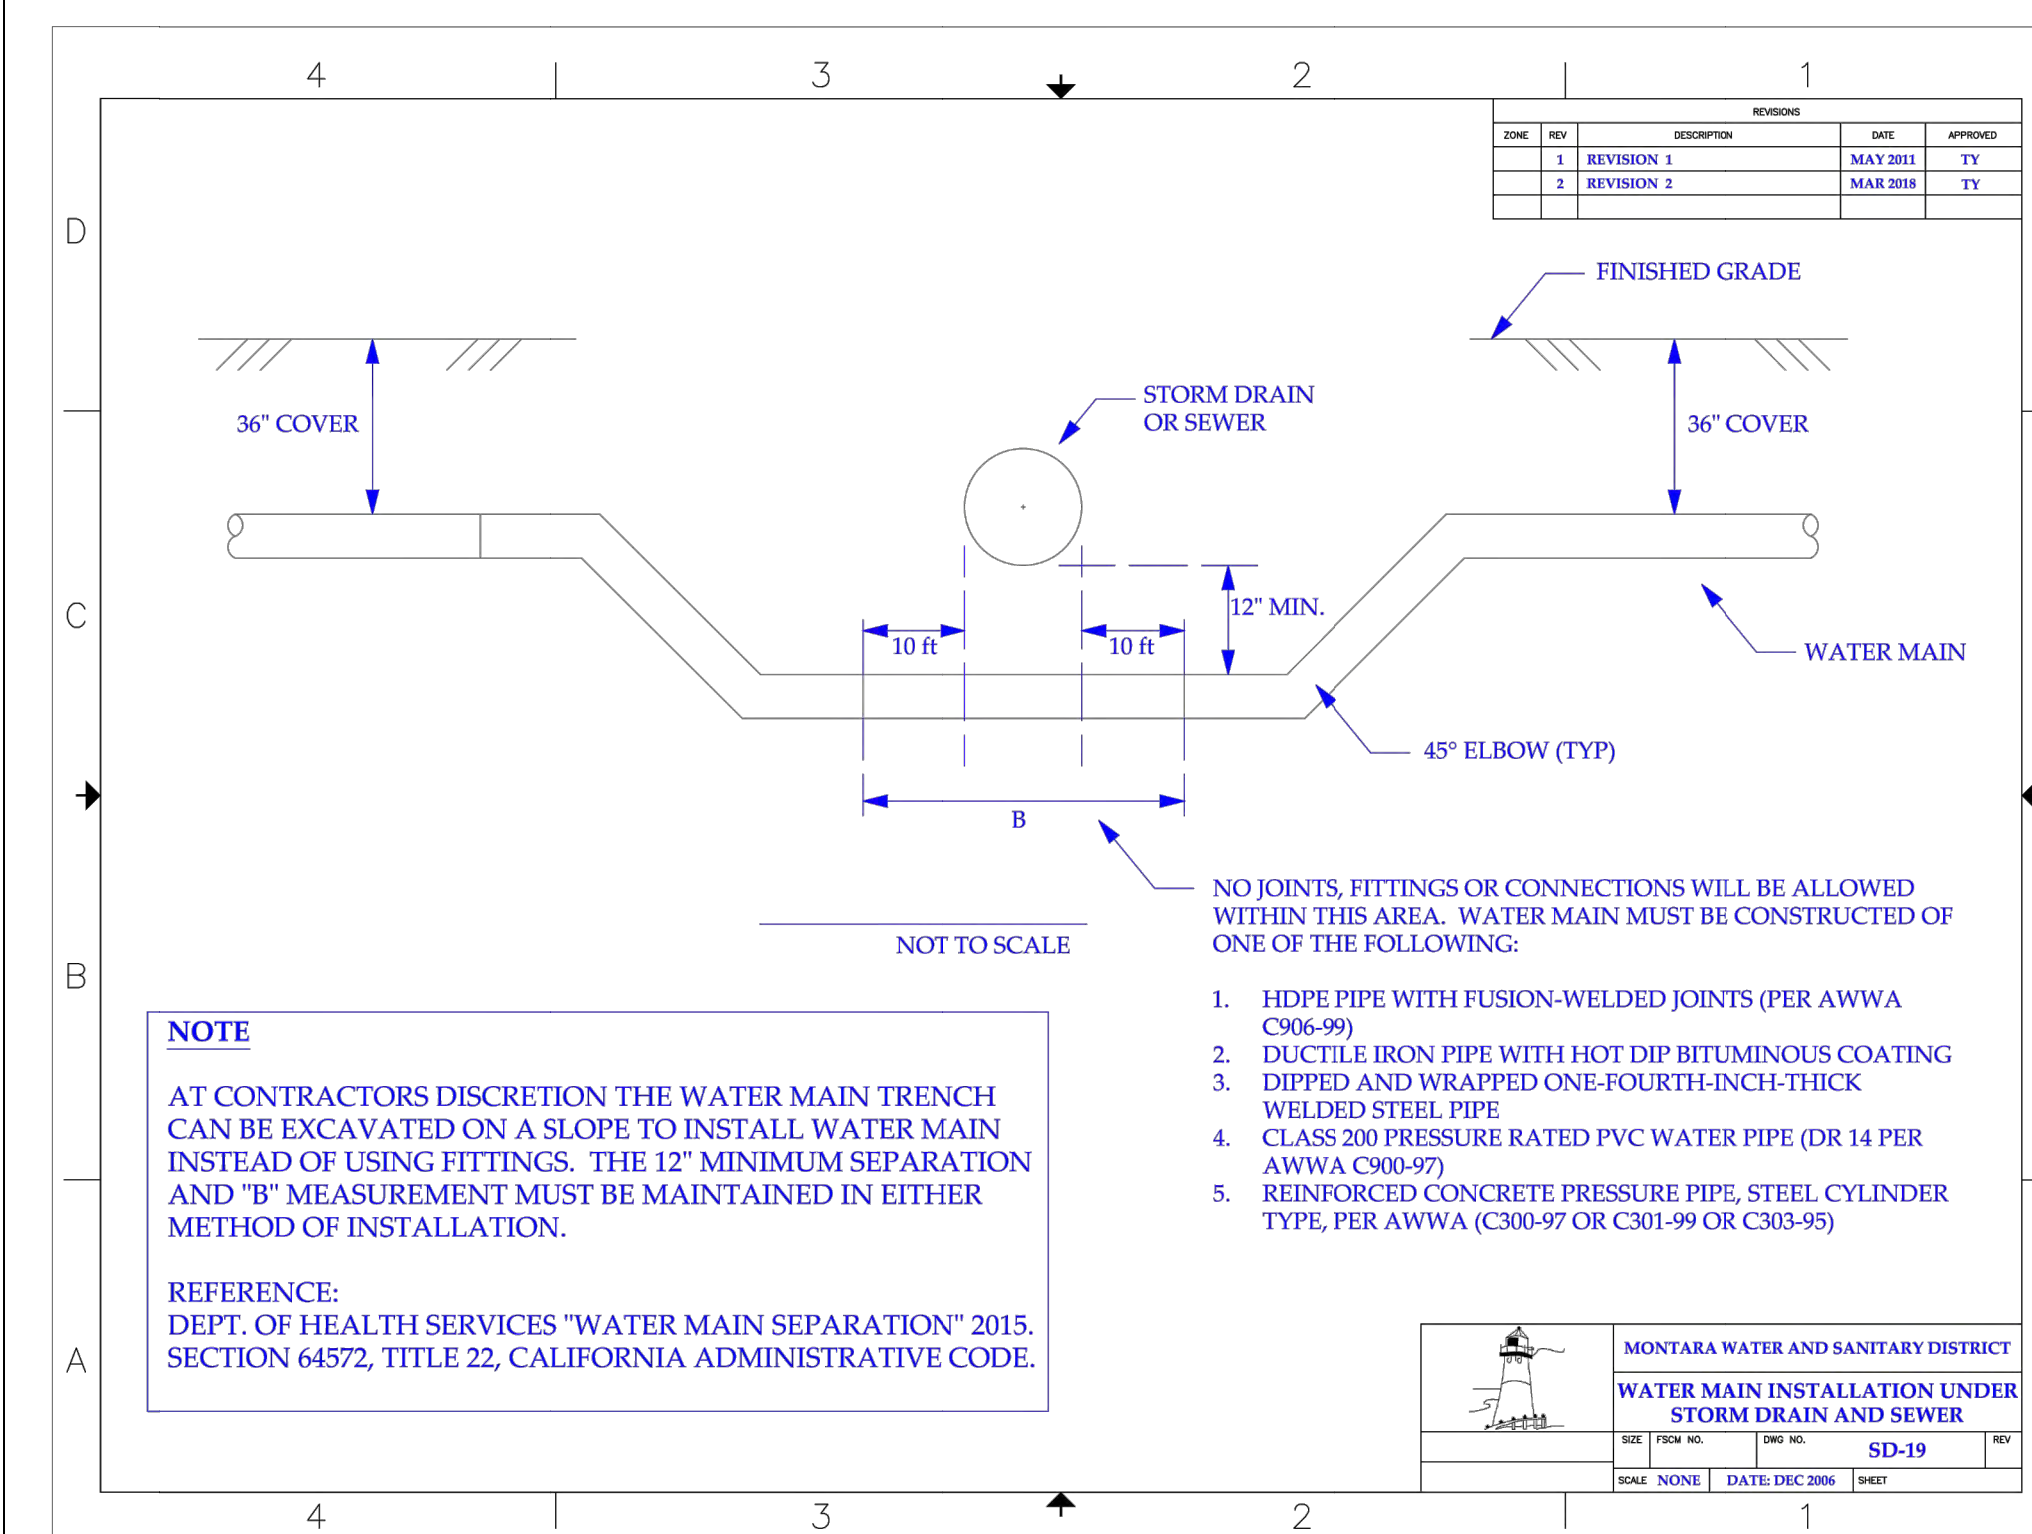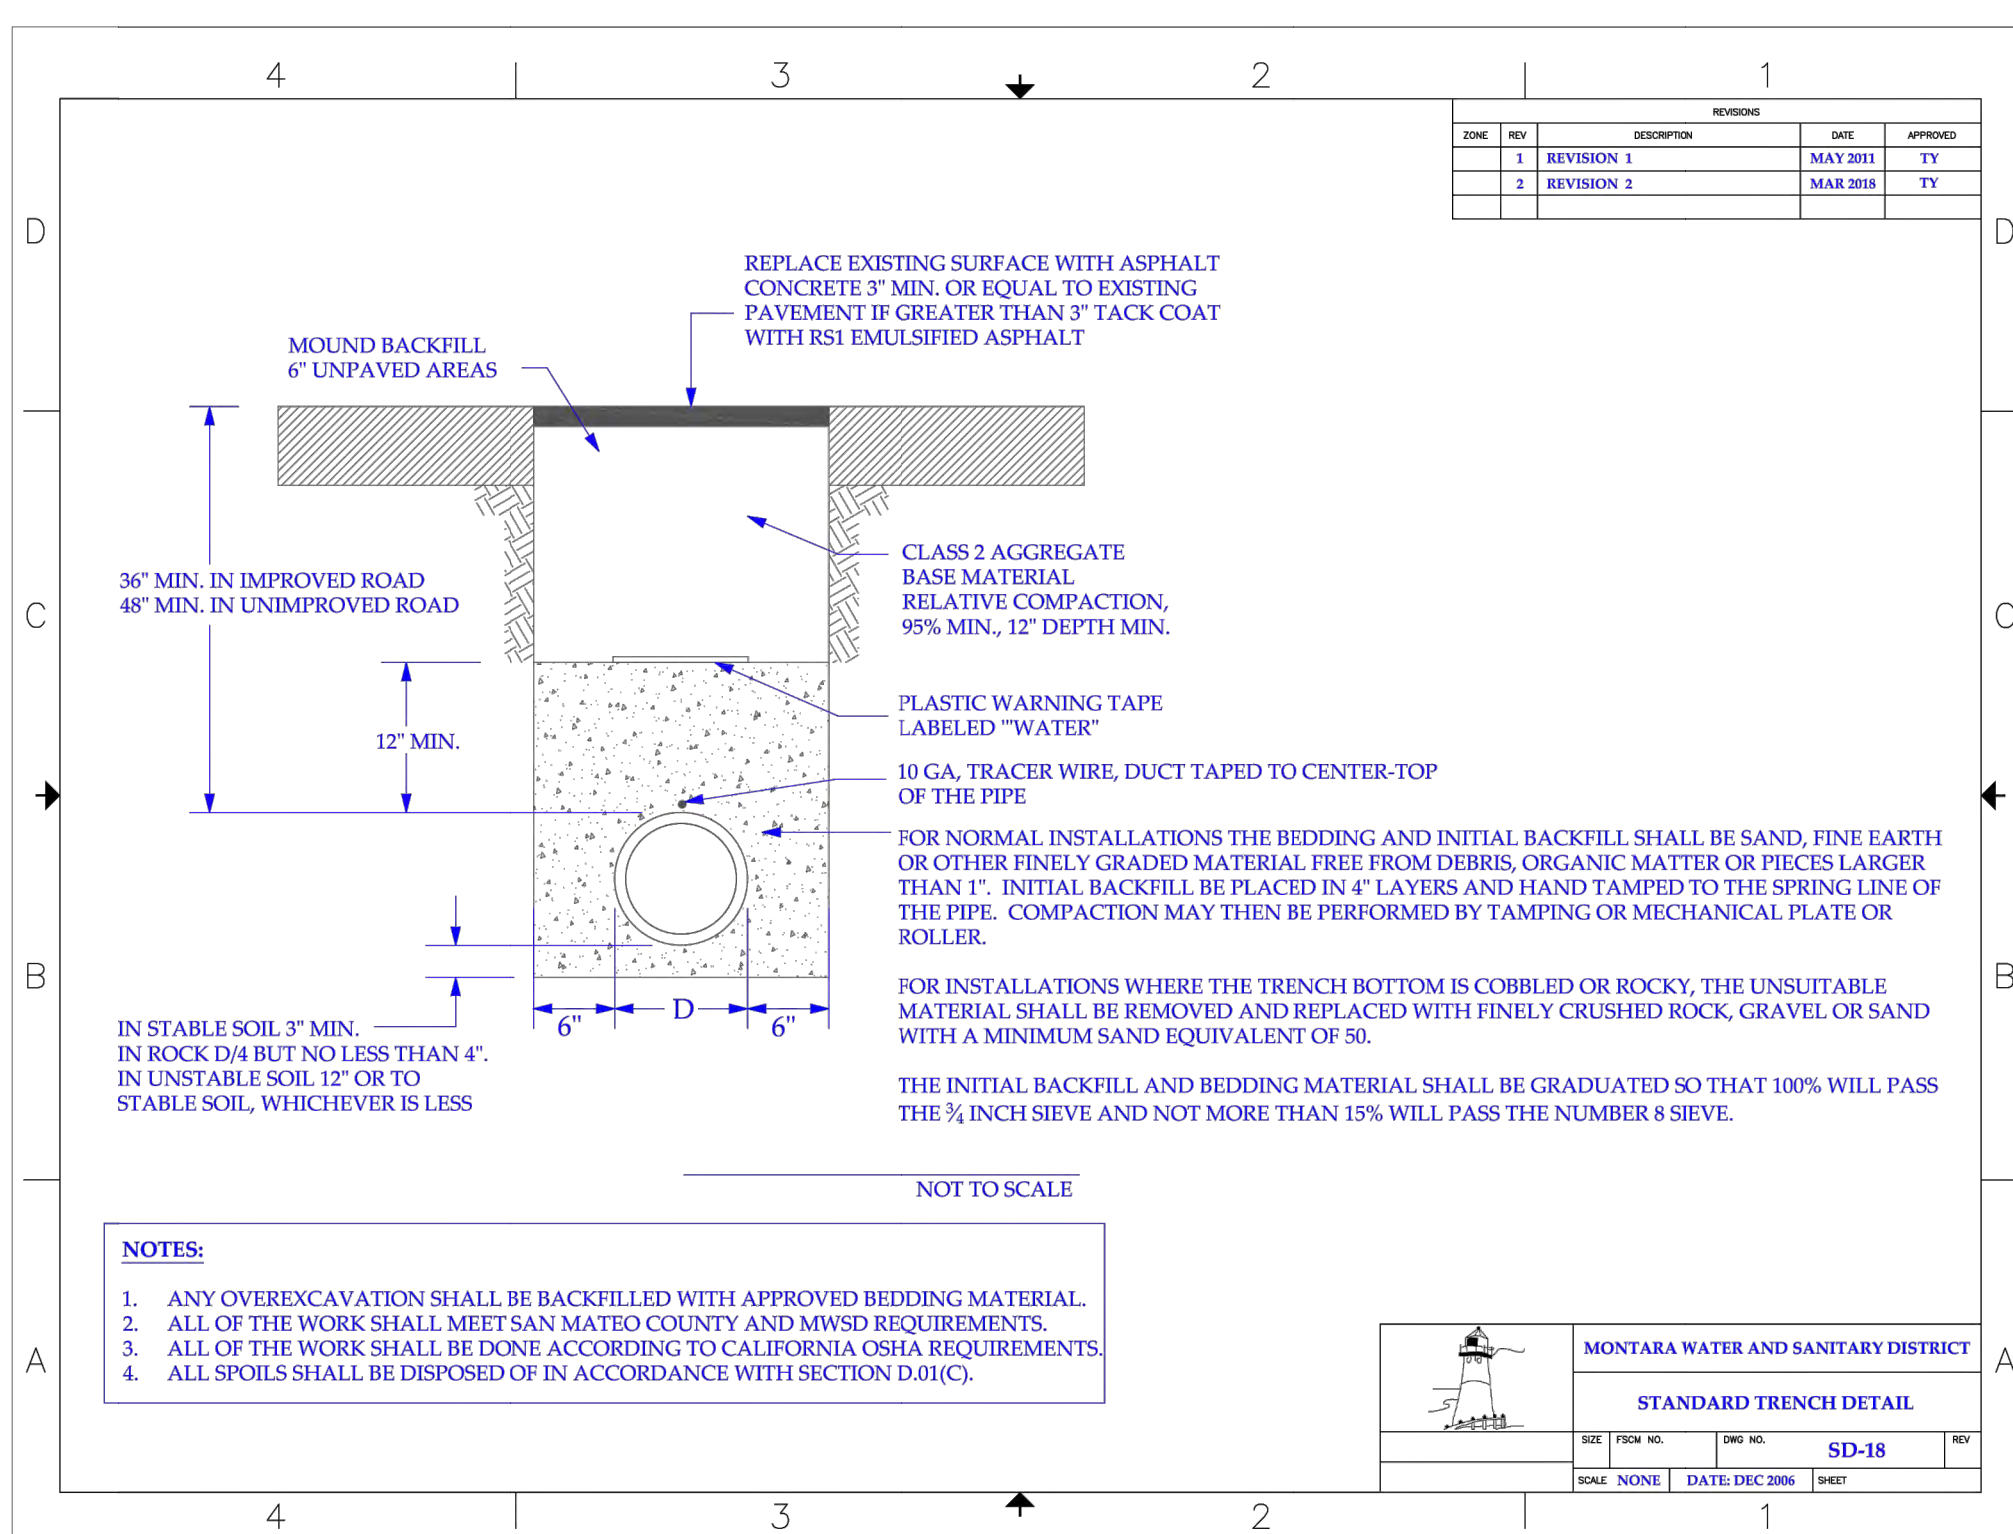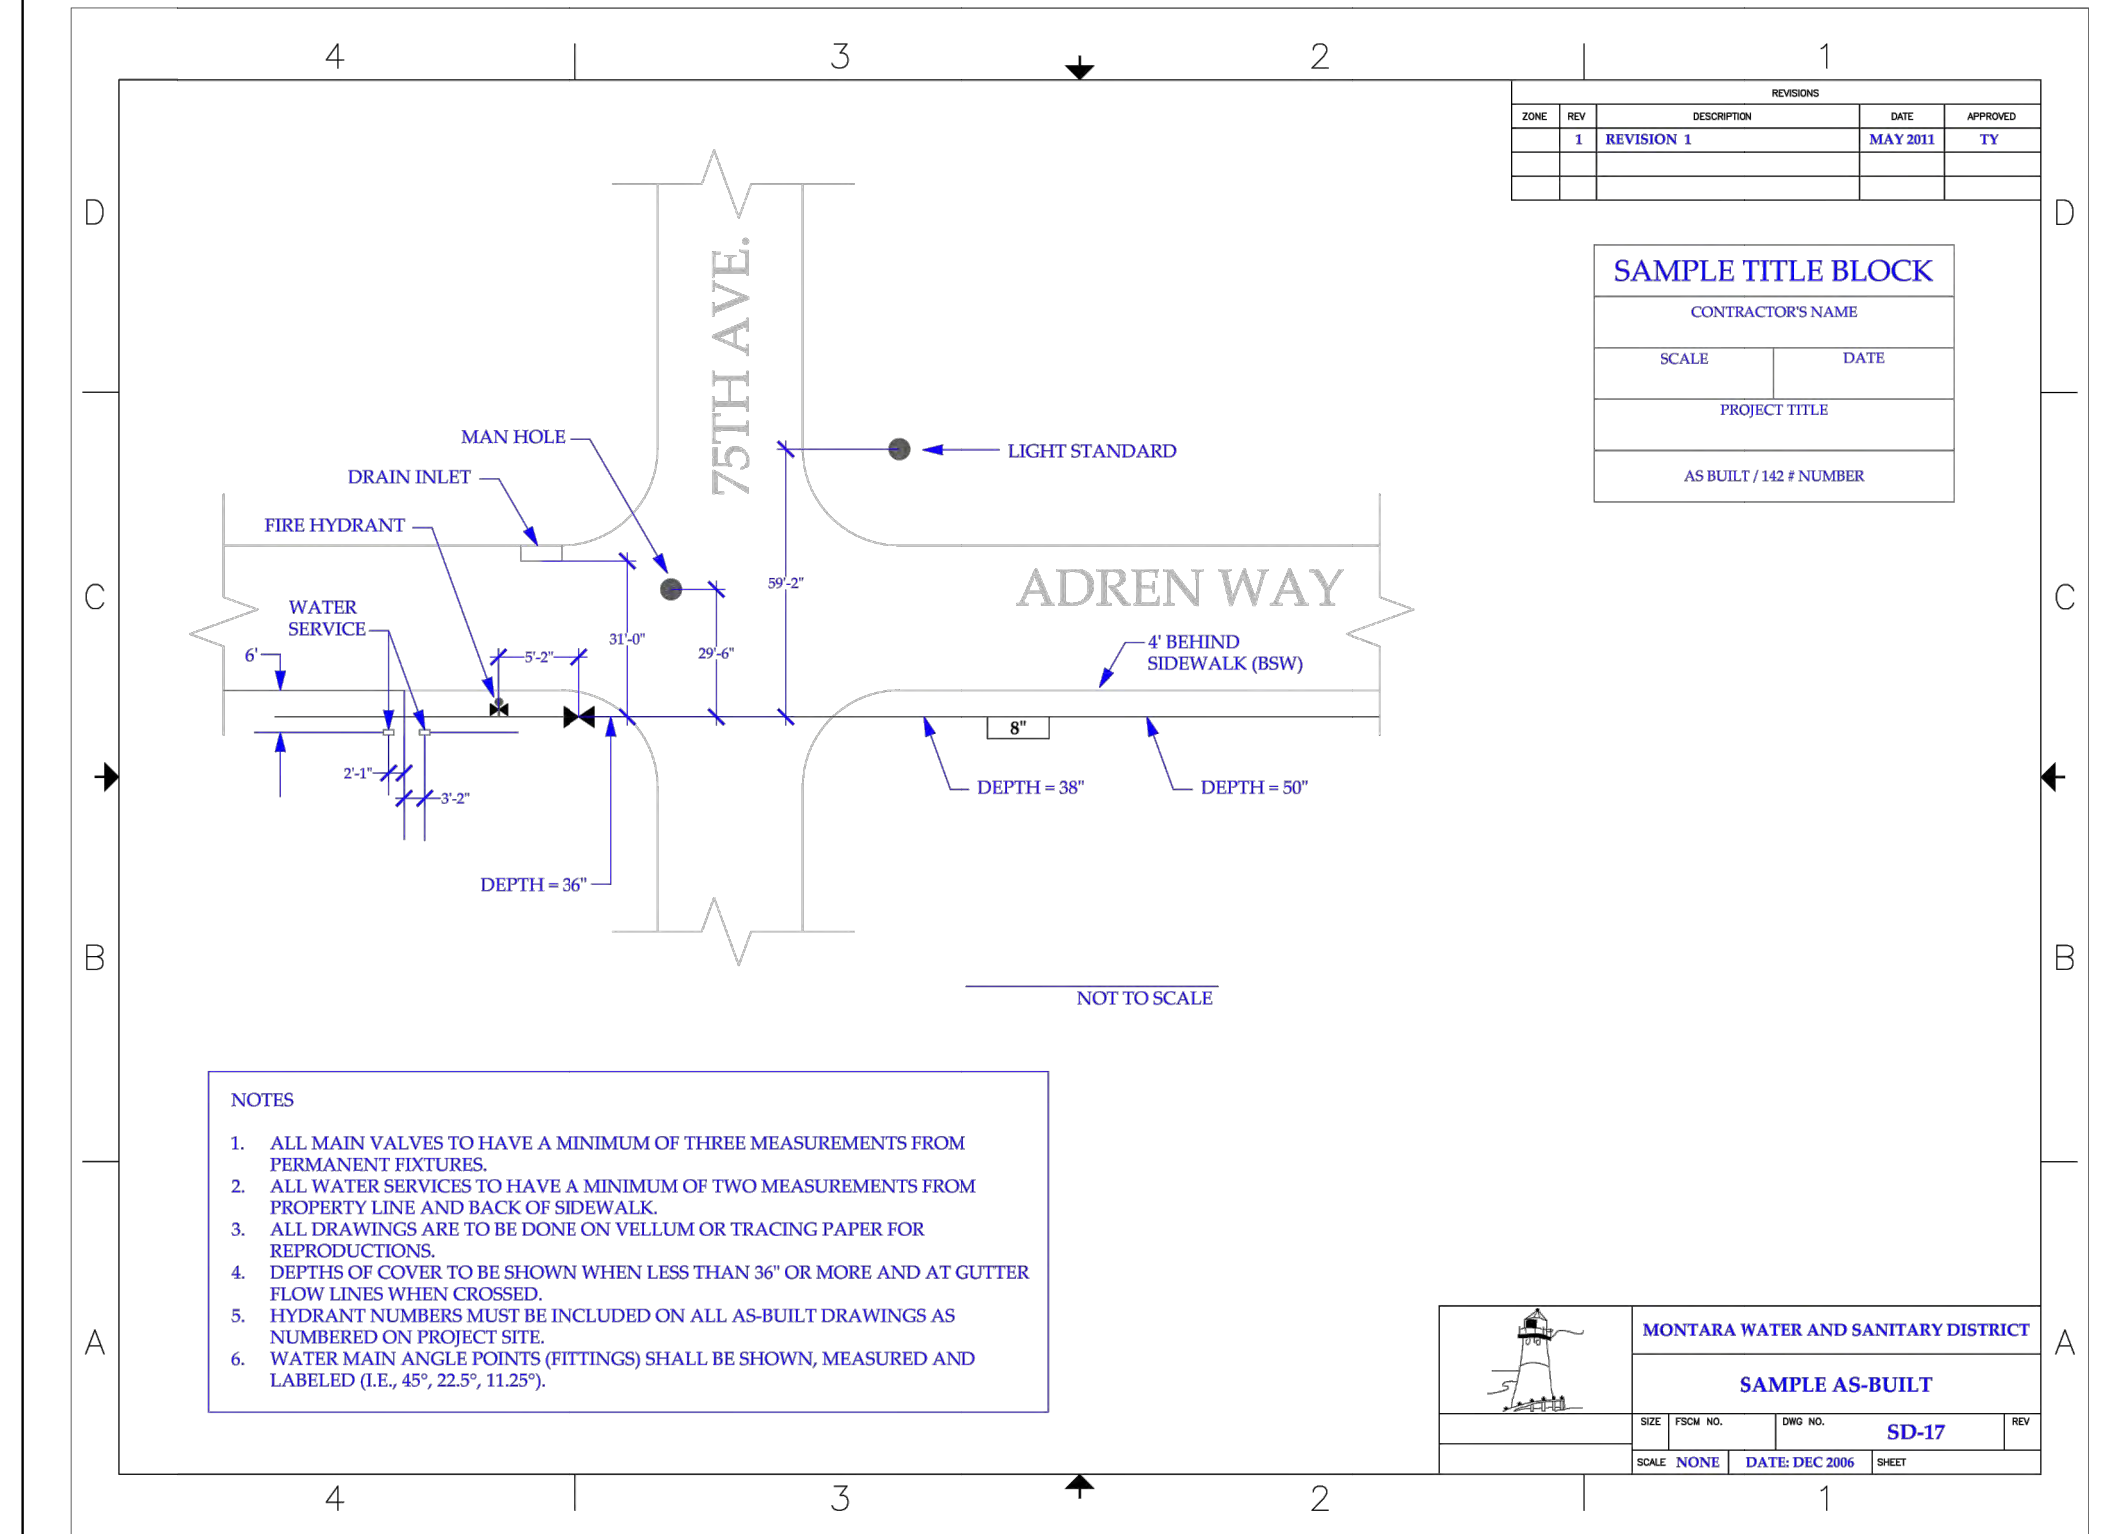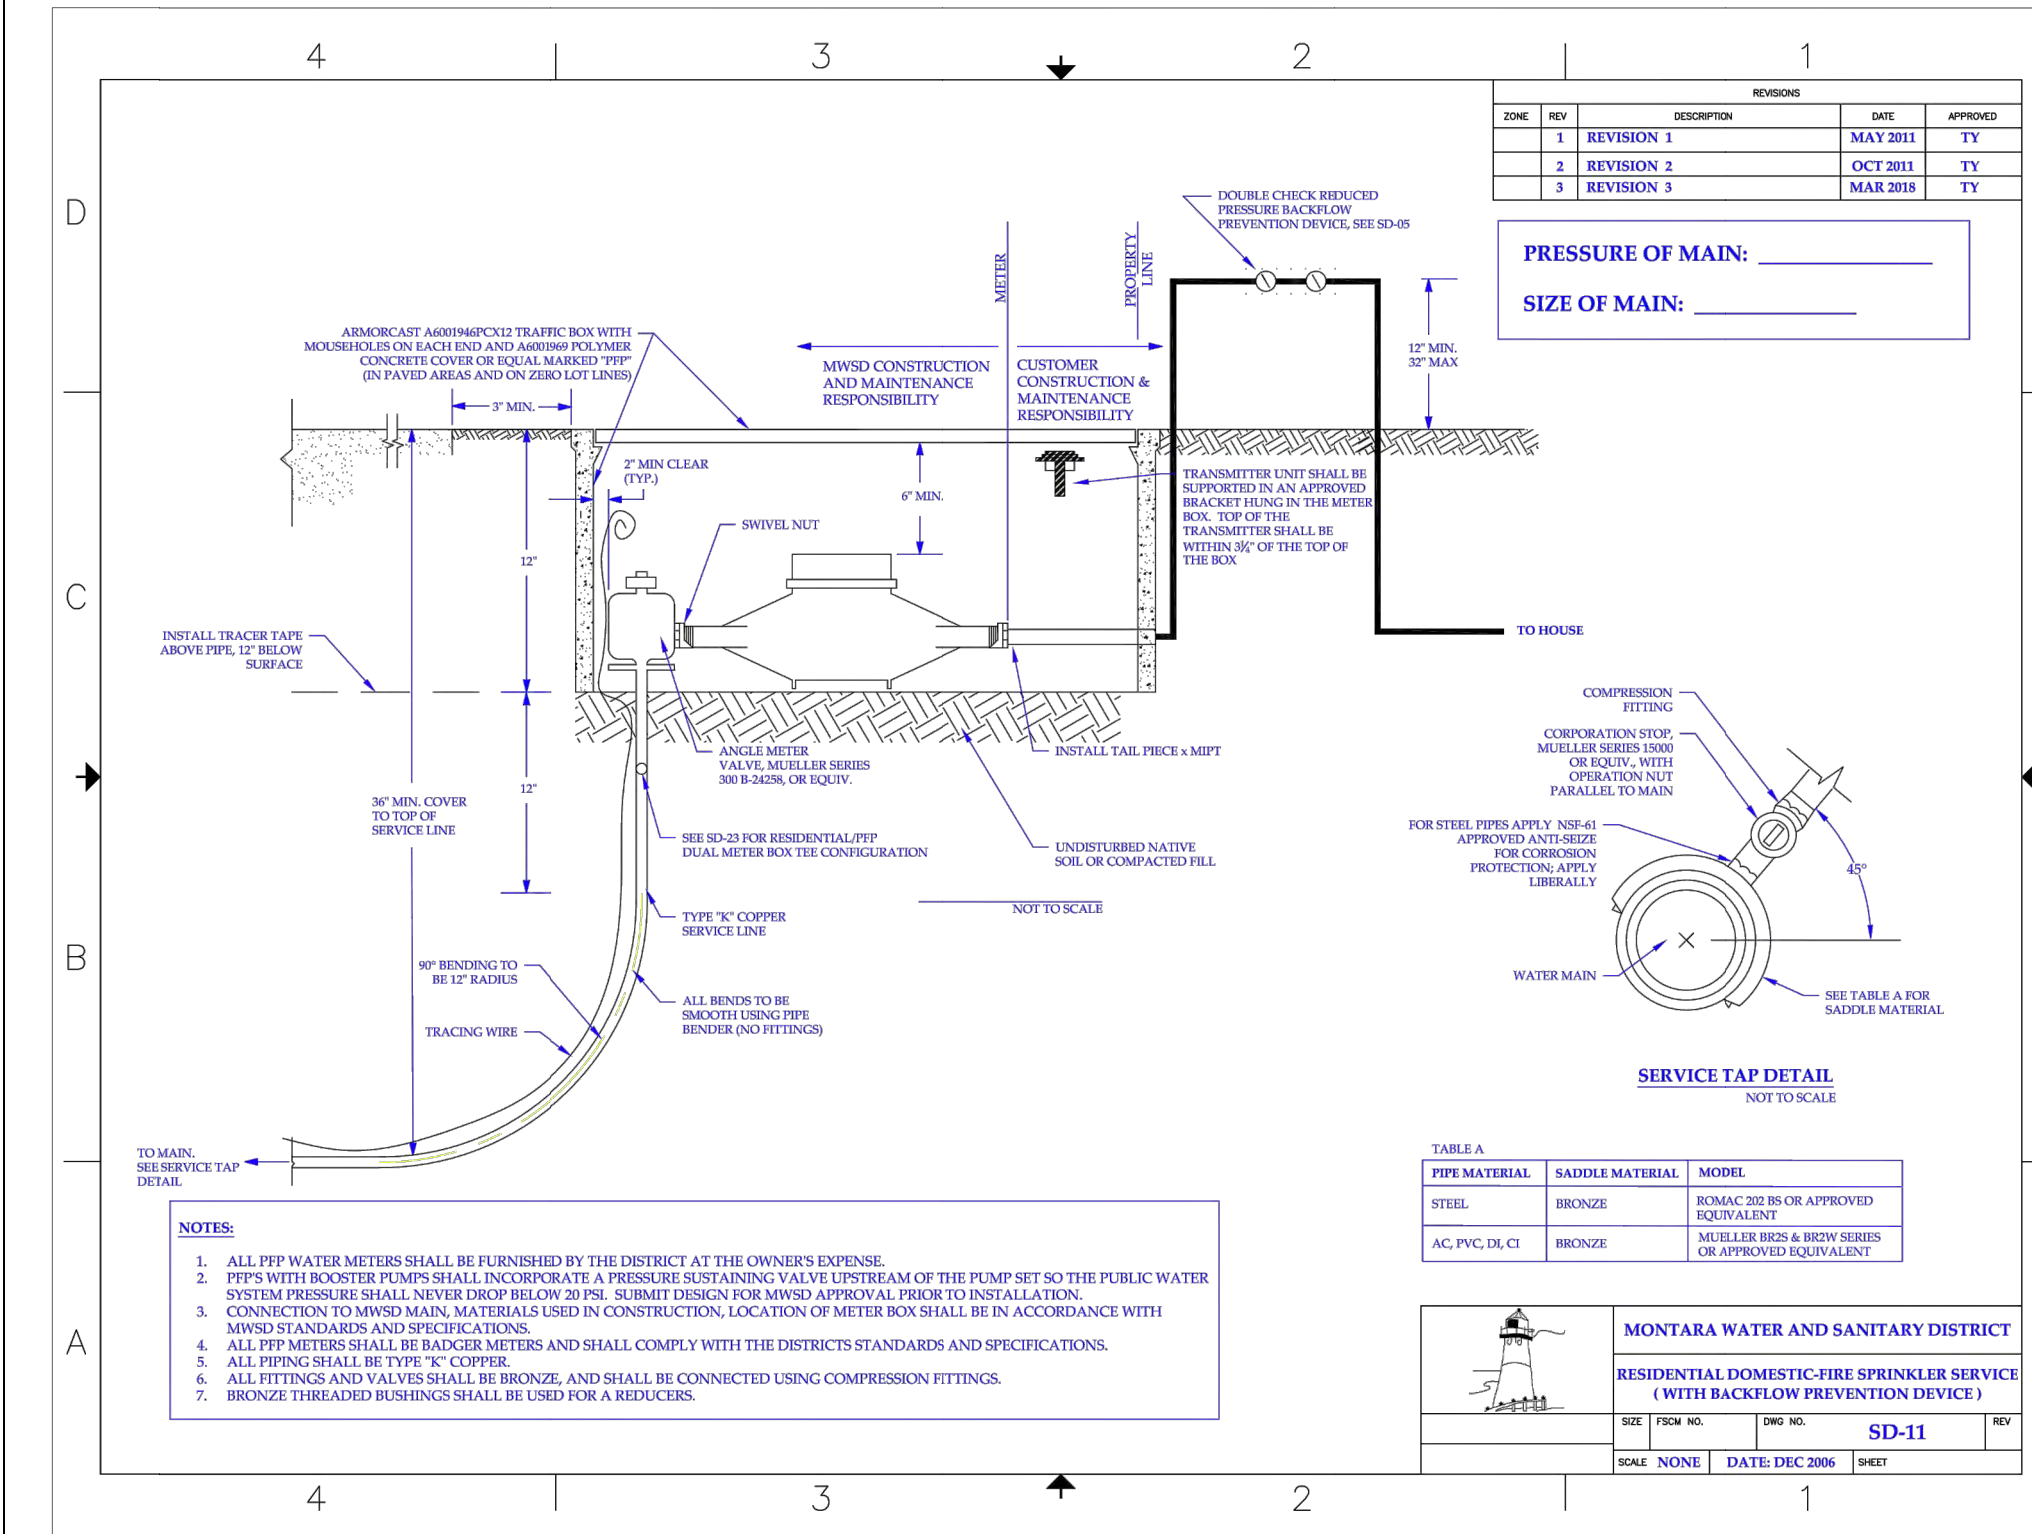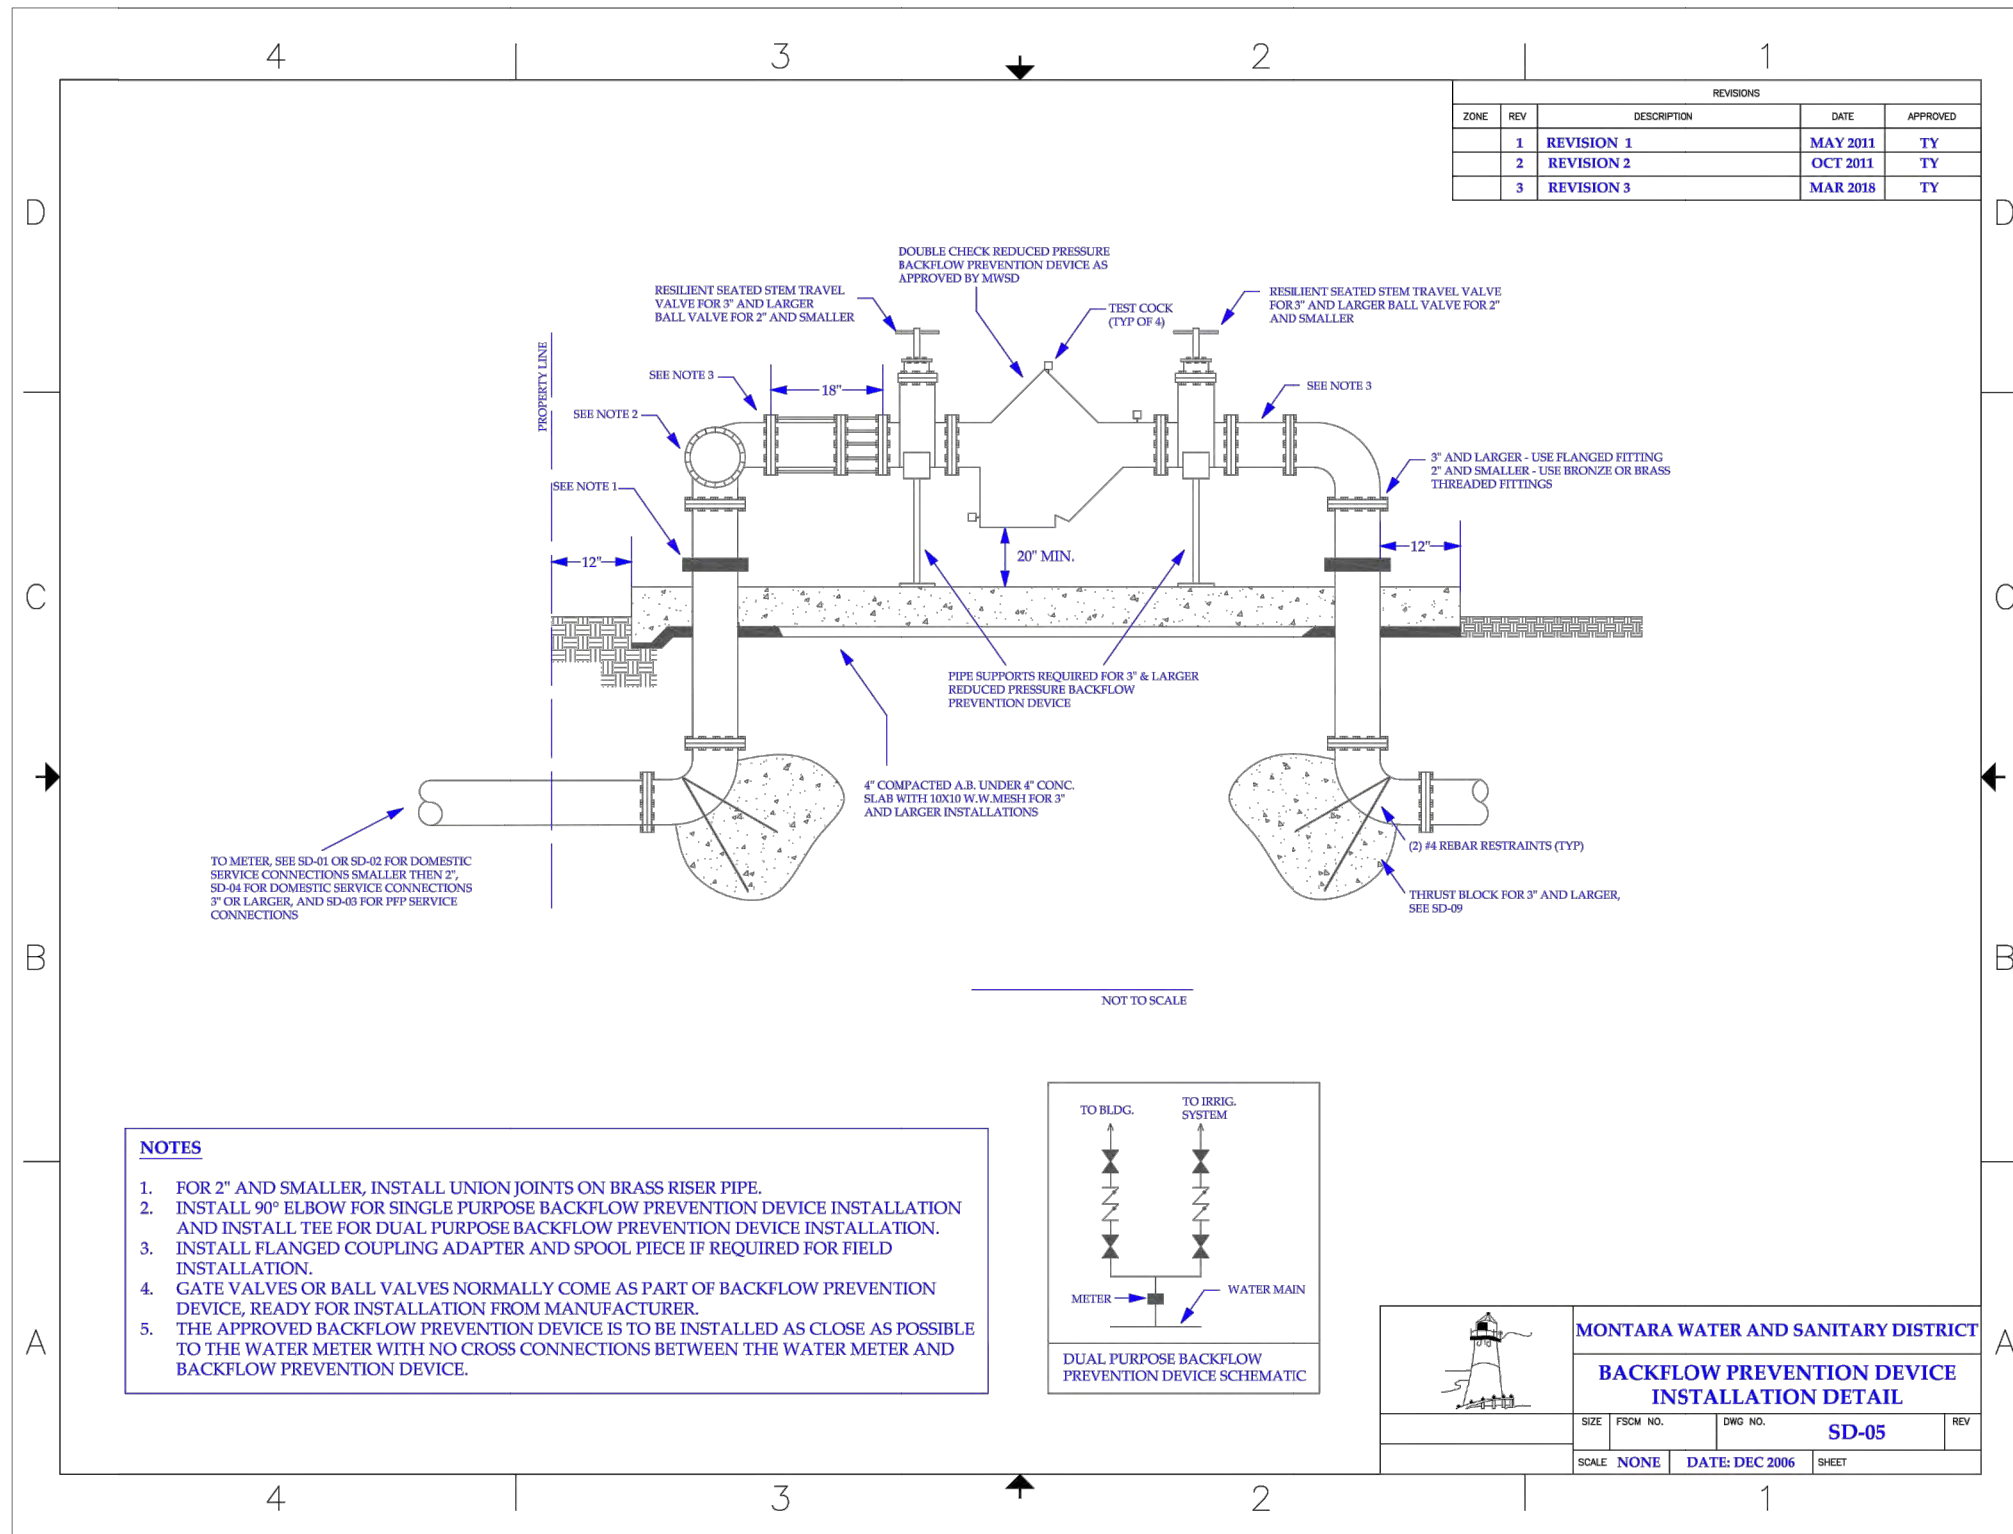




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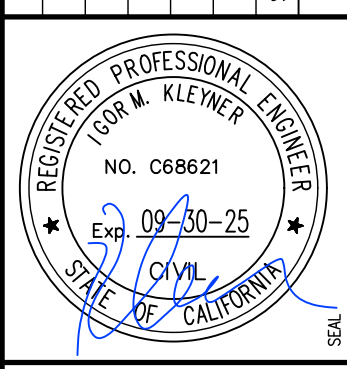
WATER SERVICE
DETAILS

DATE	FEBRUARY 2023
SCALE	AS SHOWN
DESIGN	IK
DRAWN	IK
PROJECT#	23001
SHEET	13 of 15

C4.0



SYMBOL	DESCRIPTION	DATE	APPROVED
B	NEW SITE PLAN	03-03-24	IK
A	FOR REVIEW	02-21-23	IK

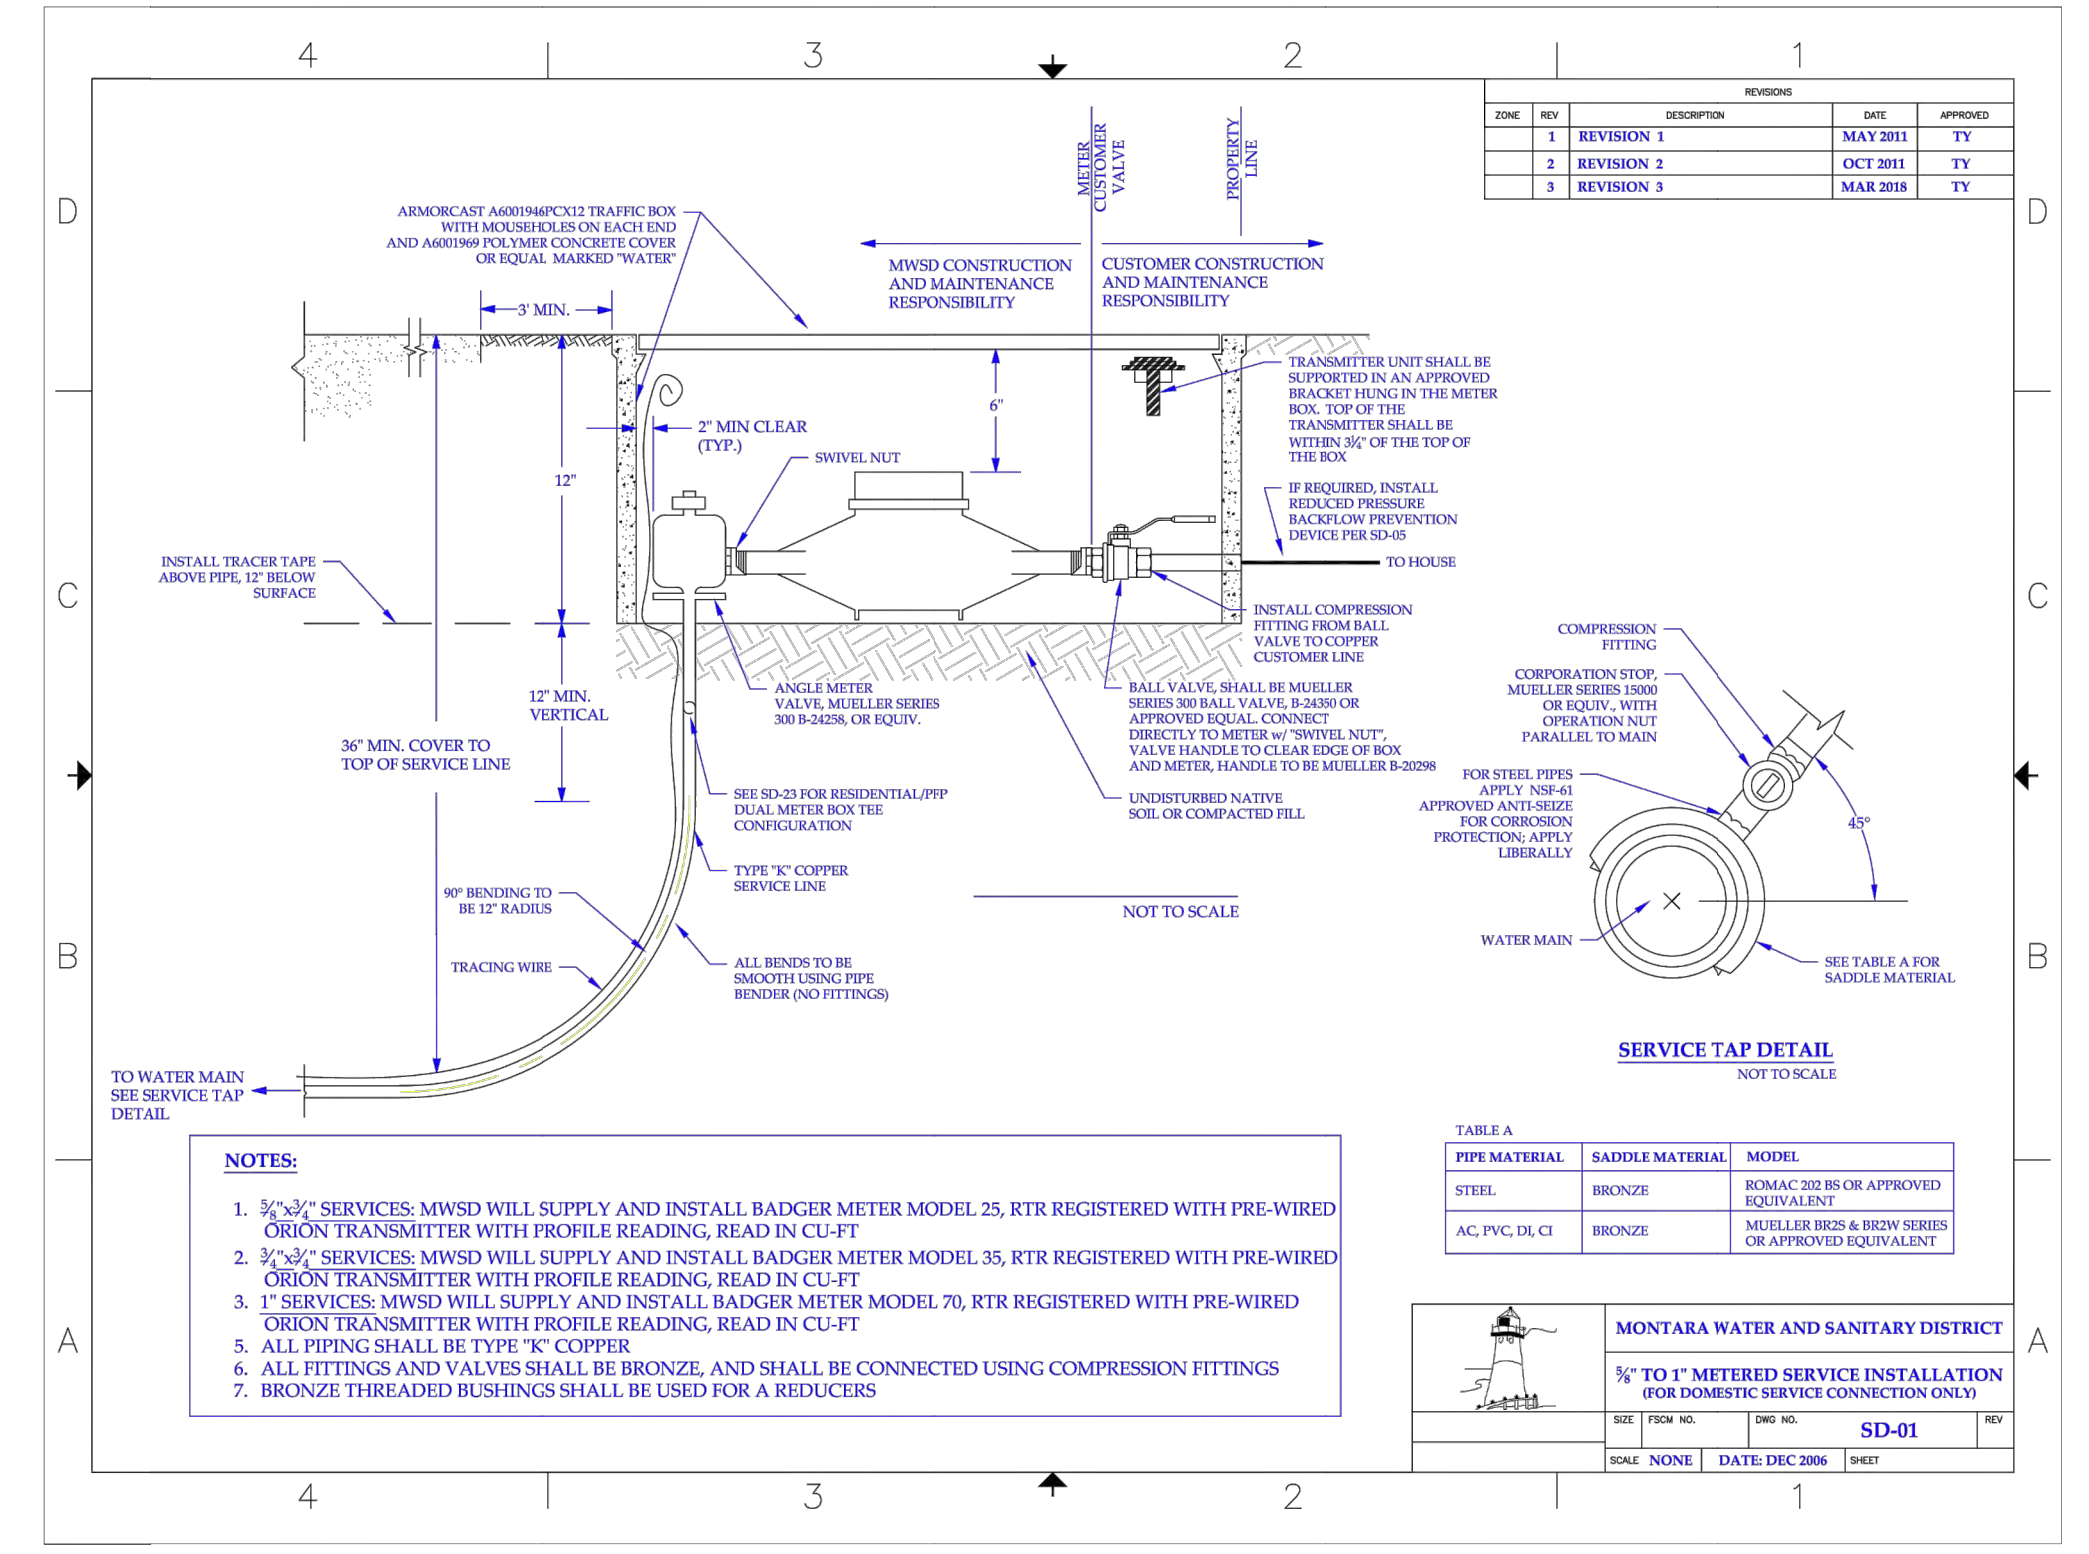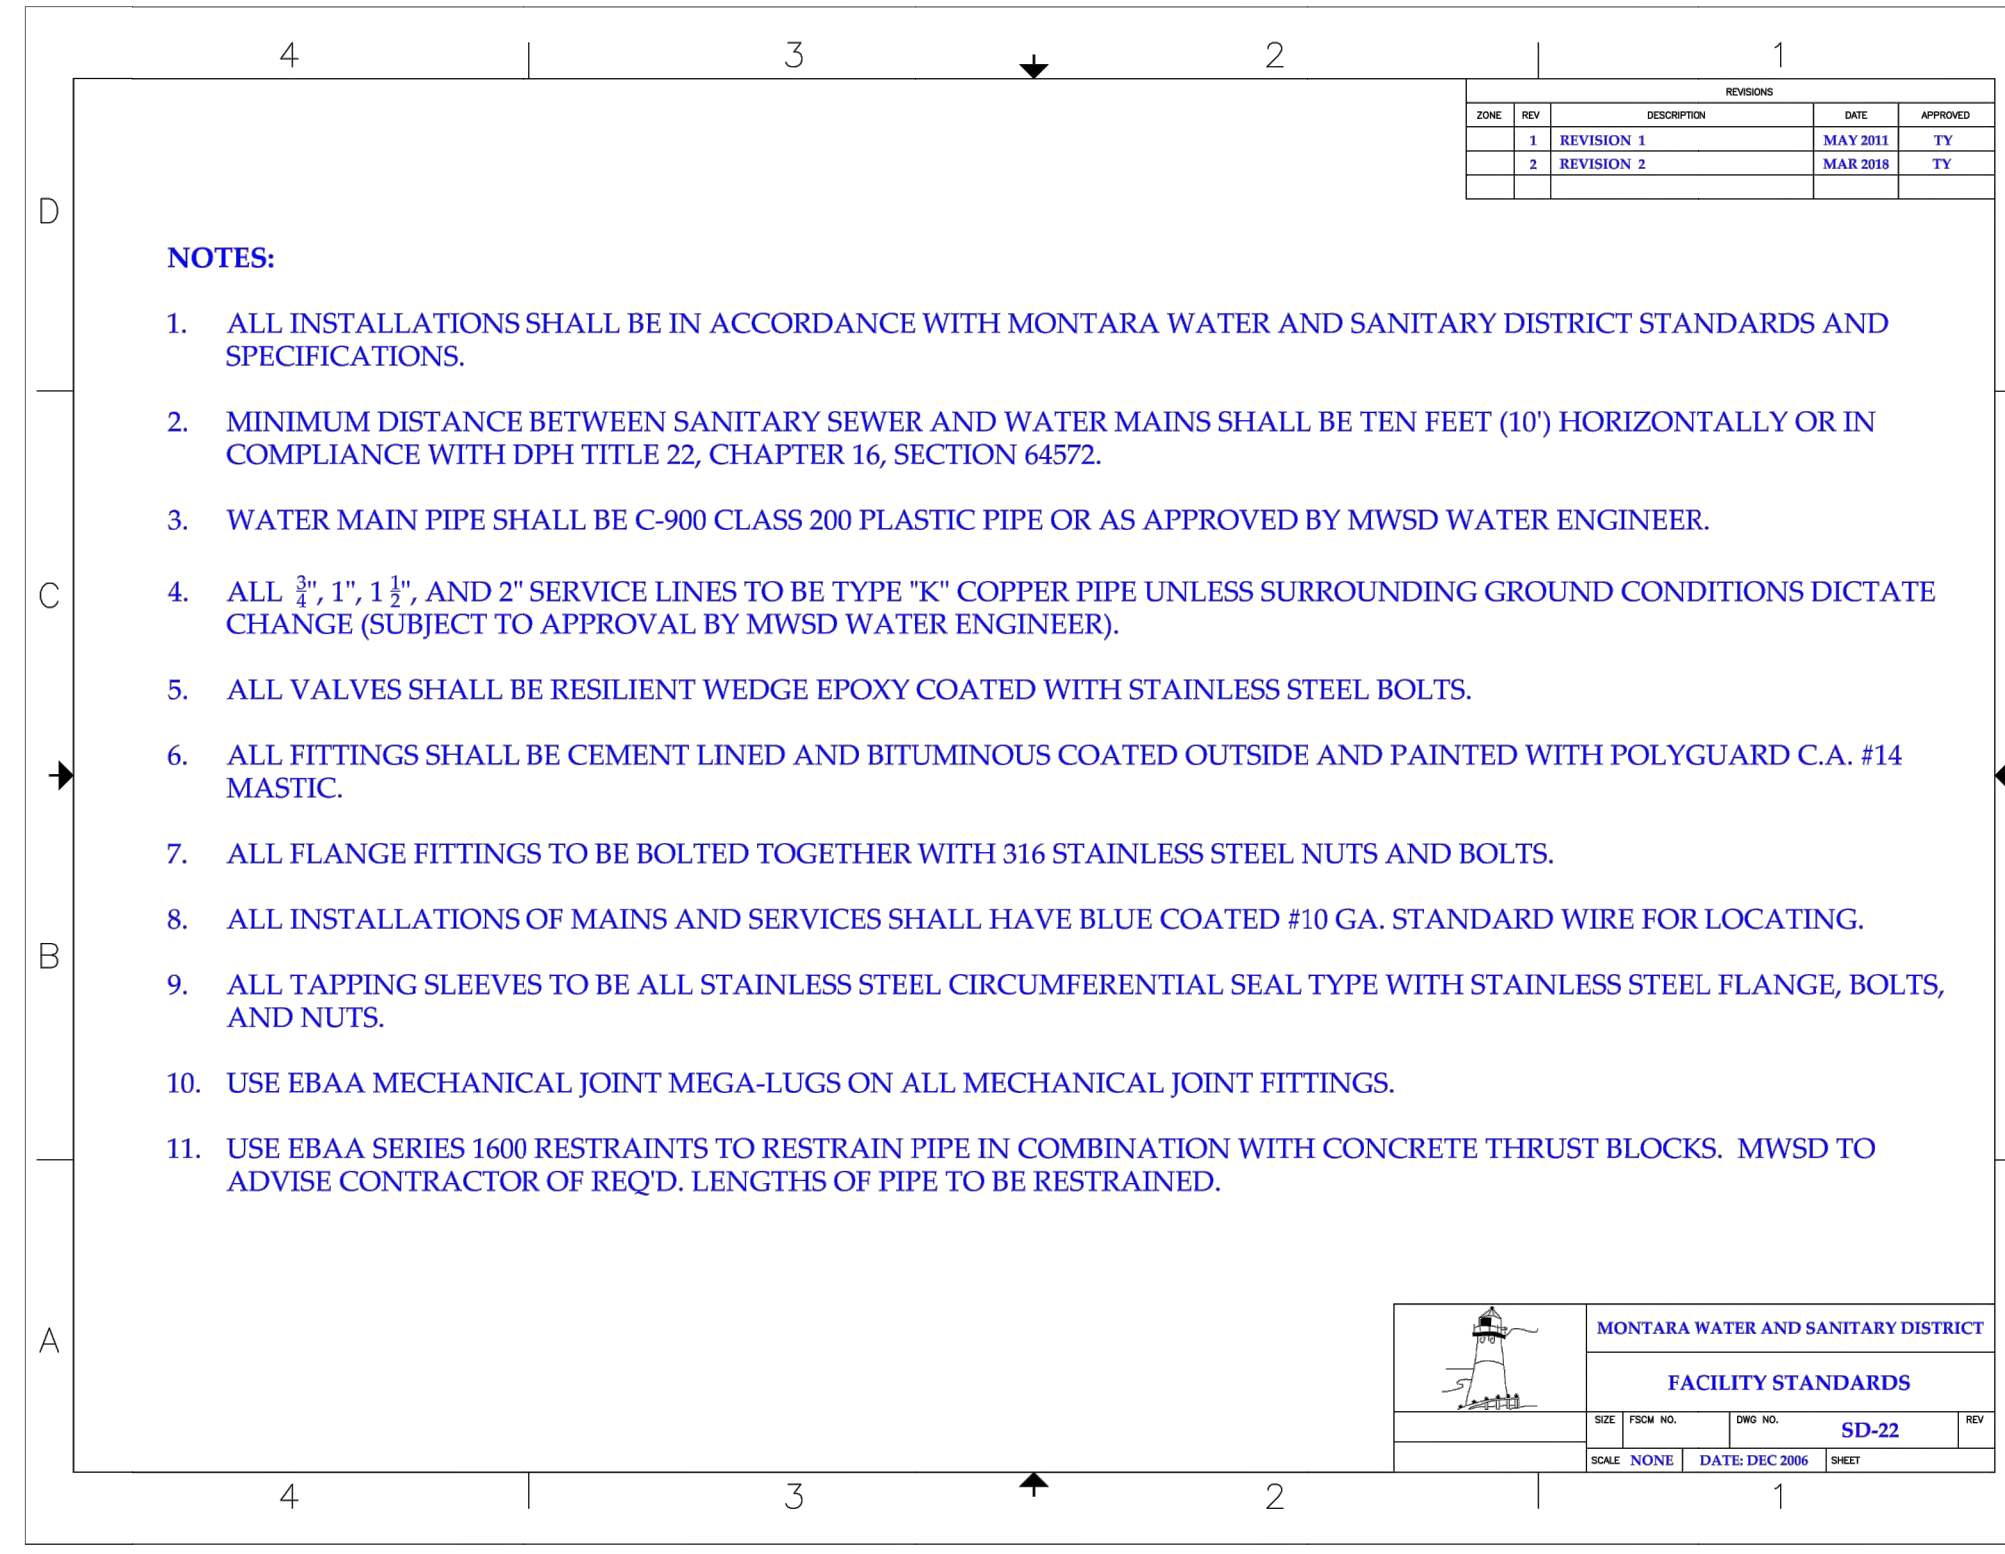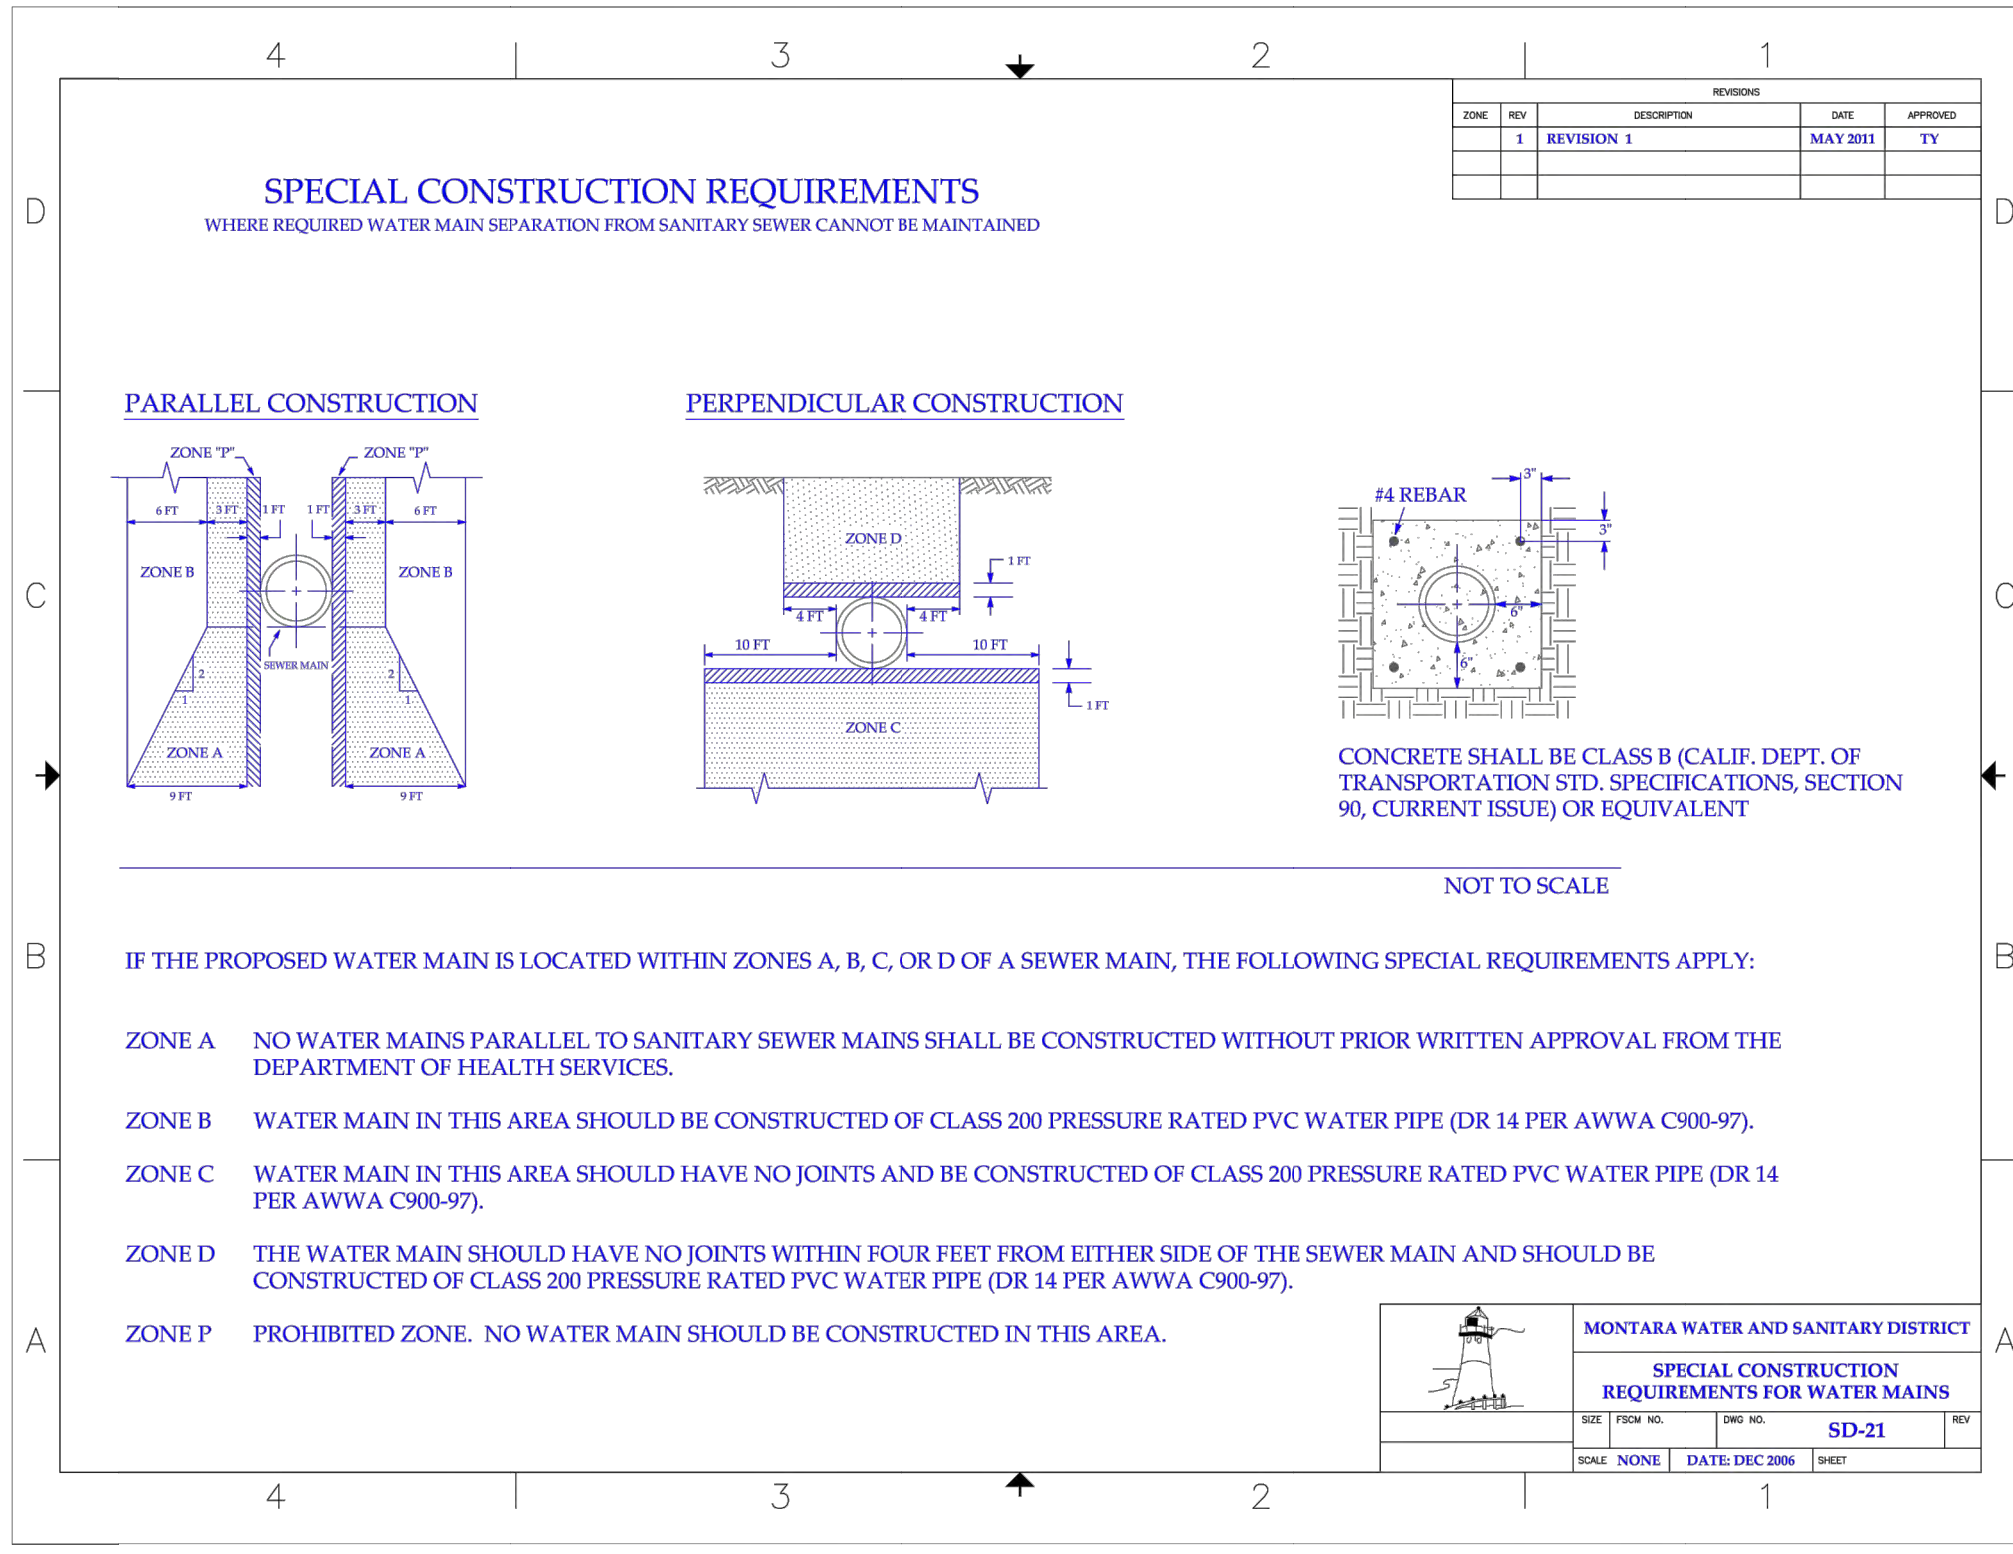



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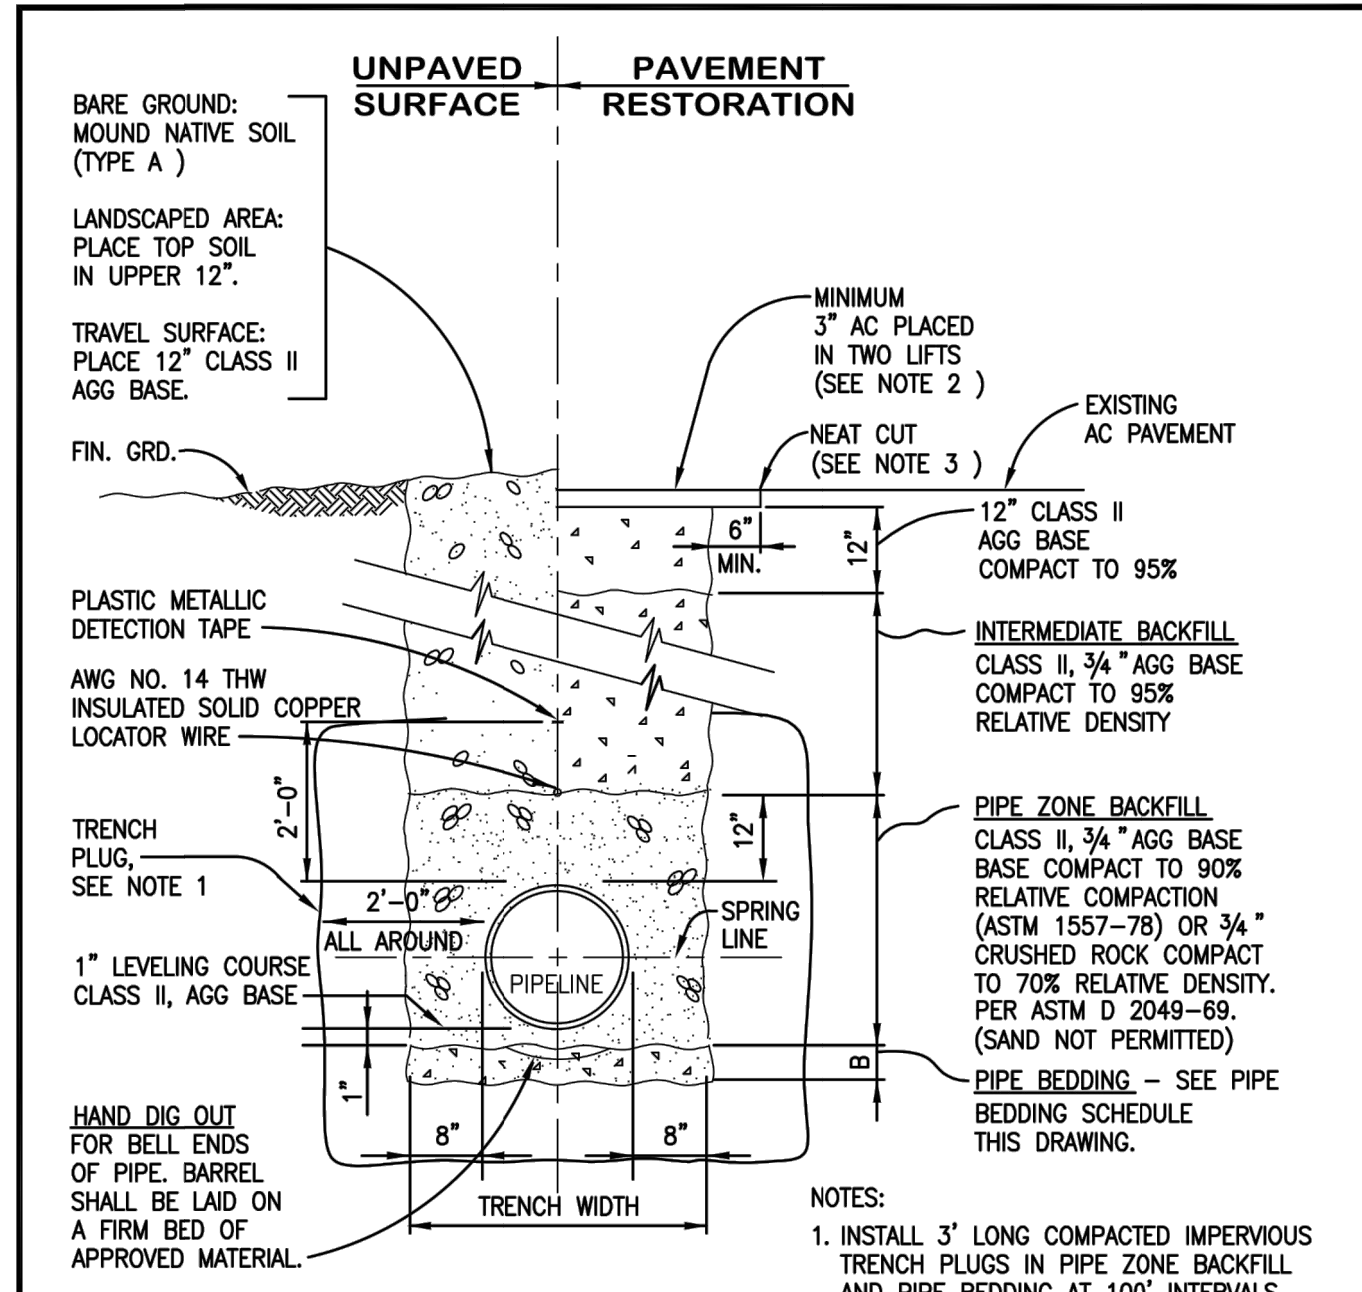
WATER SERVICE DETAILS

DATE	FEBRUARY 2023
SCALE	AS SHOWN
DESIGN	IK
DRAWN	IK
PROJECT#	23001
SHEET	14 OF 15

C4.1




MONTARA WATER & SANITARY DISTRICT
BAY MUD TRENCH DETAIL
2017 SD 4.1

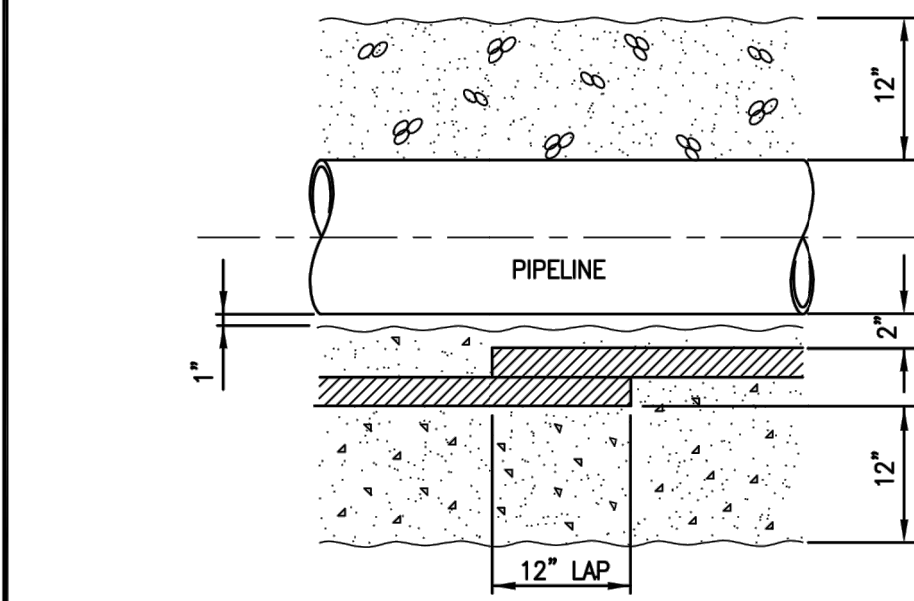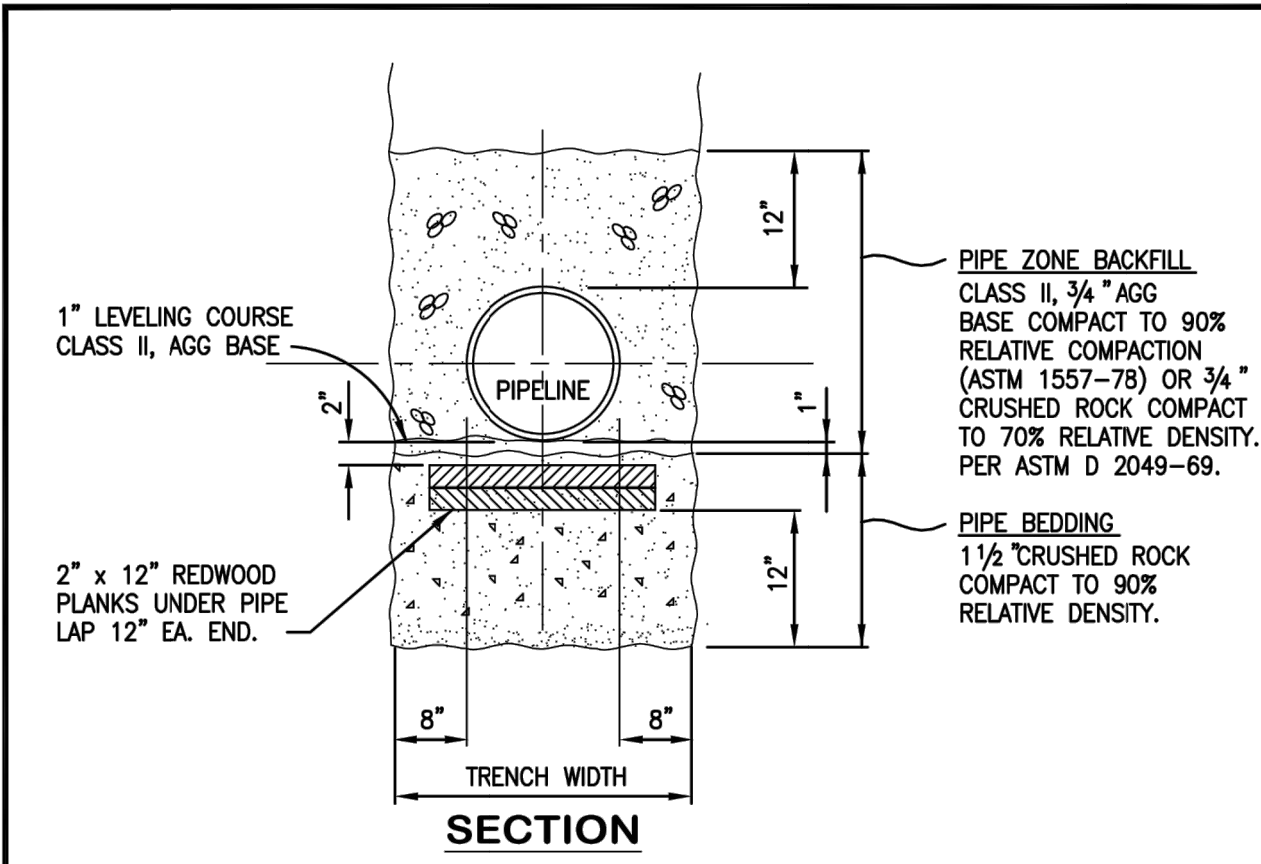


PIPE BEDDING SCHEDULE

TRENCH MATERIAL	BEDDING DEPTH - B	BEDDING MATERIAL
SOIL - DRY	6"	3/4" CRUSHED ROCK OR CLASS II, AGG BASE
SOIL W/ WATER	12"	1 1/2" CRUSHED ROCK
ROCK OR HARD PAN - DRY	6"	3/4" CRUSHED ROCK OR CLASS II AGG BASE
ROCK OR HARD PAN W/ WATER	6"	1 1/2" CRUSHED ROCK
BAY MUD	SEE BAY MUD TRENCH DETAIL DRAWING SD 4.1	


MONTARA WATER & SANITARY DISTRICT
TYPICAL TRENCH SECTION
2017 SD 4.0

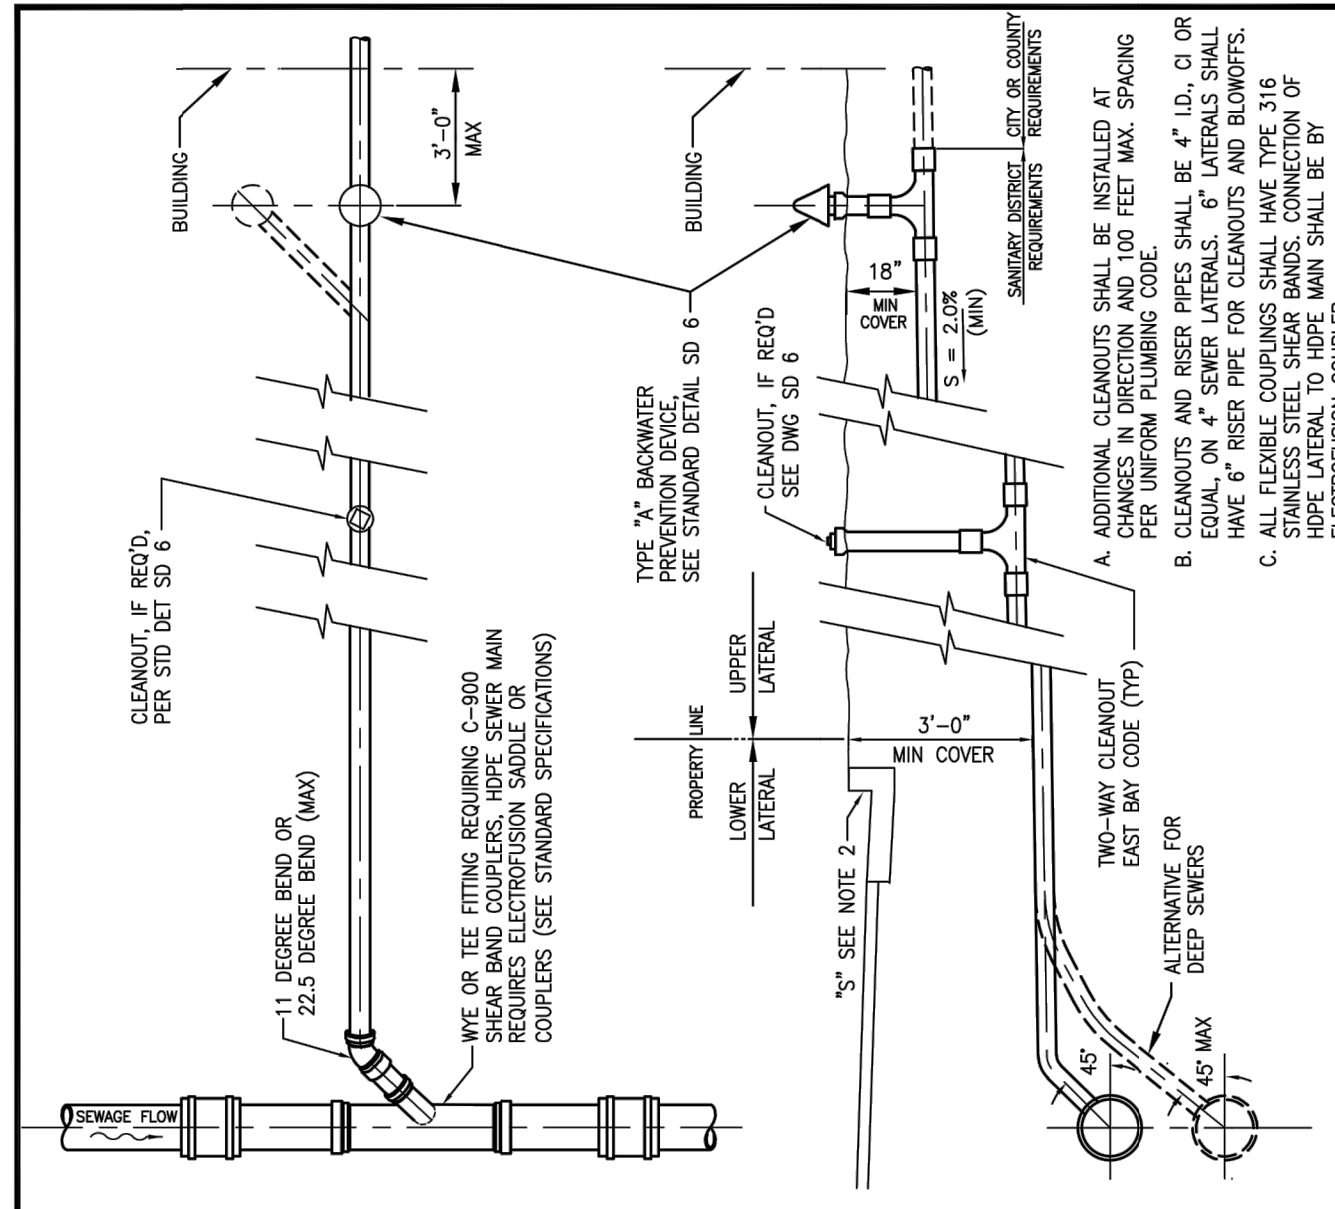


MONTARA WATER & SANITARY DISTRICT
TYPICAL SIDE SEWER DETAILS
2017 SD 5

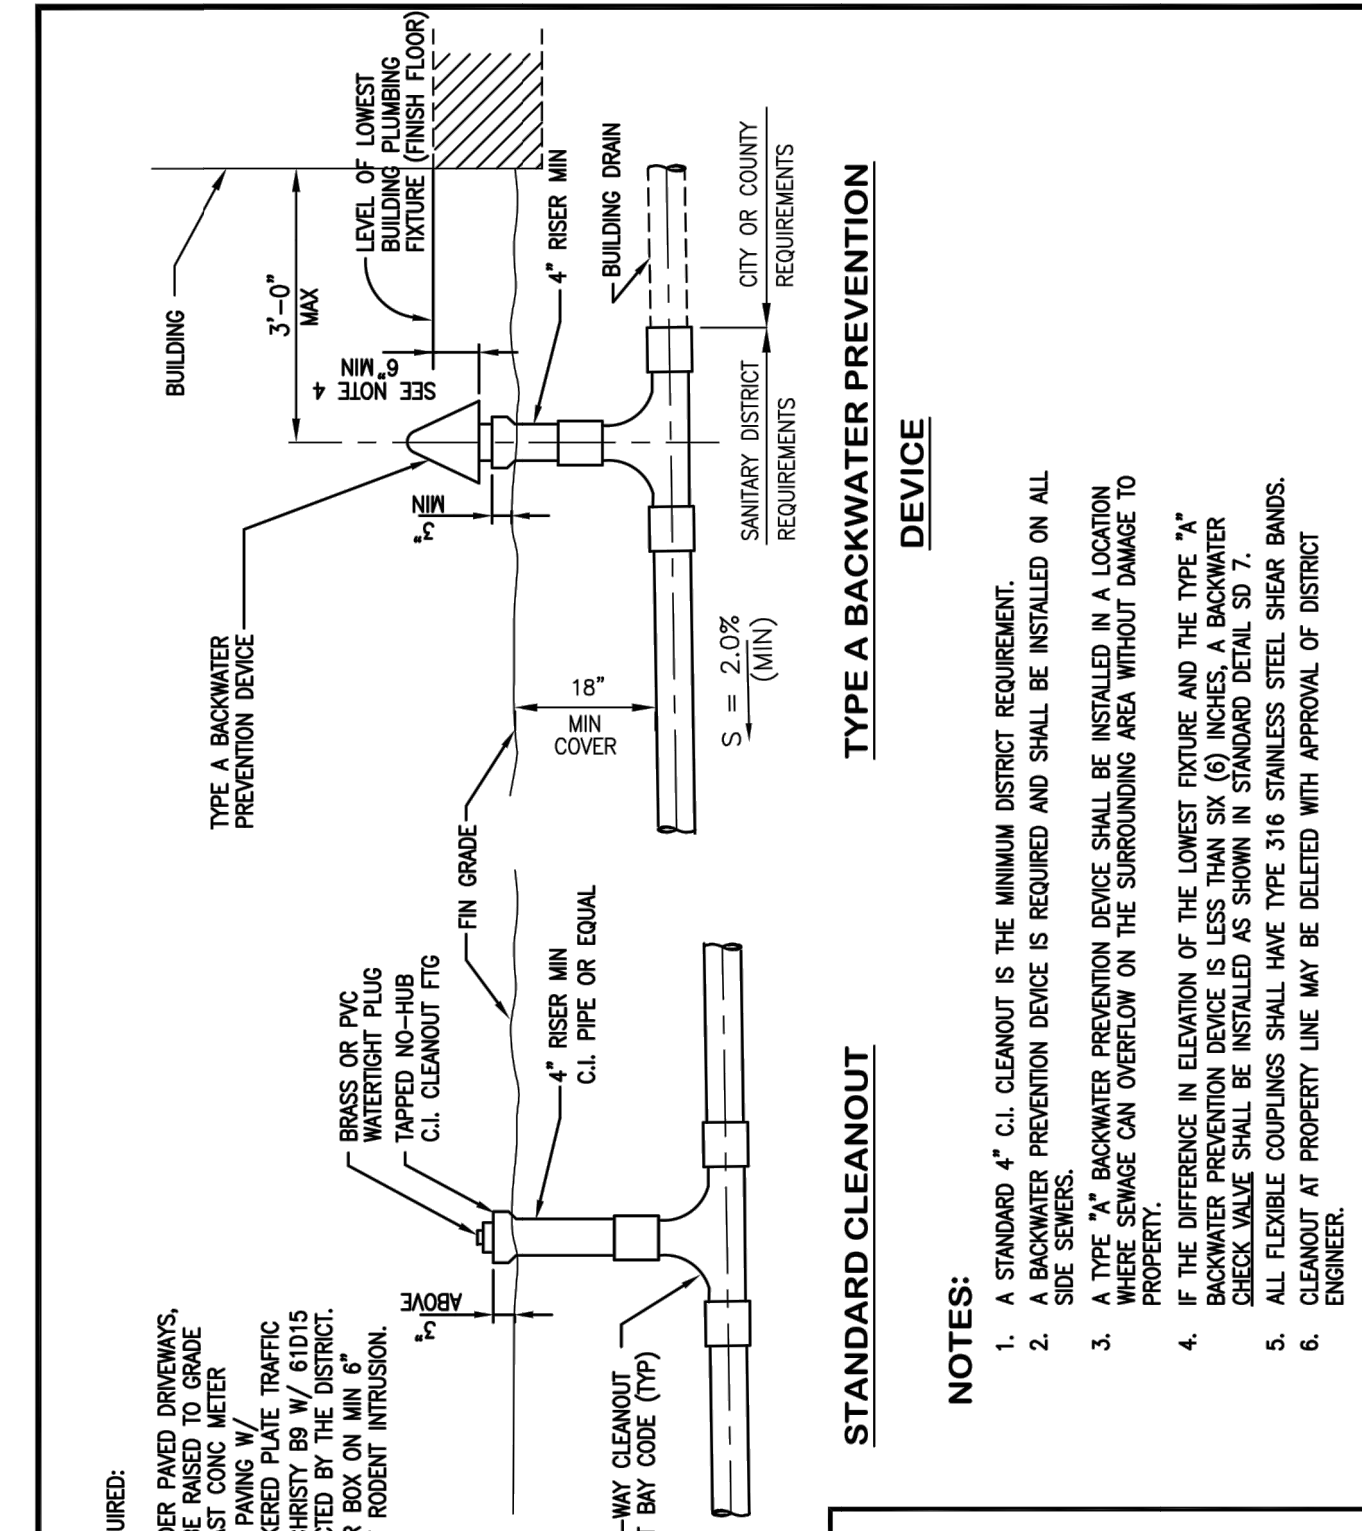


MONTARA WATER & SANITARY DISTRICT
STANDARD CLEANOUT AND BACKWATER PREVENTION DEVICE
2017 SD 6

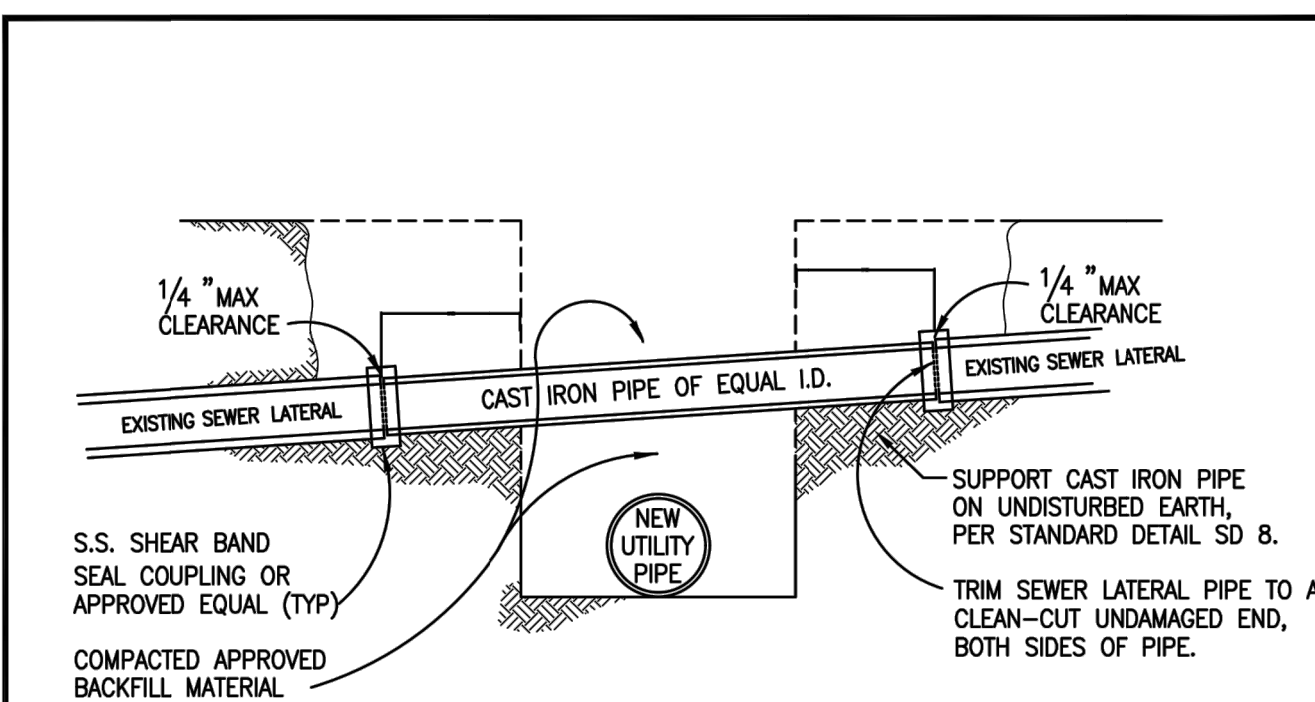


MONTARA WATER & SANITARY DISTRICT
SEWER LATERAL PROTECTION ABOVE UTILITY CROSSING
2017 SD 10.0

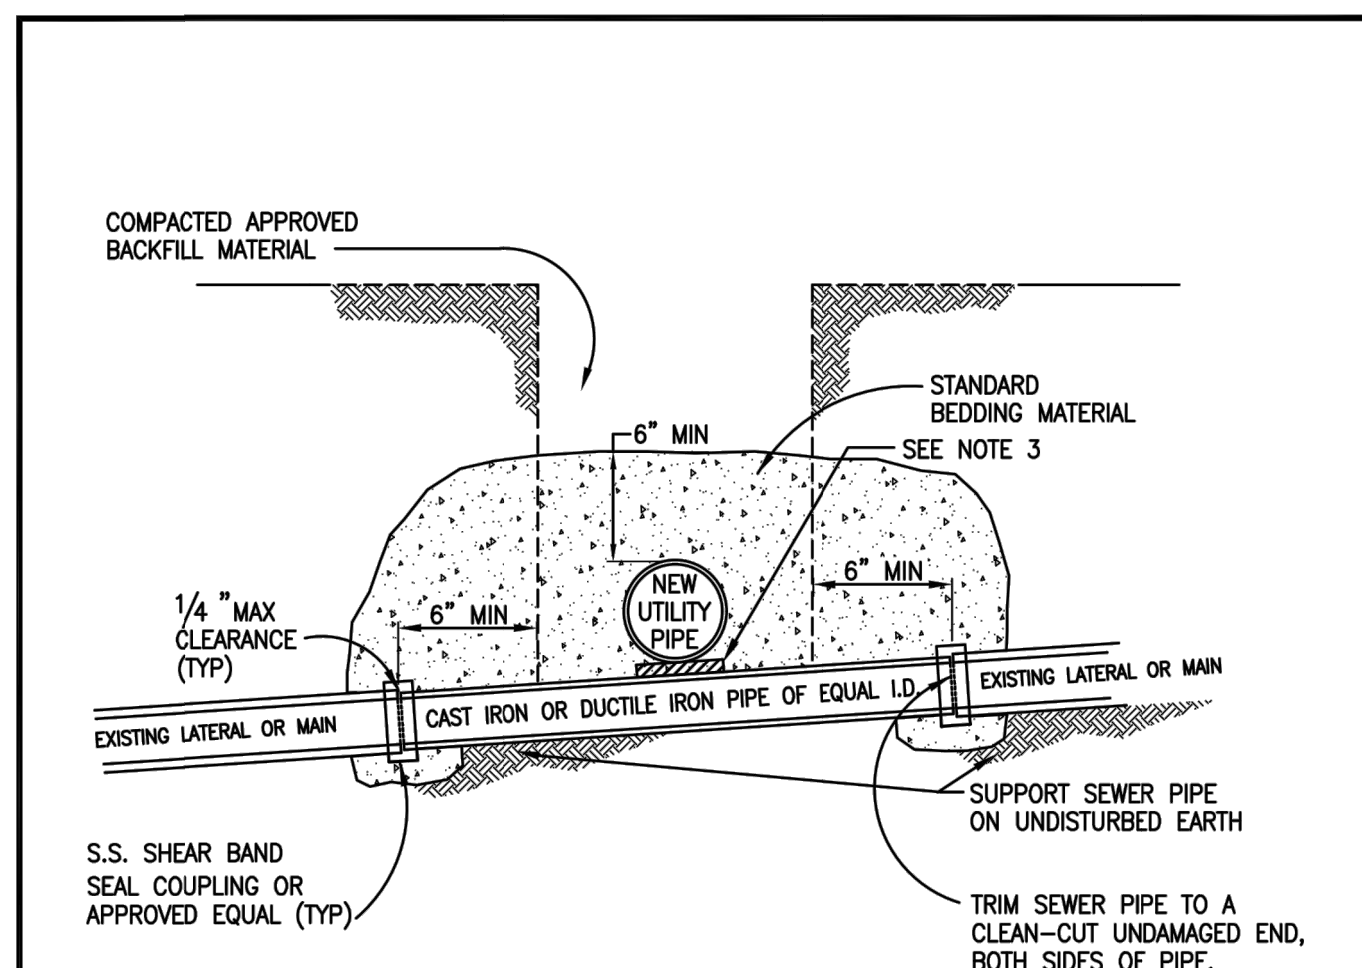

MONTARA WATER & SANITARY DISTRICT
SEWER PIPE PROTECTION BELOW UTILITY CROSSING
2014 SD 11

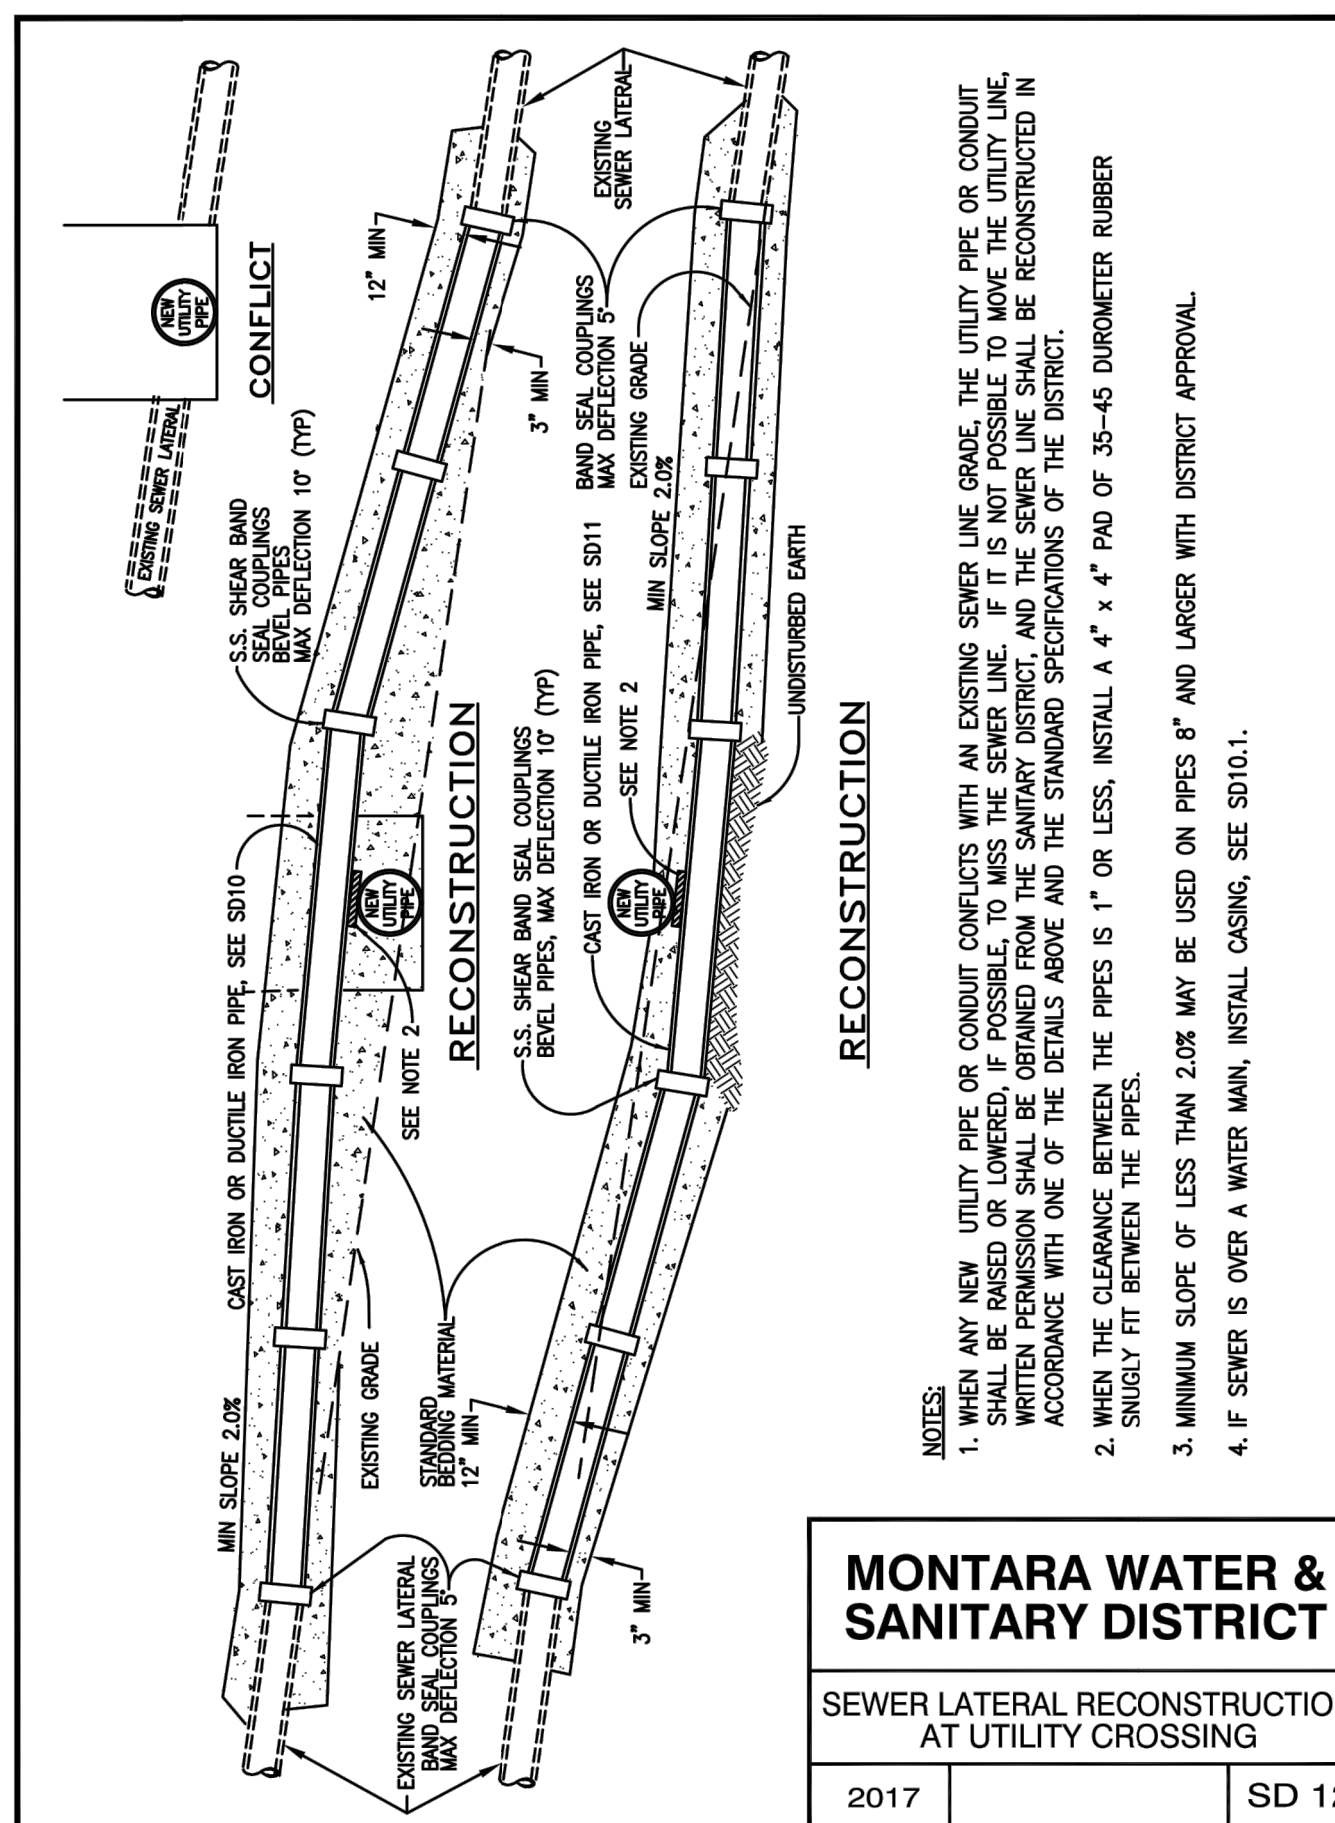

MONTARA WATER & SANITARY DISTRICT
SEWER LATERAL RECONSTRUCTION AT UTILITY CROSSING
2017 SD 12

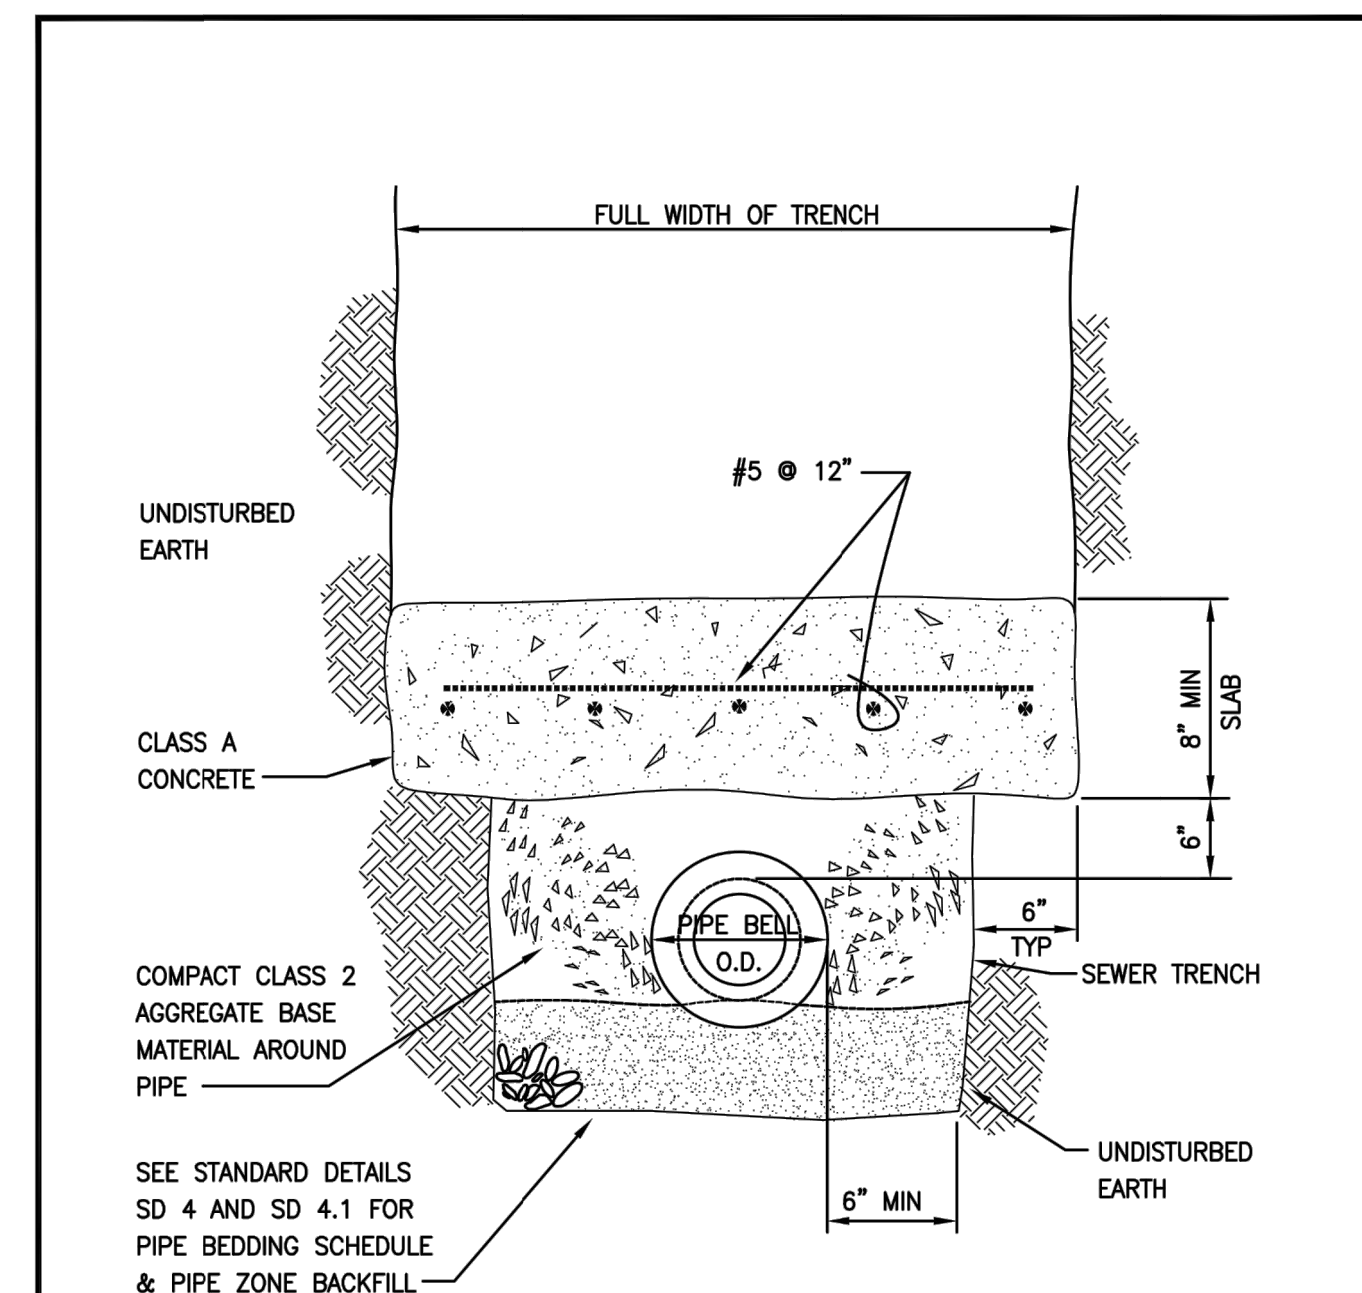

MONTARA WATER & SANITARY DISTRICT
STANDARD CONCRETE PIPE PROTECTION
2017 SD 13

SYMBOL	DESCRIPTION	DATE	APPROVED



MODERN TECHNOLOGY RESOURCES INC.
415.602.2290

700 GEORGE ST @ BIRCH ST
MONTARA, CA 94037
APN: 036-103-620

SEWER LATERAL DETAILS

DATE	FEBRUARY 2023
SCALE	AS SHOWN
DESIGN	IK
DRAWN	IK
PROJECT	23001
SHEET	15 OF 15

C5.0